

# #2015-49 113 N. Crystal Beach Ave (Thinnes)—Variation Project Review for Planning and Zoning Commission

Meeting Date: October 7, 2015

**Request:** Variations from Article 3-200, Article 7-200(B) and Article 7-

300(B)(4) for an existing front porch and an enlargement of a nonconforming structure that does not meet the minimum front yard setback, to allow a 14.16-foot encroachment and a second

story addition.

**Location:** 113 N. Crystal Beach Ave

**Acreage:** 6,500 square feet

**Existing Zoning:** R-2 (Single Family Residential)

**Surrounding Properties:** North: R-2 (Single Family Residential)

South: R-2 (Single Family Residential)
East: R-2 (Single Family Residential)
West: R-2 (Single Family Residential)

**Staff Contact**: Kathryn Cowlin (815.356.3798)

#### **Background:**

- Existing Use: The property is currently improved with a single-family home and an existing front porch. The existing home is two-stories and the second story presently has a smaller footprint than the first floor.
- <u>Background</u>: The petitioner would like to add onto the second story. The existing first floor of the principal structure encroaches 4.16 feet into the required front yard setback. The existing front porch encroaches an additional 10 feet into the front yard setback. The second story addition would increase the volume of the encroachment in the front yard setback.
- <u>UDO Requirements</u>: The minimum front yard setback for an established neighborhood and nonconforming lot is the average existing front yard setback of the dwellings on the two closest lots, which is 24 feet.

#### **Development Analysis:**


#### General

• Request: The petitioner is requesting a variation to allow a 14.16-foot encroachment into the 24-foot front yard setback for a second story addition and an existing front porch.

- <u>Land Use</u>: The land use map shows the area as Urban Residential. This land use designation is appropriate for this use.
- Zoning: The site is zoned R-2 (Single Family Residential).

#### Site Layout

- The required front yard setback is 24 feet.
- The principal structure currently encroaches 4.16 feet into the front yard setback.
- The existing front porch currently encroaches an additional 10 feet into the front yard setback.
- The proposed second story addition is within the same footprint of the existing principal structure.
- The proposed second story addition would increase the volume of the nonconformity since the existing principal structure is located within the required front yard setback.

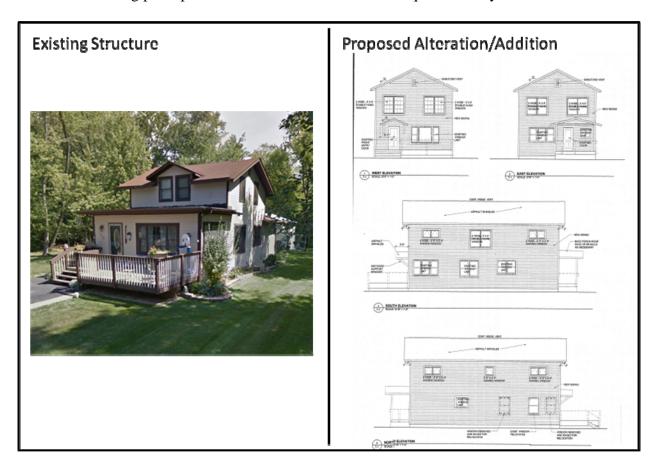

#### **Comprehensive Land Use Plan 2030 Vision Summary Review:**

The Comprehensive Plan designates the subject property as Urban Residential, which allows for existing and future single-family residential uses. The following goal is applicable to this request:

#### Land Use - Residential

Goal: Encourage a diversity of high quality housing in appropriate locations throughout the city that supports a variety of lifestyles and invigorates community character.

This can be accomplished with the following supporting action:

**Supporting Action:** Preserve and enhance the character and livability of existing residential area with architectural and development guidelines. Promote safe, clean and well-maintained housing by encouraging regular repair and maintenance of housing.

#### **Findings of Fact:**

#### ZONING ORDINANCE VARIATION

The petitioner is requesting a variation from Article 3-200, Article 7-200(B) and Article 7-300(B)(4) for an existing front porch and an enlargement of a nonconforming structure that does not meet the minimum front yard setback, to allow a 14.16-foot encroachment and a second story addition. The Unified Development Ordinance lists specific standards for the review and approval of a variation. The granting of a variation rests upon the applicant proving practical difficulty or hardship caused by the Ordinance requirements as they relate to the property. To be considered a zoning hardship, the specific zoning requirements; setbacks, lot width and lot area must create a unique situation on this property. It is the responsibility of the petitioner to prove hardship at the Planning and Zoning Commission public hearing.

#### Standards

When evidence in a specific case shows conclusively that literal enforcement of any provision of this Ordinance would result in a practical difficulty or particular hardship because:

a.	surroundings or co	property owner is due to unique circumstances, such as, unusual conditions of the property involved, or by reason of exceptional wness or shape of a zoning lot, or because of unique topography, or tions.		
	Meets	Does not meet		
b.	Also, that the variation, if granted, will not alter the essential character of the locality.			
	Meets	Does not meet		
consider	ration the extent to	ementing the above standards, the Commission may take into which the following facts favorable to the application have been presented at the public hearing:		
a.		s upon which the application for variation is based would not be y to other property within the same zoning classification;		
	☐ Meets	Does not meet		
b.	That the alleged di having interest in th	ifficulty or hardship has not been created by any person presently ne property;		
	Meets	Does not meet		

c.	That the granting of the variation will not be detrimental to the public welfare or injurious to other property or improvements in the neighborhood in which the property is located; or				
	☐ Meets ☐ Does not meet				
d.	That the proposed variation will not impair an adequate supply of light or air to adjacent property, will not unreasonably diminish or impair the property values of adjacent property, will not unreasonably increase congestion in the public streets, substantially increase the danger of fire or otherwise endanger public safety.				
	☐ Meets ☐ Does not meet				

Where the evidence is not found to justify such conditions, that fact shall be reported to the City Council with a recommendation that the variation be denied.

#### **Recommended Conditions:**

If a motion to recommend approval of the petitioner's request is made, it should be with the following conditions:

- 1. Approved plans, reflecting staff and advisory board recommendations, as approved by the City Council:
  - A. Application (Thinnes, received 08/31/15)
  - B. Plan Set (Korte Architecture, received 08/12/15)
  - C. Survey (RLS, dated 07/24/01, received 08/31/15)
- 2. The architectural style of the addition shall be complementary to the principal structure.
- 3. The petitioner shall address all of the review comments and requirements of the Fire Rescue and Community Development Departments.

2015 49

# **Application for Simplified Residential Variation**

Applica	ation Number:		FOR OFFICE USE ONLY
Date o	f Submission:		
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City		State	GOO14 Zip Code
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E.	Owner of Property (if	different	
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Name			
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II.	Project Data		
l.	a. Location/Addres	s: 113 N. Crystel B	each que
		1-226-004	
	b. PIN #: <i>\8-0</i>	7- 33-0 207	
<u>2</u> .	Description of proposal/f	Reason for request (including h	now the standards for variation are met,
	any unique circumstance	e of the property, or particular h	nardship):
	DESCRIBE THE UNIQU	E CIRCUMSTANCES OF THE	PROPERTY:
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WILL THE VARIATION ALTER THE ESSENTIAL CHARACTER C	OF THE LOCALITY?
4	OF THE LOCALITY?
WILL THE VARIATION, IF GRANTED BE DETRIMENTAL TO PU	IBLIC WELFARE OR
INJURIOUS TO OTHER PROPERTY?	IDEIC WELFARE OR
WILL THE VARIATION AS PROPOSED IMPAIR ADEQUATE SU	PPLY OF LIGHT OR AIR TO
ADJACENT PROPERTY; DIMINISH PROPERTY VALUE; INCRE	ASE CONGESTION IN
PUBLIC STREETS; SUSBTANTIALLY INCREASE THE DANGER	R OF FIRE; OT ENDANGER
PUBLIC SAFETY? None of the above	
	<del></del>
List any previous variations that are approved for this property:	1 m 2 /
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Signatures	
	- Carlo
	Community of the second of the
ONER: Print and Sign name (if different from owner)	Date
ONER: Print and Sign name (if different from owner) er of the property in question, I hereby authorize the seeking of the	
	above requested action.

13 1 205 N. K.f.c

#### **PUBLIC NOTICE**

BEFORE THE PLANNING AND ZONING COMMISSION OF THE CITY OF CRYSTAL LAKE, MCHENRY COUNTY, ILLINOIS

IN THE MATTER OF THE APPLICATION OF Richard Thinnes III
LEGAL NOTICE
Notice is hereby given in compliance with the Unified Development ordinance (UDO) of the City of Crystal Lake, Illinois, that a public hearing will be held before the Planning and Zoning Commission of the City of Crystal Lake upon the application of Richard Thinnes III for variations relating to the following described real estate commonly known as 113 N. Crystal Beach Avenue, Crystal Lake, Illinois 60014, Pills 18-01-226-004.
This application is filed for the purpose of seeking zonling variations pursuant to Articles 3-200, 7-200B, and 7-300B 4 of the UDO,

from the minimum front yard sel-back requirements to allow a 4.16-foot encroachment of a second story addition that will be added to the existing nonconforming principal structure, as well as any other variations that may be necessary to complete the project as proposed. Plans for this project can be viewed at the City of Crystal Lake Community Development Department at City Halt.

A public hearing before the Planning and Zoning Commission for this request will be held at 7.30 p.m. on Wednesday September 16, 2015, at the Crystal Lake City Halt, 100 West Woodstock Street, at which time and place any person determining to be heard may be present.

Tom Hayden, Chairperson Planning and Zoning Commission City of Crystal Lake

(Published in the Northwest Herald September 1, 2015) NW 7262





5 201

LOT 4 IN BLOCK 10 NORTH CRYSTAL LAKE PARK BEACH, SECTION 1, TOWNSHIP 43 NORTH, RANGE 7, EAST IN THE COUNTY OF MCHENRY, ILLINOIS.

RECEIVED

VAENOE

# CEXSIAL BEACH

CONKL LH PI ,00'09 ,00'09 ,00.05 FOUND IRON PIPE FOUND IRON PIPE 130.00' 130.00' 130.00 2 STORY FRAME RESIDENCE NO. 113 SO LL' BNITDING TINE SET IRON ROD ,00'09 ,00.05 ,00.09 **PAVEMENT** EDCE

DIMENSIONS OR ANGLES ARE NOT TO ASSUMED FROM SCALING.


JULY 24, 2001

BISHOP & ASSOC. - AUSTIN / MCINTYRE

ORDERED BY


Compare you description and site markings with this plat and AT ONCE report any discrepancies which you may find. 405 MENGE ROAD MARENGO, IL. 60152 (815) 943-5490

# GABLE END VENT 2 WIDE - 3' X 5' DOUBLE HUNG DOUBLE HUNG WINDOW WINDOW - NEW SIDING -EXISTING WINDOW FRONT **ENTRY**

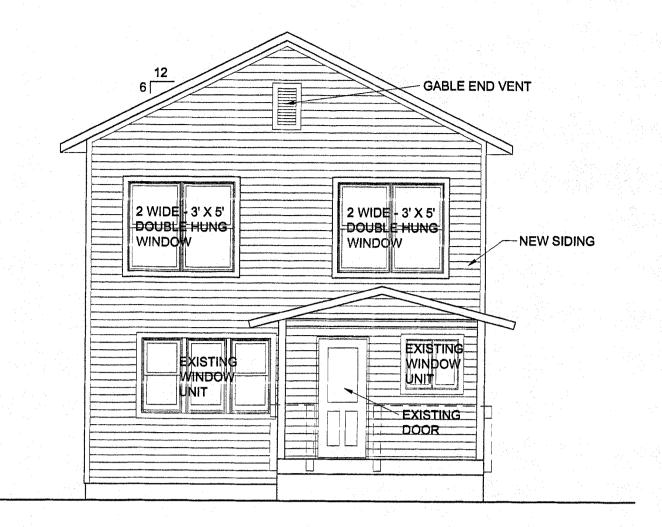


# **WEST ELEVATION** T-1 | SCALE: 3/16" = 1'-0"



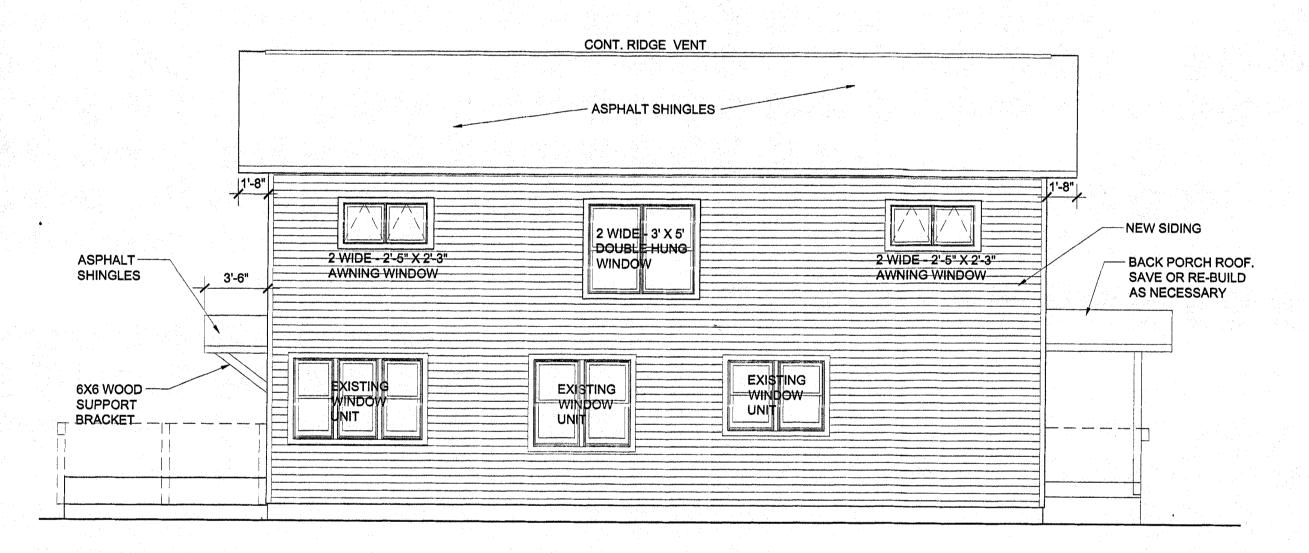




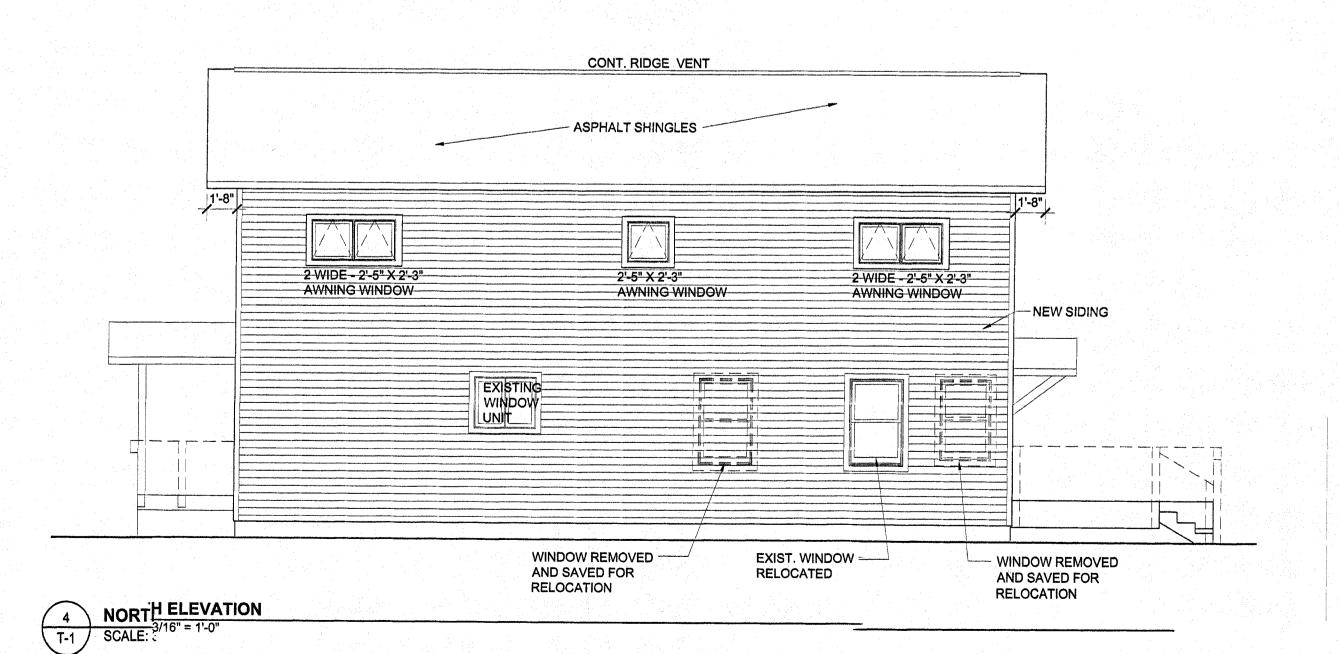


# THINNES RESIDENCE

113 CRYSTAL BEACH AVE

# SECOND FLOOR ADDITION

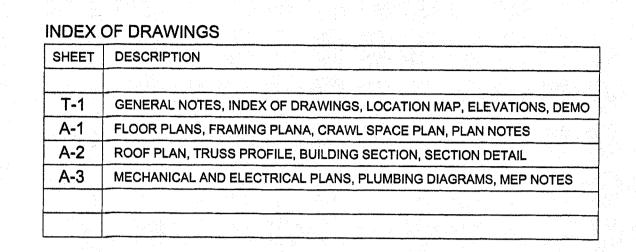

# Project Location: 113 CRYSTAL BEACH AVE

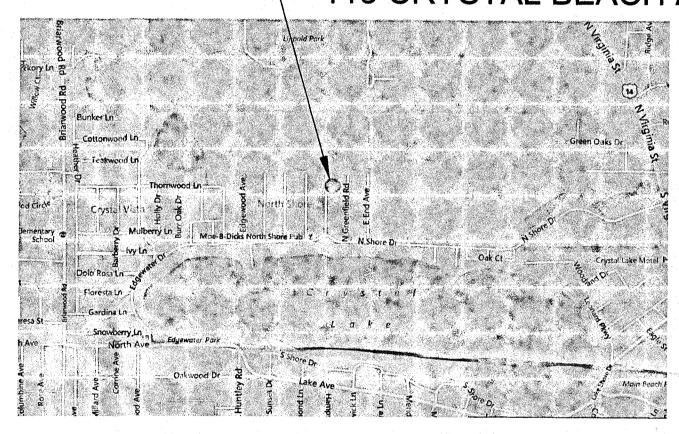

### **GENERAL NOTES**

THESE CONTRACT DOCUMENTS ARE SUBJECT TO THE "GENERAL CONDITIONS OF THE CONTRACT FOR CONSTRUCTION," AIA DOCUMENT A201, 1997 EDITION, EXCEPT AS MAY BE AMENDED BY THE NOTES WHICH ARE PART OF THE CONTRACT DOCUMENTS FOR THIS JOB.

### A. LINES, LEVELS, SURVEYS:

THE CONTRACTOR WILL, WHEN REQUIRED BY THE WORK, USE CURRENT SURVEY INFORMATION PROVIDED BY THE OWNER TO ESTABLISH LINES WITHIN THE CONSTRUCTION AREA. THE CONTRACTOR IS RESPONSIBLE FOR GRADES, ELEVATIONS, AND BENCH MARKS USED DURING CONSTRUCTION.

ALL PERMITS SHALL BE OBTAINED BY THE CONTRACTOR AND PAID FOR BY THE OWNER. THE CONTRACTOR SHALL MAKE TIMELY ARRANGEMENTS FOR ALL REQUIRED INSPECTIONS OF THE WORK...

#### C. GOVERNING MEASUREMENTS AND DIMENSIONS:

DO NOT SCALE THE DRAWINGS. LARGE SCALE DETAILS GOVERN OVER OTHER DRAWINGS AND DETAILS. REVIEW DISCREPANCIES WITH THE ARCHITECT BEFORE PROCEEDING WITH ANY WORK INVOLVING DIMENSIONS WHICH ARE IN DOUBT.

# D. DISCREPANCIES OR OMISSIONS:

1. THE CONTRACTOR SHALL REVIEW ALL CONTRACT DOCUMENTS AND SHALL VISIT THE JOB SITE TO FAMILIARIZE HIMSELF WITH THE EXISTING CONDITIONS. THE CONTRACTOR SHALL NOTIFY THE ARCHITECT IF, AT ANY TIME, HE BECOMES AWARE OF DISCREPANCIES AMONGST THE CONTRACT DOCUMENTS OR IF THE EXISTING CONDITIONS ARE NOT AS DESCRIBED BY THE CONTRACT DOCUMENTS. 2. THE ARCHITECT SHALL DEFINE AND/OR CLARIFY THE INTENT OF THE DOCUMENTS WHEN DISCREPANCIES OR OMISSIONS ARE DISCOVERED OR WHEN THE EXISTING CONDITIONS ARE NOT AS

ANTICIPATED BY THE DOCUMENTS. 3. THE CONTRACTOR SHALL SEEK A REVIEW OF A DISCREPANCY OR OMISSION, BY THE ARCHITECT, BEFORE PROCEEDING WITH WORK AFFECTED BY THE DISCREPANCY OR OMISSION.

4. FAILURE TO SEEK A REVIEW MAY CAUSE PORTIONS OF THE WORK AFFECTED BY DISCREPANCIES OR 5. WORK REJECTED UNDER THESE CIRCUMSTANCES, IN ACCORDANCE WITH THE INTENT OF THE

CONTRACT DOCUMENTS, AS DETERMINED BY THE ARCHITECT WILL BE PAID SOLELY AT THE CONTRACTOR'S EXPENSE.

### E. SCOPE AND QUALITY OF THE WORK:

THE CONTRACT DOCUMENTS HAVE BEEN PREPARED WITH THE INTENT THAT EACH TRADE INVOLVED WITH THE WORK SHALL PROVIDE ALL LABOR AND MATERIALS NEEDED FOR A COMPLETELY FINISHED. FULLY FUNCTIONAL ASSEMBLY. WORK IS TO BE OF THE BEST QUALITY, IN KEEPING WITH THE STANDARD OF THE INDUSTRY FOR EACH TRADE. CONTRACTORS, SUBCONTRACTORS, AND MATERIAL SUPPLIERS SHALL BE RESPONSIBLE FOR THE PROVISION OF ALL MATERIALS AND LABOR REQUIRED TO PERFORM INSTALLATIONS OF ALL ITEMS DESCRIBED, INDICATED OR IMPLIED AND TO DUPLICATE MATERIALS, DETAILS, ETC. OF EXISTING CONDITIONS AS NECESSARY.

THE WORK SHALL BE WARRANTEED BY THE CONTRACTOR FOR A PERIOD OF ONE YEAR FROM THE DATE OF SUBSTANTIAL COMPLETION. DURING THIS TIME THE CONTRACTOR SHALL GUARANTEE THE WORK TO BE FREE FROM DEFECTS RESULTING FROM WORKMANSHIP OR FAULTY MATERIALS. DEFECTIVE WORK SHALL BE PROMPTLY REPAIRED OR REPLACED BY THE CONTRACTOR DURING THE WARRANTY PERIOD AT NO EXTRA COST TO THE OWNER. THE CONTRACTOR SHALL MAINTAIN PREMISES IN A NEAT AND ORDERLY CONDITION AT ALL TIMES.

### G. EXTRA WORK:


WORK BEYOND THE SCOPE OF THE BASE BID SHALL NOT BE EXECUTED WITHOUT WRITTEN AUTHORIZATION. THE CONTRACTOR SHALL PROVIDE A PROPOSAL DESCRIBING THE COST OF EXTRA WORK FOR REVIEW BY THE ARCHITECT AND OWNER BEFORE EXECUTING ANY EXTRA WORK. ONLY THE OWNER MAY AUTHORIZE EXTRA WORK. EXTRA WORK WILL NOT AFFECT THE CONTRACT SUM WITHOUT A CHANGE ORDER. PAYMENT FOR EXTRA WORK WILL NOT BE CERTIFIED WITHOUT A PROPERLY EXECUTED CHANGE ORDER.


### H. MINIMUM REQUIREMENTS:

ALL BUILDING SYSTEMS, COMPONENTS AND ASSEMBLIES, AS WELL AS THE BUILDING AS COMPLETED, SHALL COMPLY WITH THE MINIMUM REQUIREMENTS FOR CONSTRUCTION AS SET FORTH BY THE CODE ADOPTED BY THE GOVERNING JURISDICTION AND ANY LOCAL AMENDMENTS.

# I. OWNER / CONTRACTOR CHANGES:

ANY CHANGES, REVISIONS, OR AMENDMENTS TO THE CONTRACT DOCUMENTS MADE BY THE OWNER OR CONTRACTOR, WITHOUT THE WRITTEN CONSENT OF THE ARCHITECT WILL BE AT THE OWNERS OR CONTRACTORS LIABILITY. THE OWNER AND CONTRACTOR WILL HOLD HARMLESS THE ARCHITECT FOR ANY ERRORS OR OMISSIONS RESULTING FROM A CHANGE TO THE DOCUMENTS THAT WAS NOT REVIEWED AND APPROVED IN WRITING BY THE ARCHITECT

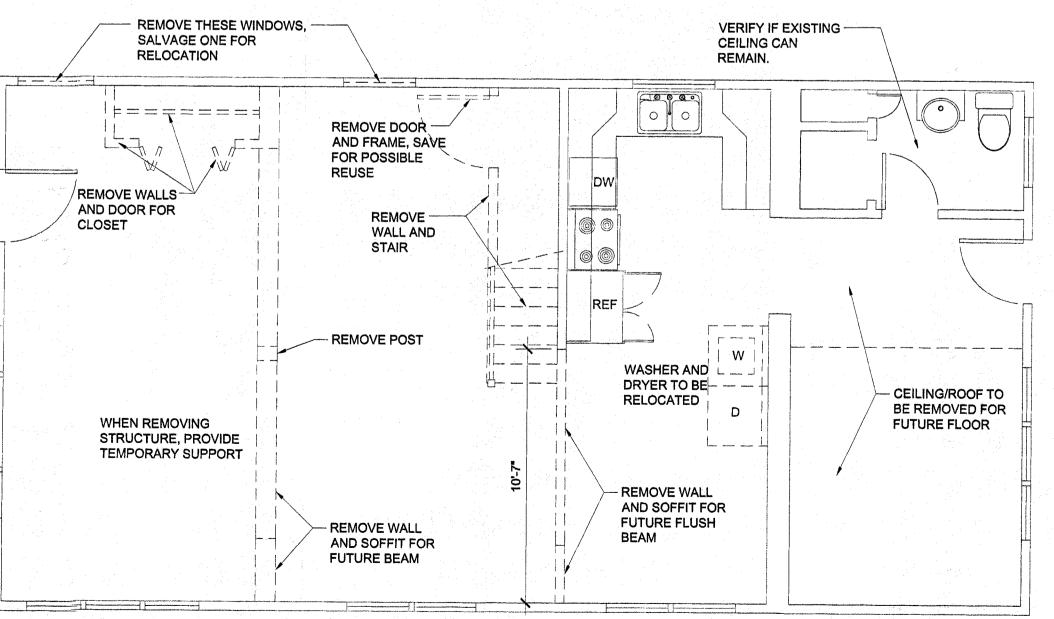

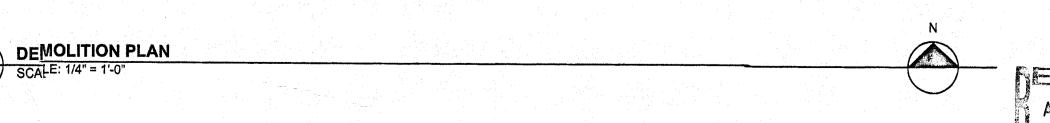



EXP. 11/30/16

SHEET NO.

#### LOAD TABLE LIVE LOAD DEAD LOAD REMARKS AREA ROOF 40 PSF 20 PSF EXTERIOR BALCONIES 40 PSF DECKS / FIRE ESCAPES 40 PSF PASSENGER VEHICLE GARAGES 50 PSF ATTICS WITHOUT STORAGE 5 PSF 10 PSF ATTICS WITH STORAGE 20 PSF 10 PSF FLOOR 40 PSF 10 PSF 10 PSF FLOOR (SLEEPING) 30 PSF

40 PSF

200 PSF

50 PSF


STAIR

GUARDRAILS / HANDRAILS

GUARDRAIL IN-FILL COMPONENTS


### STRUCTURAL NOTES:

- 1. ALL HEADERS IN EXTERIOR WALLS TO BE (2) 2x6 INSULATED HEADERS U.N.O. ON PLANS.
- 2. ALL HEADERS IN INTERIOR WALLS TO BE (2)2x6 HEADERS U.N.O. ON PLANS.
- 3. ALL FLOOR JOISTS SHALL BE #2 CANADIAN SPRUCE-PINE-FIR OR BETTER WITH BRIDGING U.N.O. ON PLANS. BRIDGING TO BE 6'-0" O.C. MAX.
- 4. DRILLING OR NOTCHING OF STUDS OR JOISTS SHALL COMPLY WITH REQUIREMENTS OF THE UNIFORM DWELLING CODE.

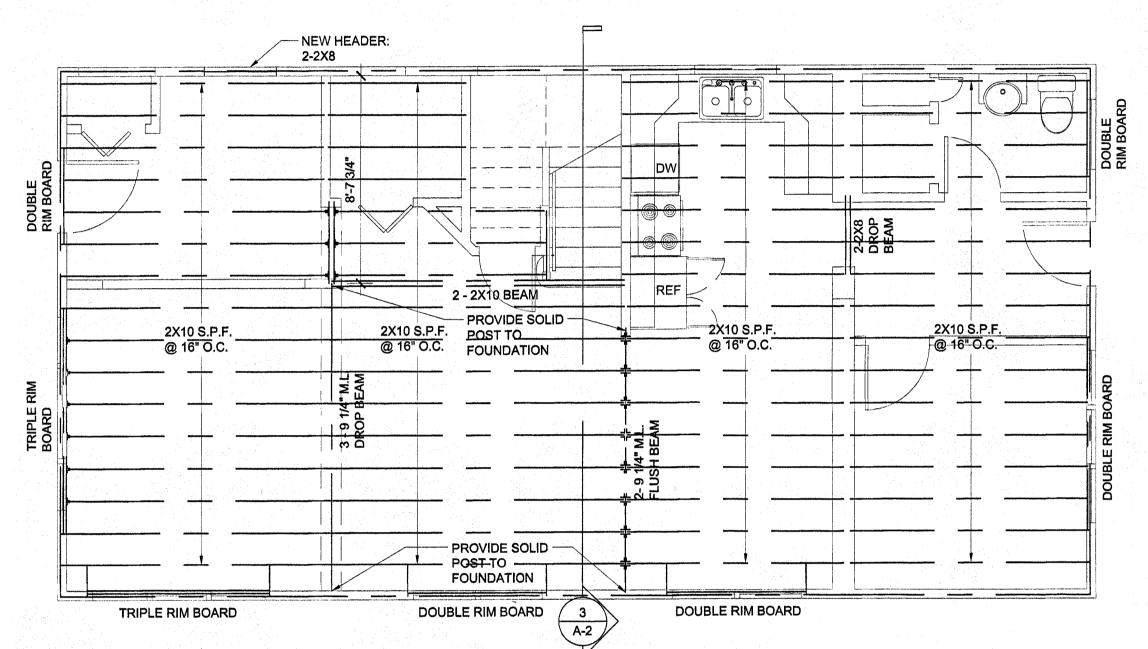

- 1. ASSUMPTIONS HAVE BEEN MADE REGARDING THE EXISTING CEILING/FLOOR STRUCTURE DUE TO IT NOT BEING READILY OBSERVED.
- 2. ALL ELECTRICAL IN CEILING/FLOOR NEEDS TO BE REMOVED TO ALLOW FOR NEW FLOOR JOIST BEING NESTED ALONGSIDE EXISTING FLOOR JOIST OR CEILING JOIST.
- 3. IF CONDITIONS ARE DIFFERENT THAN ASSUMED, THE ARCHITECT SHOULD BE NOTIFIED.
- 4. PROVIDE SOLID BEARING AT BEAMS AND WALLS WHERE NEW FLOOR JOISTS ARE INSTALLED. 5. IF FINISHED FLOOR HEIGHT OF SECOND FLOOR IS DIFFERENT THAN SHOWN, THE STAIR WILL BE AFFECTED. THIS WILL NEED TO BE
- CONSIDERED AND ACCOMMODATED IN THE NEW STAIR CONFIGURATION



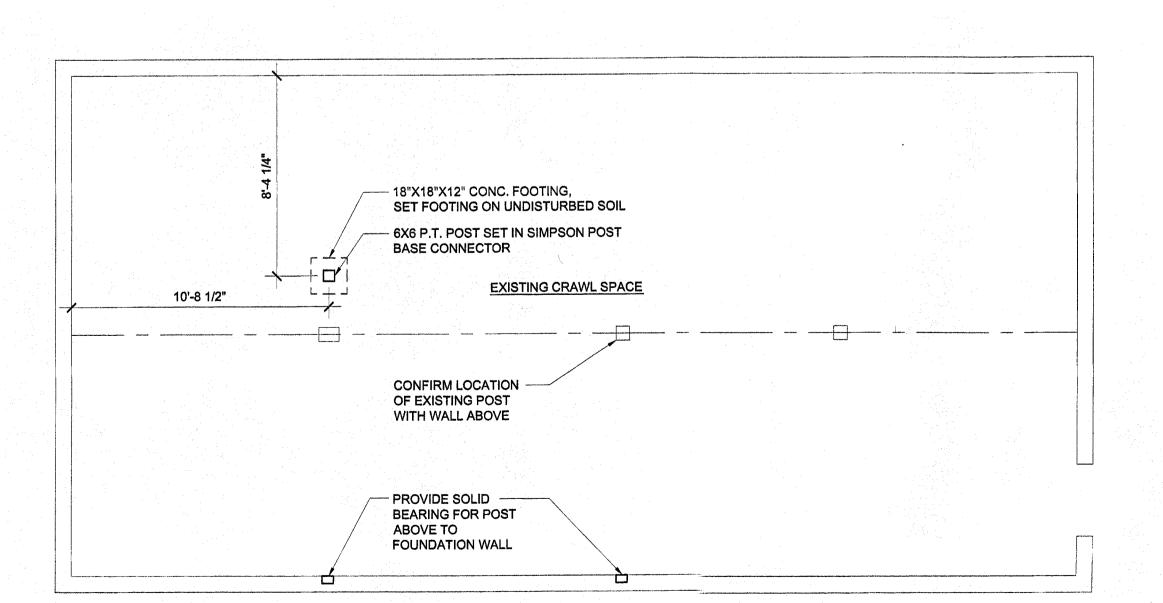

CRAWL SPACE PLAN
SCALE: 1/4" = 1'LO"

## LIGHT AND VENTILATION TABLE

	ROOM NAME	AREA (SQ.FT.)	LIGHT REQ'D	LIGHT PROV.	VENT. REQ'D	VENT PROV.	REMARKS	
								2.
	BEDROOM 1	116	9.3	28	4.6	14.8		
	BEDROOM 2	107	8.6	28	4.3	14.8		
	BEDROOM 3	113	9.0	21.2	4.5	11.6		
	BEDROOM 4	121	9.7	28	4.8	14.8		
	BEDROOM 5	109	8.7	28	4.3	14.8		
- :						1.0		

# LIGHT AND VENTILATION TABLE GENERAL NOTES:

1. ARTIFICIAL VENT AND LIGHT TO BE PROVIDED IN BASEMENTS, CRAWL SPACES AND ATTICS AS REQUIRED. 2. CONTRACTOR TO VERIFY VENT AND LIGHT CODE COMPLIANCE IF WINDOW MANUFACTURER, TYPE OR SIZES ARE SUBSTITUTED.

- INFILL WALL AT

SECOND FLOOR PLAN

A-1 | SCALE: 1/4" = 1'-0"

### **PARTITION LEGEND:**

INTERIOR PARTITION: 2x4 WOOD STUDS AT 16" O.C. W/ 1/2" GYP, BD, BOTH SIDES SEE WALL SECTIONS FOR EXTERIOR WALL CONSTRUCTION.

#### **GENERAL PLAN NOTES:**

1. WALL AND PARTITION DIMENSIONS SHOWN ON PLAN ARE NOMINAL DIMENSIONS.

2. WALL AND PARTITION DIMENSIONS ARE SHOWN TO FINISHED FACE OF WALL.


3. DO NOT SCALE DRAWINGS. THE DRAWINGS ARE NOT NECESSARILY TO SCALE.


4. LARGE SCALE DETAILS GOVERN OVER SMALL SCALE

5.DOUBLE UP JOISTS UNDER PARALLEL PARTITIONS AND UNDER BATHTUBS.

6. STAIR NOTES: MIN STAIR WIDTH = 36" MAX HANDRAIL PROJECTION = 4 1/2" MIN HEADROOM = 6'-6" MAX RISER = 8" MIN TREAD = 9" NOSING TO NOSING MIN - MAX HANDRAIL HEIGHT = 30"-38" GUARDRAIL HEIGHT = 36" VERTICAL RAIL SPACING SHOULD NOT ALLOW PASSAGE OF 4" SPHERE. HANDRAILS TO END IN LINE WITH THE TOP AND BOTTOM


7. GLAZING AT ALL HAZARDOUS LOCATIONS SHALL BE OF AN APPROVED SAFETY GLAZING. ALL GLAZING SHALL MEET THE REQUIREMENTS OF UNIFORM DWELLING CODE.

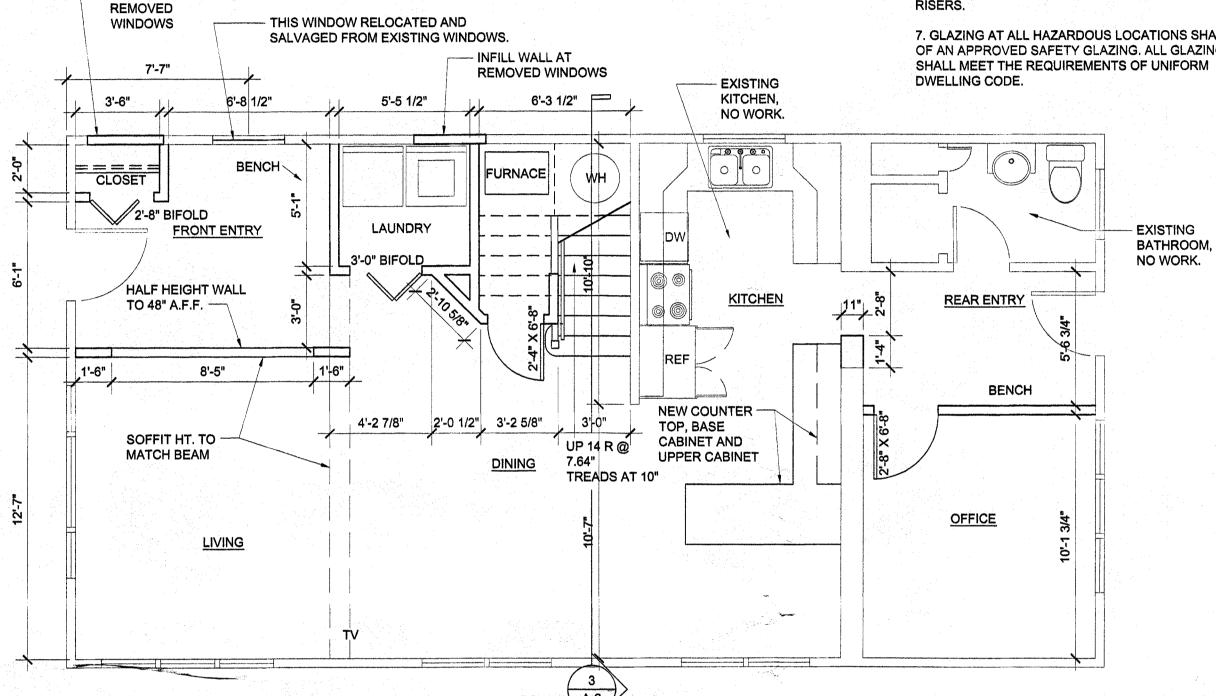

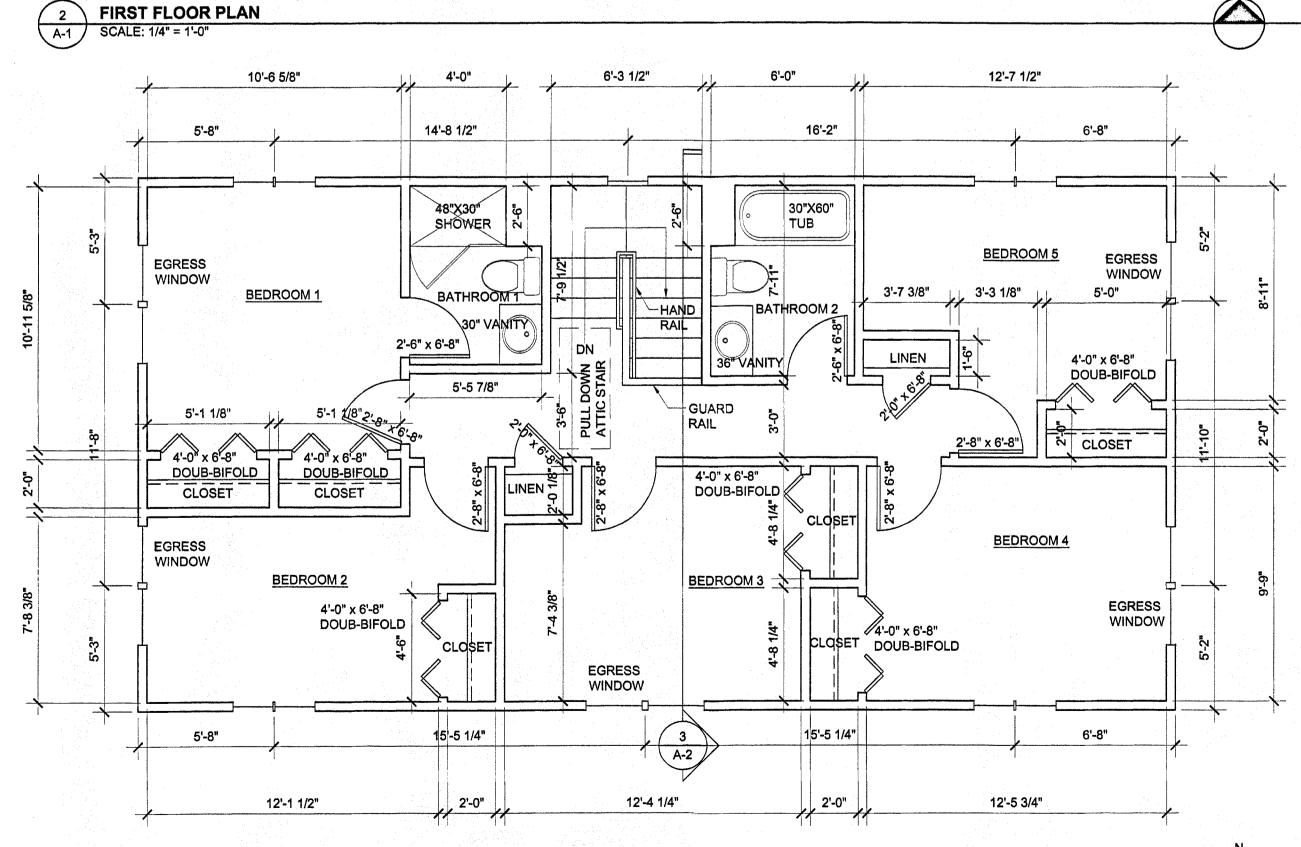

SHEET NO.

RESIDENCE
OR ADDITION
AL BEACH AVE
AKE, IL. 60014

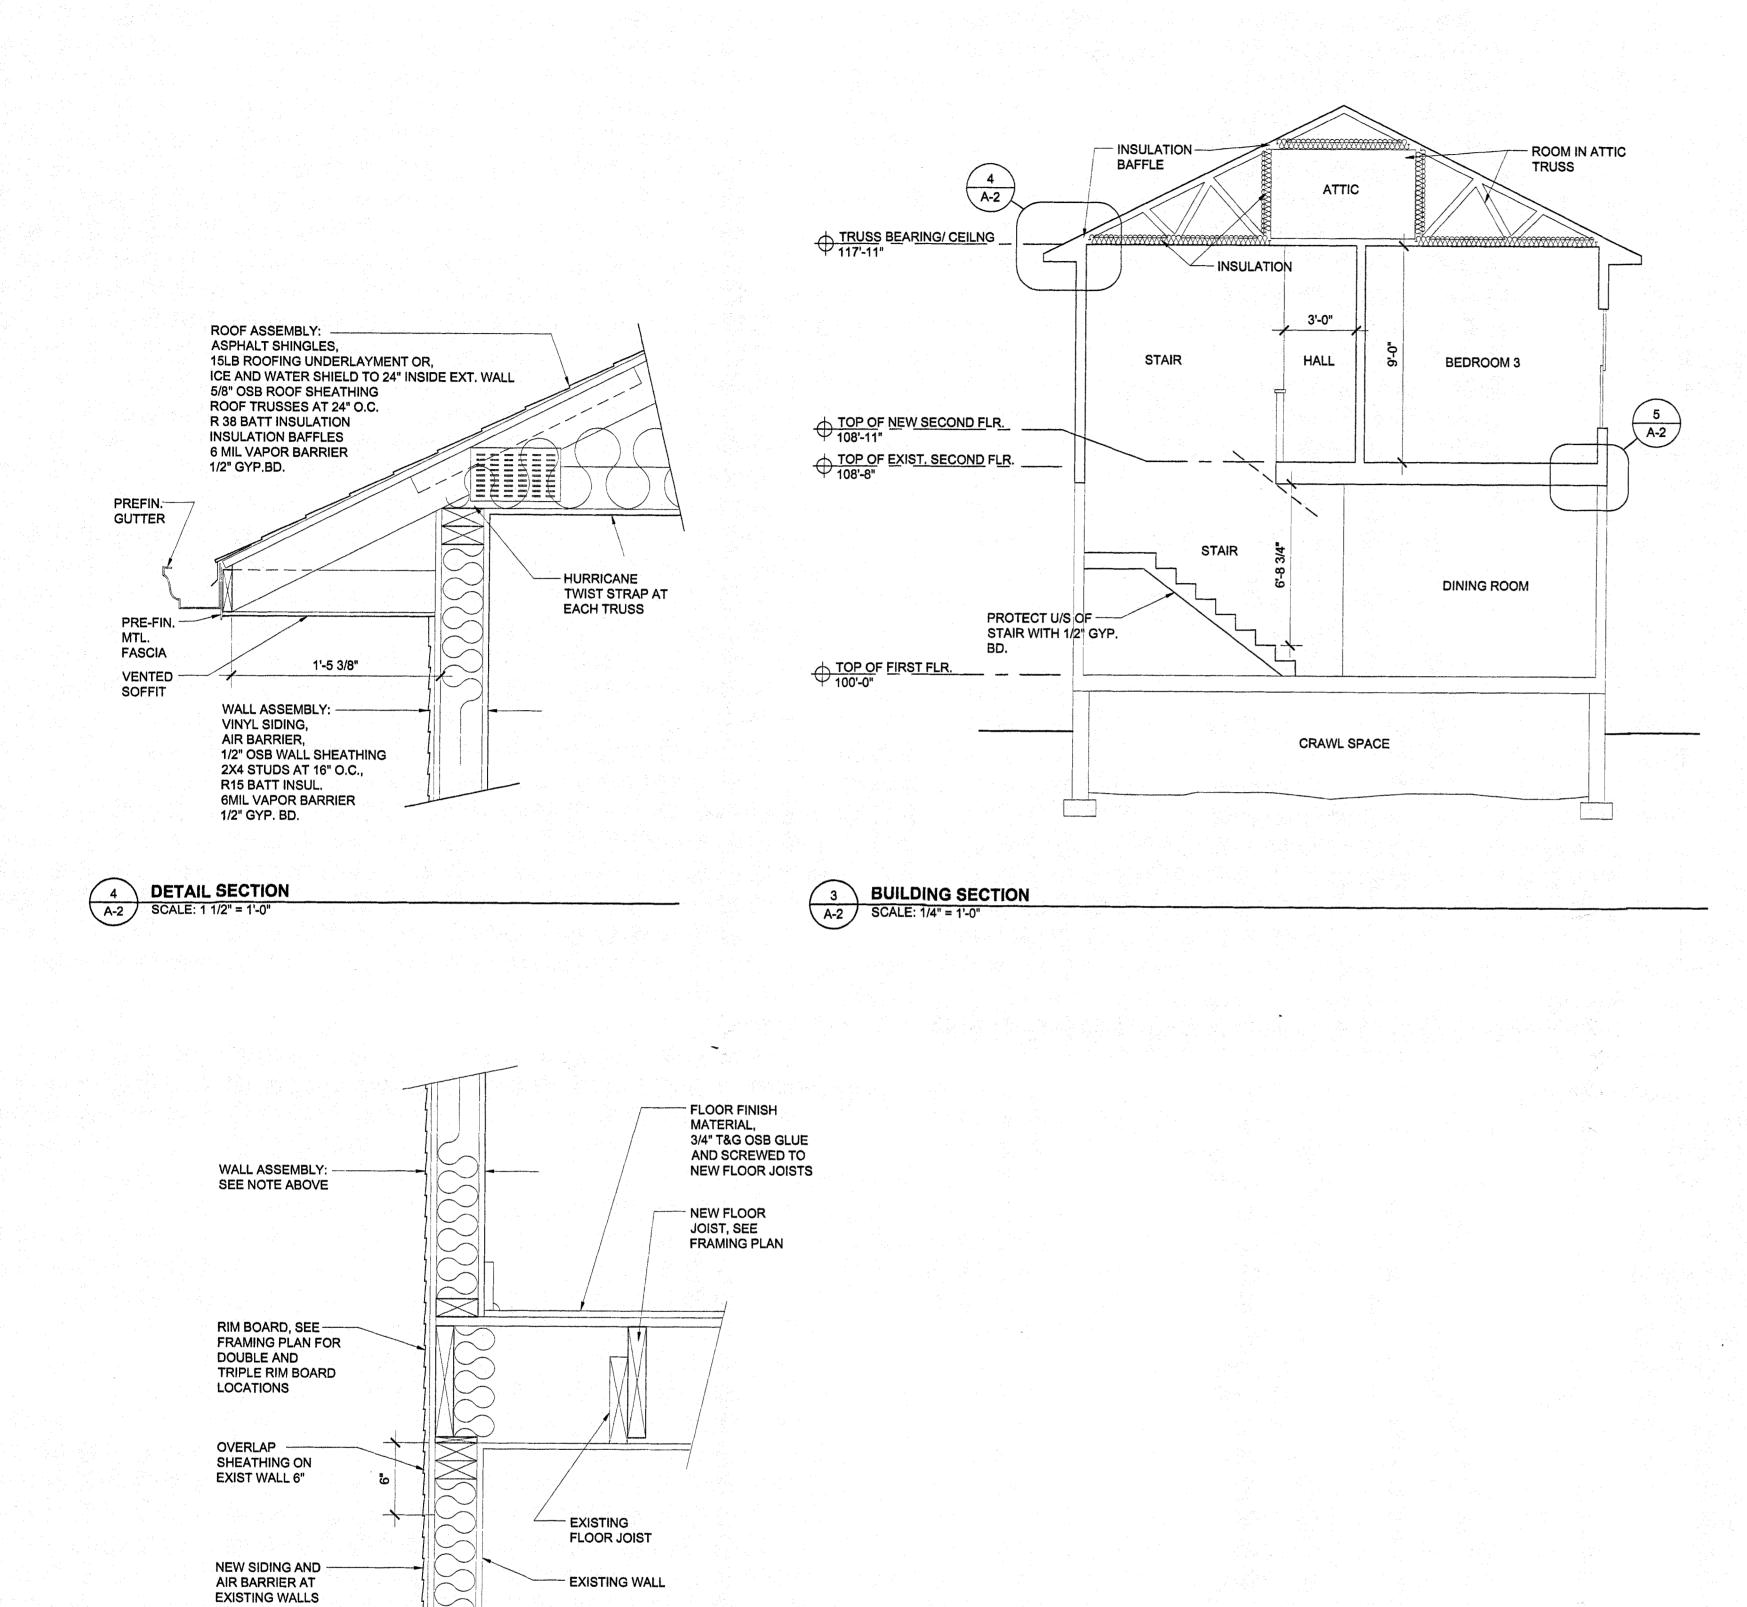

5 **DETAIL SECTION**A-2 SCALE: 1 1/2" = 1'-0"

CONTINUOUS PRE-FIN. GUTTER AND DOWNSPOUTS

CONTINUOUS PRE-FIN. GUTTER AND DOWNSPOUTS

CONTINUOUS PRE-FIN. GUTTER AND DOWNSPOUTS

ROOM IN ATTIC TRUSS PROFILE

1. THIS PROFILE IS SUGGESTED, ACTUAL PROFILE TO BE ENGINEERED BY TRUSS MANUFACTURER.

2. TRUSS MANUFACTURER TO PROVIDE STAMPED/ENGINEERED DRAWINGS FOR REVIEW BY CITY AND ARCHITECT.

3. PROVIDE HURRICANE TWIST STRAPS AT EACH TRUSS BEARING POINT.

2 ROOF TRUSS PROFILE


SCALE: 1/4" = 1'-0"


1 ROOF PLAN / ROOF FRAMING
A-2 SCALE: 1/4" = 1'-0"

THINNES RESIDENCE
2ND FLOOR ADDITION
113 CRYSTAL BEACH AVE
CRYSTAL LAKE, IL. 60014

SHEET CONTENTS:
ROOF PLAN
TRUSS PROFILE
BUILDING SECTION

SHEET NO.

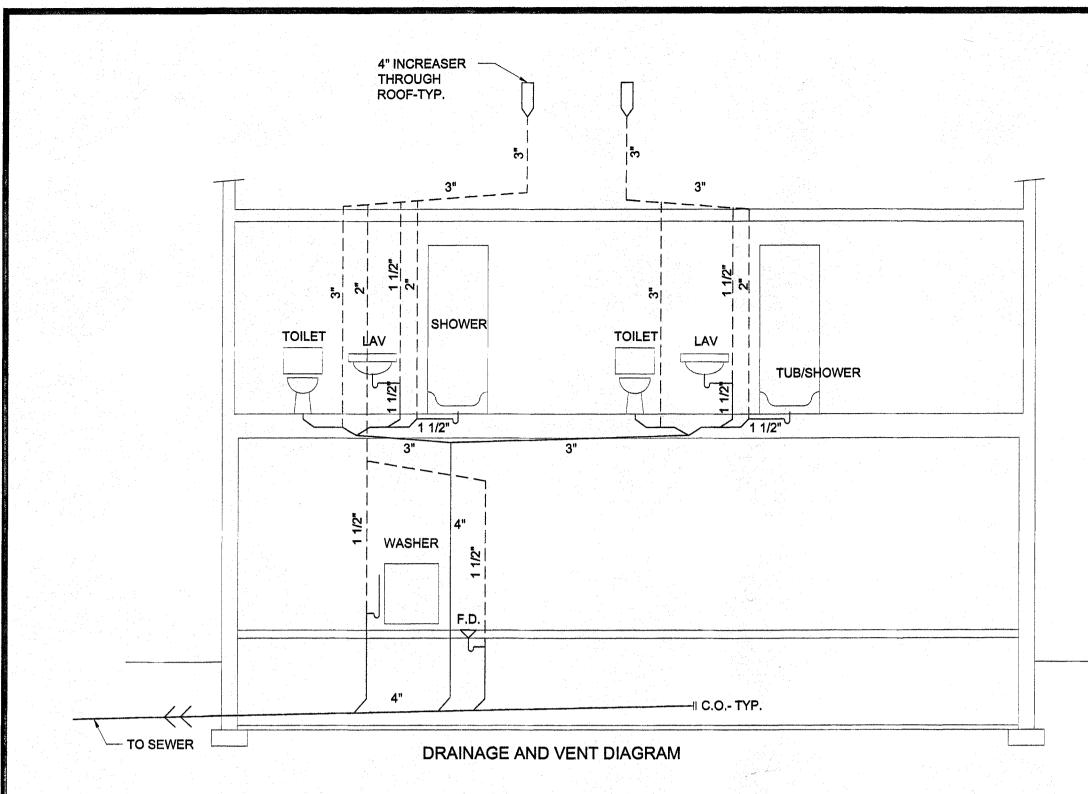

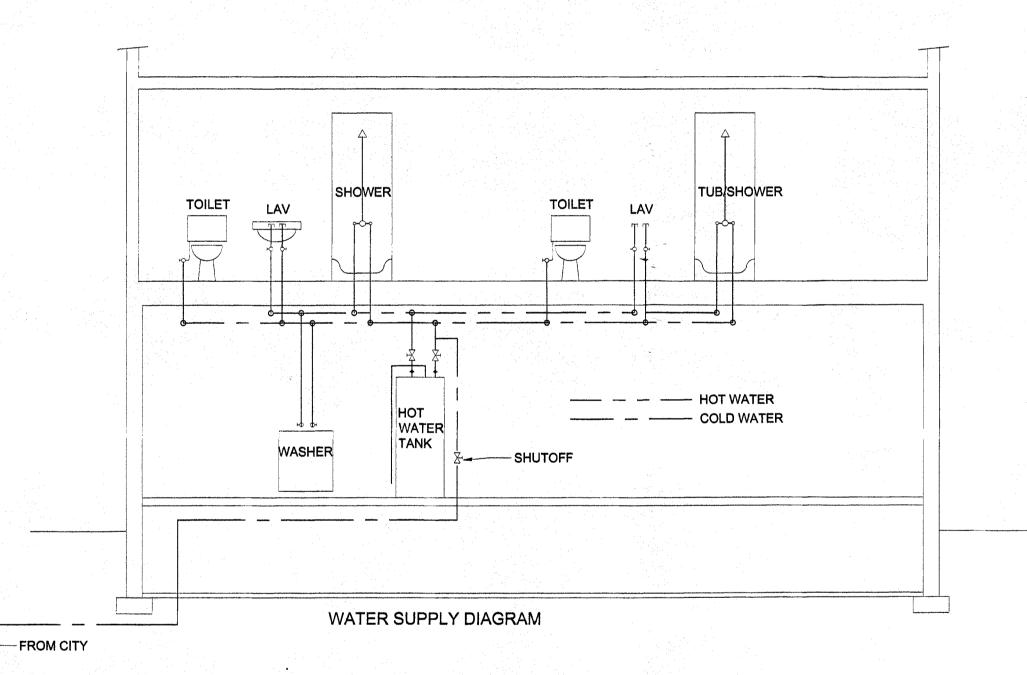

## **PLUMBING NOTES:**

1. ENTIRE INSTALLATION SHALL CONFORM TO ALL LOCAL CODES AND ORDINANCES. THE COMPLETE SYSTEM SHALL BE FULLY OPERATIONAL. ACCEPTANCE BY THE OWNER AND THE GOVERNING AUTHORITY SHALL CONSTITUTE A COMPLETE SYSTEM. ALL WORK SHALL BE COORDINATED WITH OTHER TRADES TO AVOID INTERFERENCE, PRESERVE MAXIMUM HEADROOM AND AVOID OMISSIONS. ALL MATERIALS, WORKMANSHIP AND EQUIPMENT SHALL BE GUARANTEED FOR ONE (1) YEAR AFTER SYSTEM ACCEPTANCE.

2. ALL FIXTURES SHALL HAVE MIN. 12" AIR CHAMBERS AT EACH RISER AND SHUT-OFFS VALVES.

3. HUBLESS PIPE AND FITTINGS ARE NOT ALLOWED.

4. TEE'S OR CROSSES ARE NOT ALLOWED ON WASTE LINES.

5. ALL FLASHINGS TO BE PVC..

6. END VENTING IS NOT REQUIRED, STACK VENT SHALL BE INSTALLED DOWNSTREAM OF WASTE LINES.

**MECHANICAL GENERAL NOTES:** 

NEEDS TO BE COORDINATED WITH THE ARCHITECT.

INSTALLATION WHEN APPLICABLE.

1. ENTIRE INSTALLATION SHALL CONFORM TO ALL LOCAL CODES AND

ORDINANCES. THE COMPLETE SYSTEM SHALL BE FULLY OPERATIONAL

ACCEPTANCE BY THE OWNER AND THE GOVERNING AUTHORITY SHALL CONSTITUTE A COMPLETE SYSTEM. ALL WORK SHALL BE COORDINATED WITH OTHER TRADES TO AVOID INTERFERENCE, PRESERVE MAXIMUM HEADROOM AND AVOID OMISSIONS. ALL MATERIALS, WORKMANSHIP AND EQUIPMENT SHALL BE GUARANTEED FOR ONE (1) YEAR AFTER SYSTEM

2. MECHANICAL CONTRACTOR SHALL VERIFY DUCT RUNS (SUPPLY AND RETURN) PRIOR TO ANY WORK BEING DONE TO INSURE SUFFICIENT SPACE AND ACCESS FOR NEW DUCT WORK. ANY CHASE, BOX-OUT, OR SOFFIT

THE BUILDING DEPARTMENT, INCLUDING LISTING FOR OUTSIDE

3. MANUFACTURER'S INSTALLATION INSTRUCTIONS SHALL BE SUBMITTED TO

4. ALL FRESH AIR INTAKES SHALL BE A MINIMUM OF 10' FROM HAZARDOUS OR NOXIOUS CONTAMINANTS SUCH AS VENTS, CHIMNEYS AND PLUMBING

5. ALL EQUIPMENT TO BE INSTALLED ACCORDING TO MANUFACTURER'S INSTRUCTIONS FOR CLEARANCE. THIS INFORMATION IS TO BE PROVIDED TO

6. DUCT GUAGE TO BE 26 GUAGE, HANGERS BY BASSET WITH A MAXIMUM

7. FLEXIBLE AIR DUCTS AND CONNECTORS LENGTH SHALL BE LIMITED IN

LENGTH TO 10', AND ONLY ALLOWED WHEN BOTH ENDS ARE ACCESSIBLE.

9. EXHAUST FROM ALL TOILET ROOMS SHALL DISCHARGE TO THE EXTERIOR.

10. CONTRACTOR TO VERIFY NUMBER AND LOCATION OF RETURN AIR GRILLS TO ENSURE A BALANCED HEATING AND COOLING SYSTEM.

11. PROVIDE ALL NECESSARY DRIP PANS, AND CONDENSATE LINES TO

1. THE MECHANICAL WORK INCLUDES USING THE EXISTING FURNACE AND

2. A NEW FURNACE WILL BE LOCATED IN THE ATTIC OVER THE SECOND FLOOR. IT WILL HAVE A CONDENSOR LOCATED NEAR THE EXISTING

3. ALL DUCTWORK FOR THE SECOND FLOOR TO BE LOCATED IN THE ATTIC

4. THE HVAC CONTRACTOR SHALL SIZE THE FURNACE, CONDENSOR, AND

8. A DRIP LEG SHALL BE INSTALLED AT ALL GAS APPLIANCES.

ENSURE A COMPLETE AND FUNCTIONAL INSTALLATION.

**MECHANICAL PROJECT NOTES:** 

CONDENSOR TO SERVE THE FIRST FLOOR ONLY.

7. INCREASERS TO BE INSTALLED THROUGH ROOF.

8. WASTE AND VENT PIPING TO BE SCH 40 PVC.

9. "M" TYPE COPPER NOT ALLOWED.

ACCEPTANCE.

SPACING OF 8'.

CONDENSOR.

ALL DUCT WORK.

AND SHALL BE INSULATED.

# BATHROOM FAN/LIGHT COMBINATION

ELECTRICAL SYMBOL LEGEND

BRACED FAN J-BOX

CEILING LIGHT

-O- WALL LIGHT

DUPLEX RECEPTACLE

-₩ SWITCH

→ 3 WAY SWITCH

4 WAY SWITCH

INTERCONNECTED SMOKE DETECTOR

INTERCONNECTED SMOKE DETECTOR / CARBON MONOXIDE DETECTOR

### **ELECTRICAL GENERAL NOTES:**

1. ENTIRE INSTALLATION SHALL CONFORM TO ALL LOCAL CODES AND ORDINANCES. THE COMPLETE SYSTEM SHALL BE FULLY OPERATIONAL. ACCEPTANCE BY THE OWNER AND THE GOVERNING AUTHORITY SHALL CONSTITUTE A COMPLETE SYSTEM. ALL WORK SHALL BE COORDINATED WITH OTHER TRADES TO AVOID INTERFERENCE, PRESERVE MAXIMUM HEADROOM AND AVOID OMISSIONS. ALL MATERIALS, WORKMANSHIP AND EQUIPMENT SHALL BE GUARANTEED FOR ONE (1) YEAR AFTER SYSTEM ACCEPTANCE.

2. GROUNDING SHALL COMPLY WITH LOCAL INSPECTION AUTHORITY.

3. ALL MATERIALS USED SHALL BEAR THE U/L LABEL AND BE OF THE APPROPRIATE NEMA STANDARD. ALL MATERIALS LOCATED NEAR A WATER SOURCE SHALL BE GROUND FAULT CIRCUIT INTERRUPTED. ALL MATERIALS LOCATED OUTSIDE SHALL BE WATER RESISTANT.

4. LAYOUT IS DIAGRAMMATIC AND WORK SHALL BE INSTALLED TO MEET FIELD CONDITIONS AND EQUIPMENT SELECTED. PROVIDE SHOP DRAWINGS AS REQUIRED AND VERIFY ALL EQUIPMENT AND LAYOUT PRIOR TO INSTALLATION.

5. FOR CLARITY OF ALL PLANS, SOME CONDUIT AND WIRE HAS NOT BEEN SHOWN. IT IS THE RESPONSIBILITY OF THE ELECTRICAL CONTRACTOR TO FURNISH AND INSTALL COMPLETE AND OPERATING SYSTEMS, INCLUDING ALL CONDUIT AND WIRING.

6. CONDUIT SHALL BE CONCEALED WHERE POSSIBLE. WHERE EXPOSED, CONDUIT SHALL BE RUN IN STRAIGHT LINES PARALLEL AND/OR PERPENDICULAR TO THE BUILDING STRUCTURE. CONDUITS INSTALLED IN AREAS SUBJECT TO DAMAGE SHALL BE RIGID GALVANIZED, OR INTERMEDIATE METAL TYPE. MINIMUM CONDUIT SHALL BE 1/2" DIAMETER TRADE.

7. ALL CONDUCTORS SHALL BE COPPER, MINIMUM NUMBER 12 THHN.

8. INSTALLATIONS REQUIRING FLEXIBLE CONNECTION SHALL BE IN FLEXIBLE METAL CONDUIT NOT TO EXCEED 6', WITH A GREEN EQUIPMENT GROUNDING CONDUCTOR INSTALLED BETWEEN THE EQUIPMENT AND THE DISCONNECTION MEANS.

9. ALL CONDUITS INSTALLED IN CONCRETE OR BELOW GRADE SHALL BE RIGID HEAVY WALL GALVANIZED STEEL OR INTERMEDIATE METAL GALVANIZED CONDUIT. ALL CONDUITS WHICH CONTAIN SERVICE ENTRANCE CONDUCTORS OR SUB FEED CONDUCTORS SHALL BE ENCASED IN MINIMUM FOUR INCHES OF SURROUNDING

10. ALL CONDUCTORS INSTALLED FOR LOW VOLTAGE APPLICATIONS SHALL BE INSTALLED IN ELECTRICAL METALLIC TUBING OR RIGID GALVANIZED STEEL CONDUIT IN ALL AREA THAT ARE NOT ACCESSIBLE.


11. ALL CONDUCTORS SHALL BE INSTALLED IN RIGID HEAVY WALL GALVANIZED STEEL CONDUIT, INTERMEDIATE METAL CONDUIT OR ELECTRICAL METALLIC


12. WIRING SYSTEMS AND CONDUCTORS SHALL NOT BE INSTALLED IN ANY CONDUIT SYSTEM OR JUNCTION BOX UNTIL ALL WALL FINISHES ARE APPLIED. 13. PROVIDE DISCONNECTING MEANS AT EACH FURNACE, HEATER, CONDENSER, WATER HEATER OR HEAT PUMP AND INSTALLED PER CITY/VILLAGE CODES.


14. ALL RECEPTACLES SHALL BE MINIMUM 20A.

15. PROVIDE AND MAINTAIN CODE-REQUIRED MINIMUM CLEARANCES FOR ALL ELECTRICAL PANELS.

16. ELECTRICAL GROUNDING SHALL BE TO STREET SIDE OF METER, NOT JUMPERED.

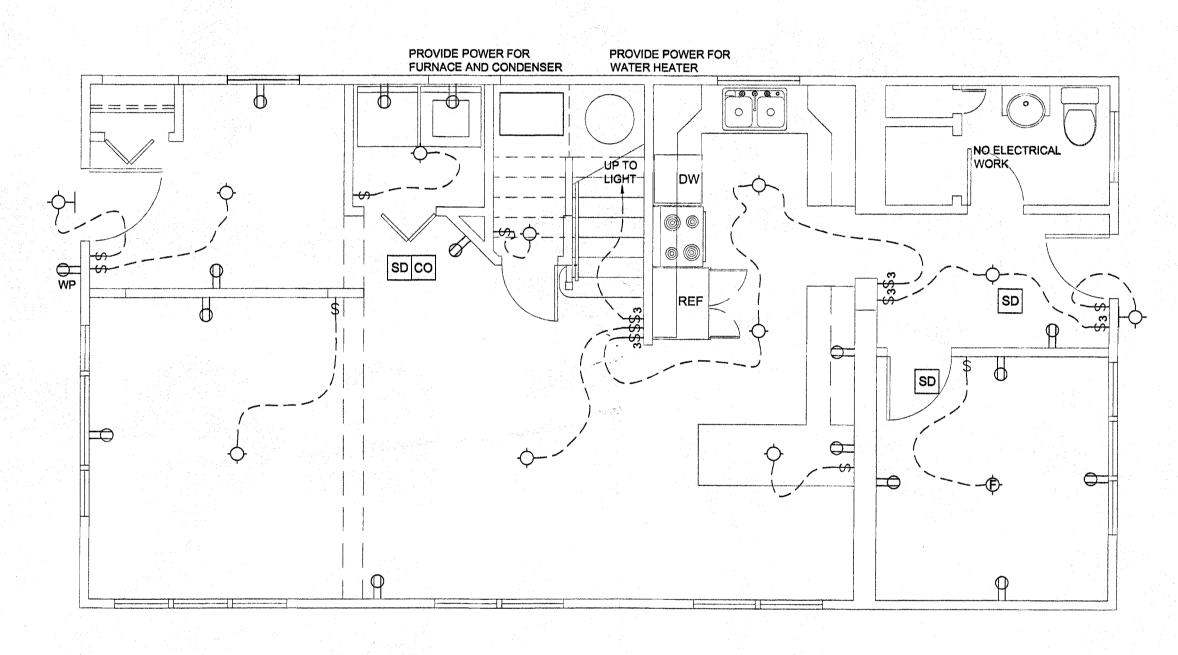

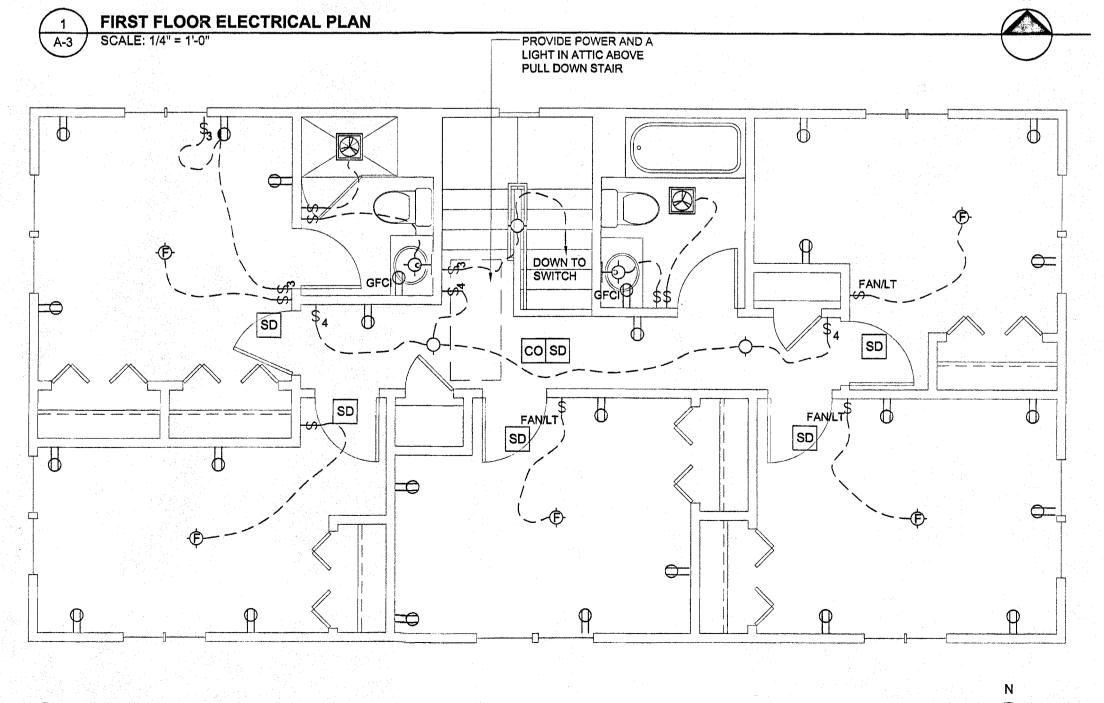

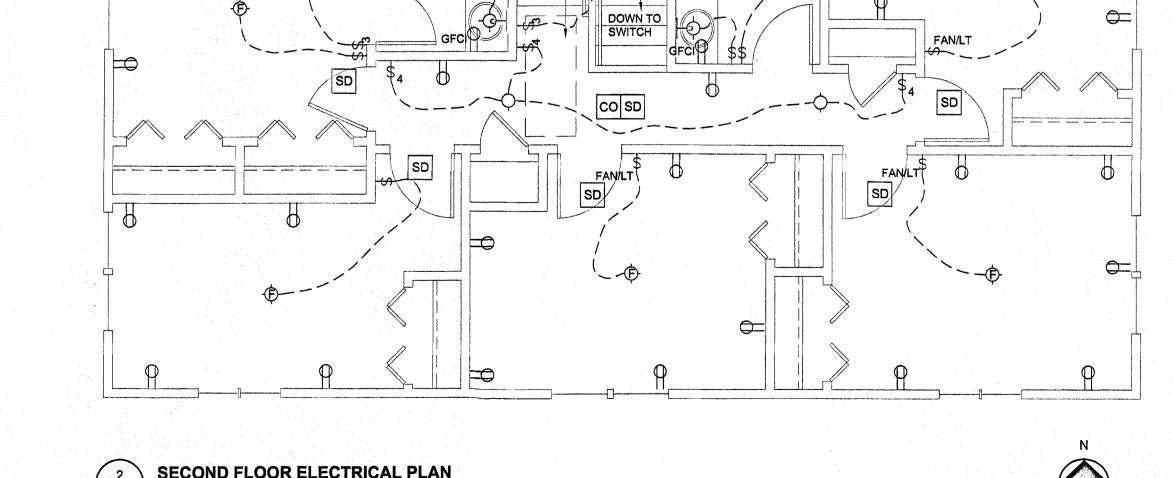

SECOND FLOOR ELECTRICAL PLAN 2 SECOND FLOO SCALE: 1/4" = 1'-0"



SHEET NO.