



#2015-52 Insite RE Inc./ Verizon Wireless–Special Use Permit Project Review for Planning and Zoning Commission

<u>Meeting Date:</u>	October 21, 2015
<u>Request:</u>	A Special Use Permit for a wireless communication antenna to be mounted on a city utility pole.
<u>Location:</u>	(42.23367, -88.30142) Exchange Drive
<u>Acreage:</u>	--
<u>Existing Zoning:</u>	Located in city right-of-way
<u>Surrounding Properties:</u>	North: M (Manufacturing) South: M (Manufacturing) East: M (Manufacturing) West: M (Manufacturing)
<u>Staff Contact:</u>	Kathryn Cowlin (815.356.3798)

Background:

- **Existing Use:** The proposed location of the wireless communication antenna is in the city right-of-way, near the Pingree Road Metra Station. Currently, there are no structures within the right-of-way.
- **Background:** The petitioner is proposing to locate a wireless communication antenna on a city utility pole. The utility pole with the siren would be a 52.17-foot timber pole with a tornado siren mounted on the top.
- **UDO Requirements:** A special use permit is required for wireless communication antennas. There are a number of required special use permit criteria specific to wireless communication towers with a few that are applicable to antennas.

Development Analysis:

General

- **Request:** The petitioner is requesting a special use permit for a wireless communications antenna.
- **Land Use:** Right-of-way.

Proposed Development Description

- The overall height of the city utility pole with the siren mounted on the top is 52.17 feet.
- The proposed wireless communication antenna is mounted at a height of 30 feet.

- There would be three 23.2 x 12.0 x 7.1 inch antenna mounted on the utility, see picture below.
- The antenna will be painted a light gray color.

696-900 / 1710-2170 MHz

QXW-632X634XBF-EDIN Replaces 71 Antenna product 60631L

XX-Pol | Dual Band FET Panel | 63" / 63" | 11.6 / 14.3 dBi

Electrical Characteristics		696-900 MHz		1710-2170 MHz		
Frequency band	696-805	805-900	1710-1800	1800-1900	1900-2170	
Polarization	45°		45°			
Horizontal beamwidth	70°	60°	60°	60°	61°	
Vertical beamwidth	50°		60°	18°	18°	
Gain	13.0 dBi (11.1 dBi) 13.0 dBi (10.9 dBi)		13.0 dBi (11.8 dBi) 13.0 dBi (11.2 dBi) 14.3 dBi (12.2 dBi) 14.3 dBi			
Electrical down tilt (°)	0		0			
Impedance	50Ω		50Ω			
VSWR	1.5:1		1.5:1			
Isolation between ports	25 dB		25 dB			
Rated power	500 W		300 W			
Lighting protection	Direct ground					
Connector(s)	4 x 7-79 SMA 1 Female / Bottom					

Antenna to be mounted to city utility pole

Mechanical Characteristics		696-900 MHz		1710-2170 MHz		
Dimension length x Width x Depth	509 x 320 x 183 mm		23.2 x 12.6 x 7.1 in			
Weight without mounting bracket	5 kg		11 lbs			
Standard wind speed	> 201 km/hr		= 125 mph			
Wind area	Front: 0.18 m ²	Side: 0.11 m ²	Front: 1.0 ft ²	Side: 1.1 ft ²		
Wind load @ 161 km/hr (100 mph)	Front: 218 N	Side: 129 N	Front: 49 lbf	Side: 29 lbf		

Mounting Options: 2-Port Mounting & Cowork Bracket #2: 362 10008 40-110 mm 1.57x4.5 in 4.1 kg 9.0 lbs

Antenna Bottom View

Labels: 45° 1710-2170 MHz, 45° 1710-2170 MHz, 45° 696-900 MHz, 45° 696-900 MHz

Quality performance parameters are provided to allow typical or range values only and may vary as a result of normal manufacturing and operational conditions. Excessive operational conditions and/or stress on standard supports is beyond our control. Such conditions may result in damage to this product. Improvements to product may be made without notice.

1 of 2
www.amphenol-antennas.com
REV04212

1 ANTENNA SPECIFICATIONS SHEET
N.T.S.

Findings of Fact:

SPECIAL USE PERMIT

Special Uses require a separate review because of their potential to impact surrounding properties and the orderly development of the City. Section 2-400 of the Unified Development Ordinance establishes standard for all Special Uses in Crystal Lake. The criteria are as follows:

1. That the proposed use is necessary or desirable, at the location involved, to provide a service or facility which will further the public convenience and contribute to the general welfare of the neighborhood or community.
 Meets *Does not meet*

2. That the proposed use will not be detrimental to the value of other properties or improvements in the vicinity.
 Meets *Does not meet*

3. That the proposed use will comply with the regulations of the zoning district in which it is located and this Ordinance generally, including, but not limited to, all applicable yard and bulk regulations, parking and loading regulations, sign control regulations, watershed, wetlands, and flood plain regulations, Building and Fire Codes and all other applicable City Ordinances.
 Meets *Does not meet*

4. That the proposed use will not negatively impact the existing off-site traffic circulation; will adequately address on-site traffic circulation; will provide adequate on-site parking facilities; and, if required, will contribute financially, in proportion to its impact, to upgrading roadway and parking systems.
 Meets *Does not meet*

5. That the proposed use will not negatively impact existing public utilities and municipal service delivery systems and, if required, will contribute financially, in proportion to its impact, to the upgrading of public utility systems and municipal service delivery systems.
 Meets *Does not meet*

6. That the proposed use will not impact negatively on the environment by creating air, noise, or water pollution; ground contamination; or unsightly views.
 Meets *Does not meet*

7. That the proposed use will maintain, where possible, existing mature vegetation; provide adequate screening to residential properties; provide landscaping in forms of ground covers, trees and shrubs; and provide architecture, which is aesthetically appealing, compatible or complementary to surrounding properties and acceptable by community standards, as further detailed in Article 4, Development and Design Standards.
 Meets *Does not meet*

8. That the proposed use will meet standards and requirements established by jurisdictions other than the City such as Federal, State or County statutes requiring licensing procedures or health/safety inspections, and submit written evidence thereof.
 Meets *Does not meet*

9. That the proposed use shall conform to any stipulations or conditions approved as part of a Special Use Permit issued for such use.

Meets Does not meet

10. That the proposed use shall conform to the standards established for specific special uses as provided in this section.

Meets Does not meet

Radio transmission towers, wireless communication facilities. All radio transmission towers and wireless communication facilities must comply with the following standards:

1. Towers shall be designed to meet the wind loading requirements specified in the American National Standards Institute TIA-222-F Report, as amended.

Meets Does not meet

Meets this standard per structural analysis submitted certifying the ability of the city utility pole to support the petitioner's equipment.

2. The owner/applicant shall provide documentation to the City demonstrating that the structural integrity of the towers and antenna will continue to comply with state and federal standards, local building codes, and the applicable standards for towers published by the American National Standards Institute (ANSI), as amended. If, upon inspection, it is determined a tower fails to comply with such standards and constitutes a danger to persons or property, the owner shall be notified that he/she has 30 days to bring the tower into compliance. Failure to bring the tower into compliance within 30 days shall constitute grounds for the removal of the tower at the owner's expense.

Meets Does not meet

Meets this standard per structural analysis submitted certifying the ability of the city utility pole to support the petitioner's equipment.

3. Freestanding wireless communication or radio transmission towers shall not exceed 200 feet in height as measured from the tower base to the highest point of the tower and any attached receiving or transmitting device.

Meets Does not meet

Meets this standard, the antenna is mounted at a height of 30 feet.

4. Franchises and licenses: The operator shall provide documentation to the City to demonstrate that all franchises and licenses required by law for the construction and/or operation of a tower or antenna have been obtained.

Meets Does not meet

Meets this standard, the petitioner has provided documentation in evidence of their FCC and ICC licenses.

5. Towers shall either maintain a galvanized steel finish or, subject to any applicable standards of the FAA, be painted a neutral color (i.e., light grey) to reduce visual obtrusiveness or painted in a sky-tone above the top of surrounding trees and in an earth-tone below the treetop level.

Meets Does not meet

Meets this standard, the city utility pole is made of timber and the antenna will be painted light gray.

6. At a tower site, the design of buildings and related structures shall, to the maximum extent practicable, use materials, colors and architectural styles that blend into the natural setting and surrounding buildings.

Meets Does not meet

Standard does not apply to petitioner's request, antenna is mounted to city utility pole and there is not a communication facility building being proposed.

7. Storage: No outside storage shall be allowed on any facility site.

Meets Does not meet

Meets this standard, as no storage is proposed.

8. Lighting: Towers shall not be artificially lighted, unless required by the FAA or other applicable authority.

Meets Does not meet

Meets this standard, as no lighting is proposed.

9. A single sign measuring no more than two square feet in size shall be located on or near the tower, and shall identify the tower owner, the street address of the tower, the owner's identification code for the tower, and a twenty-four-hour emergency contact telephone number.

Meets Does not meet

The standard does not apply to the petitioner's request. The proposed antenna and meter box would be located within the city right-of-way, and as part of the petitioner's lease with the City, contact information will be available to the City at all times.

10. No commercial advertising shall be allowed on the tower or its related facilities.

Meets Does not meet

Meets this standard – no advertising or signage is proposed.

11. Single lot: Towers, guy anchors, equipment buildings, and any other appurtenances related to the tower shall be considered as being located on one zoning lot.

Meets Does not meet

The standard does not apply to the petitioner's request. The proposed antenna and meter box are located within the city right-of-way, which is not a zoning lot. The proposed meter box is similar to existing utility boxes already located in the right-of-way.

12. Setbacks: Wireless communications facilities shall comply with the following setback standards. Self supporting and monopole towers shall be setback from all property lines by a distance of 110% of the height of the tower.

Meets Does not meet

The standard does not apply to the petitioner's request. The proposed antenna and meter box are located within the city right-of-way, as opposed to a defined zoning lot.

13. Equipment buildings associated with a wireless communication facility shall meet the minimum setback requirements for the zoning district where located.

Meets Does not meet

The standard does not apply to the petitioner's request. The petitioner is not proposing to construct any equipment buildings for the subject antenna.

14. Separation: If an applicant proposes a new wireless communications tower or radio transmission tower within 1,200 feet of an existing tower, the applicant shall submit a statement indicating the reasons why the existing tower(s) was inadequate or unavailable. The Zoning Administrator shall allow the owner of such existing tower an opportunity to comment prior to making a decision.

Meets Does not meet

The standard does not apply to the petitioner's request. The petitioner is proposing to mount an antenna, which acts as a signal booster, to a city utility pole. The request is not to install a wireless communications tower or radio transmission tower.

15. Collocation: New wireless communication or radio transmission towers shall provide evidence that the tower is structurally designed to support at least three additional users, and provide a written statement that the owner of the tower is willing to permit other user(s) to attach communication facilities, on a commercially reasonable basis, which do not interfere with the primary purpose of the tower. The site plan shall indicate a location for at least one equipment building in addition to that proposed for use by the applicant. A tower which is modified or reconstructed to accommodate the collocation of an additional antenna shall be of the same tower type as the existing tower, unless a monopole is determined more appropriate at the specific location. If an existing tower is increased in height or reconstructed to accommodate the collocation of additional antenna it shall meet the height restrictions outlined within this section of the Ordinance.

Meets Does not meet

The standard does not apply to the petitioner's request. The proposed antenna would be located on a city utility pole, therefore it is not the responsibility of the petitioner to provide collocation opportunities.

16. Landscaping: Unless existing vegetation provides a buffer strip, all property lines along roadways or visible to existing abutting or nearby buildings (within 1/4 mile radius), for all facilities shall be landscaped as follows:

- a. With six-foot to eight-foot evergreen shrubs planted in an alternate pattern, five feet on center and within 15 feet of the site boundary; or
- b. With at least one row of deciduous trees, not less than 2 1/2 inch to three inches caliper measured three feet above grade, and spaced not more than 30 feet apart and within 25 feet of the site boundary; or
- c. With at least one row of evergreen trees at least four to five feet in height when planted, and spaced not more than 15 feet apart within 40 feet of the site boundary.
- d. In lieu of the foregoing, the Planning and Zoning Commission may determine that the existing vegetation must be supplemented to meet an equivalent means of achieving the desired goal of minimizing the visual impact.

Meets Does not meet

The standard does not apply to the petitioner's request. The proposed antenna and meter box are located within the city right-of-way, and therefore landscape screening would not be appropriate, as it could affect site lines.

17. Security fencing: Towers, guy anchor supports, and ground-based equipment buildings shall be enclosed by security fencing not less than eight feet in height and equipped with an appropriate anti-climbing device.

Meets Does not meet

The standard does not apply to the petitioner's request. The proposed antenna and meter box are located within the city right-of-way, and therefore 8-foot security fencing around the meter box would not be appropriate, as it could affect site lines.

18. Radiation reporting: It shall be demonstrated that the proposed tower, antenna, and supporting equipment complies with FCC nonionizing radiation requirements for individual and combined facilities.

Meets Does not meet

The petitioner submitted an affidavit stating the equipment is in compliance with this criterion.

19. Interference: No wireless communications tower, antenna, or supporting equipment shall interfere with equipment operated by the City of Crystal Lake.

Meets Does not meet

The petitioner submitted an affidavit stating the equipment is in compliance with this criterion.

Recommended Conditions:

If a motion to recommend approval of the petitioner's request is made, it should be with the

following conditions:


1. Approved plans, reflecting staff and advisory board recommendations, as approved by the City Council:
 - A. Application (Insite RE, Inc., dated 09/28/15, received 09/30/15)
 - B. FCC License Reference Copy (received 09/30/15)
 - C. Plan Set (Terra Consulting Group, dated 08/11/15, received 09/30/15)
 - D. Structural Engineer letter/analysis (Hutter Trankina Engineering, dated 09/21/15, received 09/30/15)
 - E. State of Illinois-Illinois Commerce Commission Certificate (dated 01/20/1988, received 09/30/15)
 - F. Affidavit (Insite RE, Inc., dated 09/29/15, received 09/30/15)
2. No additional structures outside of what has been submitted in this application are allowed on this city utility pole.
3. The pole shall not be artificially lighted, unless required by the FAA or other applicable authority.
4. No commercial advertising shall be allowed on the pole or its related facilities.
5. An independent evaluation shall be conducted by a radio communications company (communications engineer) to confirm the Affidavit statement that the proposed antenna does not interfere with equipment operated by the City of Crystal Lake.
6. Tornado Siren Pole and Charles Cube-HPSC must be located between the existing sidewalk and storm sewer.
7. The petitioner shall address all of the review comments and requirements of the Community Development, Public Works, Fire and Police Departments.

**City of Crystal Lake
Development Application**

Office Use Only

File # _____

Project Title: Verizon Pingree Rd. Metra Small Cell

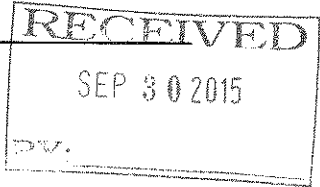

Action Requested

- | | |
|---|--|
| <input type="checkbox"/> Annexation | <input type="checkbox"/> Preliminary PUD |
| <input type="checkbox"/> Comprehensive Plan Amendment | <input type="checkbox"/> Preliminary Plat of Subdivision |
| <input type="checkbox"/> Conceptual PUD Review | <input type="checkbox"/> Rezoning |
| <input type="checkbox"/> Final PUD | <input checked="" type="checkbox"/> Special Use Permit |
| <input type="checkbox"/> Final PUD Amendment | <input type="checkbox"/> Variation |
| <input type="checkbox"/> Final Plat of Subdivision | <input type="checkbox"/> Other |

Petitioner Information

Name: Insite RE, Inc. as agent for Verizon Wireless
Address: 1S660 Midwest Rd.
Oakbrook Terrace, IL 60181
Phone: 630-890-4514 (Mark Layne)
Fax: _____
E-mail: layne@insite-inc.com

Owner Information (if different)

Name: City of Crystal Lake
Address: _____
Phone: _____
Fax: _____
E-mail: _____

Property Information

Project Description: Installation of small cell antenna on City emergency siren pole and equipment cabinet in City parkway in front of 282 Exchange.

Project Address/Location: City ROW adjacent to 282 Exchange Dr.

PIN Number(s): N/A 19-04-426-004

Development Team

Please include address, phone, fax and e-mail

Developer: Insite RE, Inc., 1S660 Midwest Rd., Oakbrook Terrace, IL 630-890-4514

Architect: None

Attorney: None

Engineer: Terra Consulting Group, 600 Busse Hwy., Park Ridge, IL 60068, 847-698-6400

Landscape Architect: None

Planner: None

Surveyor: None

Other: Braniff Communications, Inc., 4741 W. 136th St., Crestwood, IL 60445, 708-597-3200

Signatures



Mark J. Layne, Agent

09/28/15

PETITIONER: Print and Sign name (if different from owner)

Date

As owner of the property in question, I hereby authorize the seeking of the above requested action.


OWNER: Print and Sign name

Date

NOTE: If the property is held in trust, the trust officer must sign this petition as owner. In addition, the trust officer must provide a letter that names all beneficiaries of the trust.

2015 52

STATE OF ILLINOIS)
COUNTY OF MCHENRY)

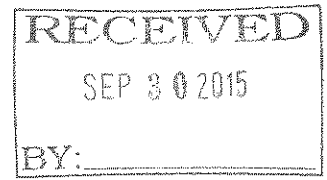

IN THE MATTER OF THE APPLICATION OF
Verizon Wireless (Mark Layne as Agent)


AFFIDAVIT

MARK LAYNE, being first duly sworn on oath deposes and states as follows:

A. That the above mentioned Petitioner has made every effort to comply with the requirements of Section 2-400 of the City of Crystal Lake Unified Development Ordinance, specifically with regard to Subsection 48(d)(i), (ii), (iii), (iv), (xiv), and (xv) as those items relate to the Safety, Height, Documentation of License, Color, RF Compliance, and Non-Interference of the proposed facility. To wit:


- 48(d)
 - (i) Safety: a structural analysis has been provided with Petitioner's application certifying to the ability of the City siren pole to support the Petitioner's equipment.
 - (ii) Height: the Petitioner's equipment will be attached at the 30' level to a then existing 47' tall City siren pole.
 - (iii) License: the Petitioner has provided documentation in evidence of their FCC and ICC licenses.
 - (iv) Color: the Petitioner's design calls for the antennas to be painted light gray.
 - (xiv) RF Compliance: the Petitioner's equipment has been designed to operate within applicable government and industry regulatory compliance standards in conformance with the Petitioner's FCC license.
 - (xv) Interference: the Petitioner's equipment has operates within a unique FCC assigned radio spectrum which has not been known to interfere with equipment operated by the City of Crystal Lake.

B. That because the proposed facility consists of the collocation of Petitioner's equipment upon what will be existing safety infrastructure owned and operated by the City of Crystal Lake, Subsections 48(b), (c), (e), (f), and (g) as well as the remaining subsections of 48(d) do not apply.


MARK LAYNE

(Printed name of Applicant, Trust, etc. here and signed above)

Subscribed and Sworn to me before
This 29 day of September, 2015.

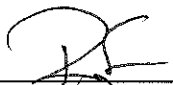

Notary Public



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PUBLIC NOTICE

**BEFORE THE PLANNING AND
ZONING COMMISSION
OF THE CITY OF CRYSTAL LAKE,
MCHENRY COUNTY, ILLINOIS**

**IN THE MATTER OF THE APPLICA-
TION OF
Insite RE, Inc/Verizon Wireless**

LEGAL NOTICE

Notice is hereby given in compliance with the Unified Development Ordinance (UDO) of the City of Crystal Lake, Illinois, that a public hearing will be held before the Planning and Zoning Commission of the City of Crystal Lake upon the application of Verizon Wireless seeking a Special Use Permit and variations to allow a wireless communication antenna on a city utility pole, located in the city right-of-way along Exchange Drive, Crystal Lake, Illinois. (X,Y): (-88.30142, 42.23367)


This application is filed for the purpose of seeking a Special Use Permit pursuant to Article 2-400 to allow a wireless communication antenna to be installed on a city utility pole and variations from Article 2-400(C)(48)(v-xii) from criteria that are not applicable to the project, as well as any other variations as necessary to complete the project as proposed. Plans for this project can be viewed at the Crystal Lake Community Development Department at City Hall.

A public hearing before the Planning and Zoning Commission for this request will be held at 7:30 p.m. on Wednesday October 21, 2015, at the Crystal Lake City Hall, 100 West Woodstock Street, at which time and place any person determining to be heard may be present.

Tom Hayden, Chairperson
Planning and Zoning Commission
City of Crystal Lake

(Published in the Northwest Herald
October 6, 2015) nw 734

CITY OF
Crystal Lake Illinois

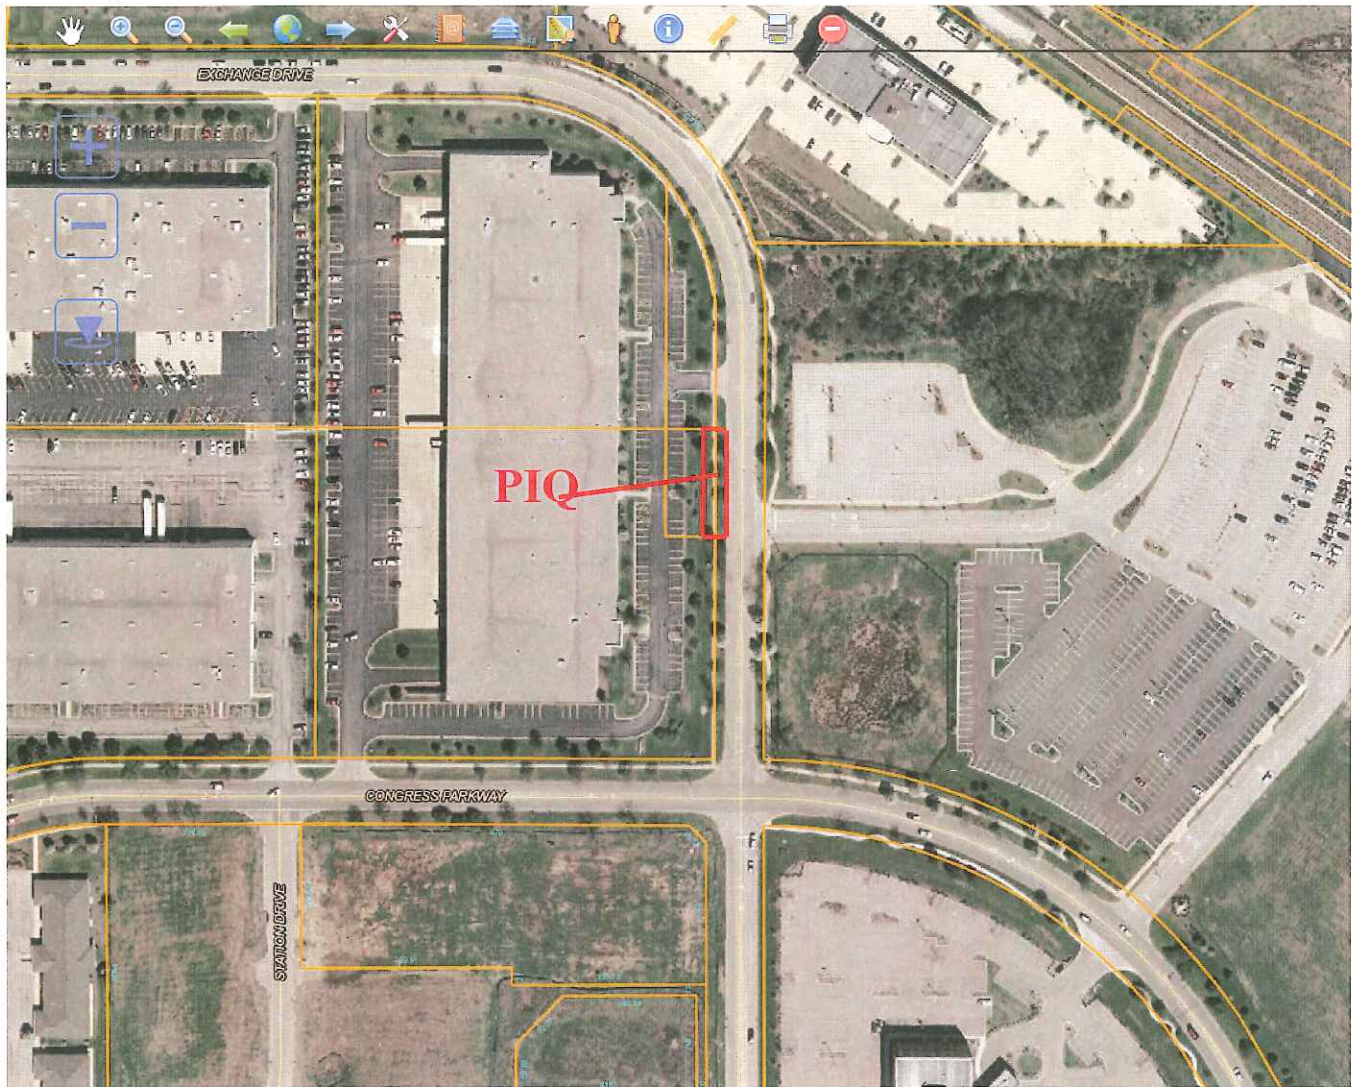

2015

RECEIVED
52 SEP 30 2015
BY:

STATE OF ILLINOIS

ILLINOIS COMMERCE COMMISSION

Illinois SMSA Limited Partnership :
 :
 Application for issuance of a : 87-0384
 Certificate of Service Authority :
 to provide a new Domestic Public :
 Cellular Radio Telecommunica- :
 tions Service to the public in :
 the Springfield, Illinois Metro- :
 politan Statistical Area, in- :
 cluding Sangamon County and por- :
 tions of Christian and Menard :
 Counties; and for other author- :
 ity and waivers of Commission :
 Rules and Regulations. :

ORDER

By the Commission:

On August 10, 1987, Illinois SMSA Limited Partnership ("Applicant") filed a verified application for a Certificate of Service Authority to provide Domestic Public Cellular Radio Telecommunications Service to the public in the Springfield, Illinois Metropolitan Statistical Area ("MSA"), and for waivers of certain rules and regulations of the Commission. At the hearing on September 15, 1987, Applicant orally amended the application to request waiver of 83 Ill. Adm. Code 240.

Pursuant to notice required by law and the rules and regulations of the Commission, this matter came on for hearing before a duly authorized Hearing Examiner of the Commission at its offices in Springfield, Illinois on September 15, 1987. At the hearing, Applicant was represented by counsel and John K. Cusack, Director - External Affairs for Ameritech Mobile Communications, Inc. ("AMCI"), testified and presented evidence on behalf of Applicant. A member of the Enforcement and Compliance Department of the Public Utilities Division of the Commission also participated in the hearing. At the conclusion of the hearing, the record was marked "Heard and Taken."

The evidence indicates that Applicant is an Illinois Limited Partnership with its principal place of business in Schaumburg, Illinois. The General Partner, with a 51% ownership interest, is Ameritech Mobile Phone Service of Illinois, Inc. ("AMPS-I"), an Illinois corporation, which has its principal place of business in Schaumburg, Illinois. The Limited Partners are as follows: Inland Cellular Telephone Co. (15.00%), an Illinois corporation

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with its principal place of business in Champaign, Illinois; Mt. Pulaski Cellular Company (15.00%), an Illinois corporation with its principal place of business in Lincoln, Illinois; U.S. West NewVector Group, Inc. (10.75%), a Colorado corporation with its principal place of business in Bellevue, Washington; and Midwest Cellular Associates (8.25%), an Illinois general partnership with its principal place of business in Mattoon, Illinois.


The evidence in this proceeding indicates that Applicant has the financial capability to construct and operate its proposed cellular system. Applicant's General and Limited Partners are affiliates of substantial and well-funded public and private corporations, who have agreed to make both initial and subsequent capital contributions pursuant to the Partnership Agreement admitted in evidence. American Information Technologies Corporation, the parent of AMCI, which in turn owns 100% of the stock of the General Partner, has stated its intention to fund and support cellular operations as shown in Applicant's Exhibit E. The Limited Partners have access to substantial financial resources through their affiliation with other companies in the telecommunications business.

Applicant's General Partner will enter into contracts with affiliates who have had substantial managerial and technical experience in the cellular industry. They currently provide Domestic Public Cellular Radio Telecommunications Services in a number of cities in five states, including Chicago. These markets include over 150 cell sites.

Applicant seeks Commission authority to provide Domestic Public Cellular Radio Telecommunications Services in the Springfield, Illinois MSA, which encompasses Sangamon County and portions of Christian and Menard Counties as described in Appendix A. The Federal Communications Commission has authorized Applicant to provide cellular telephone services in this area.

Applicant will initially construct and operate one cell site in Springfield. As the cellular market develops, Applicant may construct additional cell sites as needed. Service will be provided 24 hours a day and a combined business/sales office will be established in Springfield. Applicant has also made arrangements for customer repair and billing services.

Applicant intends to separately file tariffs to provide both retail and wholesale service on a competitive basis, pursuant to Section 13-502(b) of the Illinois Public Utilities Act ("Act") and 83 Ill. Adm. Code 745. Mr. Cusack testified that substitut-

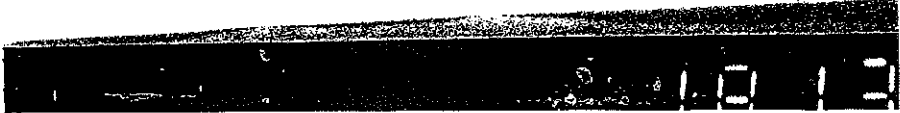

able or functionally equivalent services are available from more than one provider in the Springfield MSA. These include one and two-way (unregulated) paging, Improved Mobile Telephone Service, private and public 2-way radio and a second cellular carrier which will operate in the MSA within 18 months. Until the second carrier builds its system and inaugurates its own service, it is entitled to resell Applicant's services on equal footing with Applicant.

Applicant also requests that the Commission make certain declarations and grant certain waivers and modifications of the rules and regulations of the Commission. Section 13-101 of the Act provides that "[e]xcept to the extent modified or supplemented by the specific provisions of this Article [XIII], Articles I through V, Sections 9-221, 9-222 and 9-250, Articles X and XI of this Act are fully and equally applicable to competitive telecommunications carriers rates and services, and the regulation thereof." Section 13-502 of the Act provides that telecommunications carriers can file tariffs for the offering or provision of competitive services and the Commission has adopted 83 Ill. Adm. Code 745, implementing Section 13-502 and prescribing the procedure for telecommunications carriers to declare their services competitive. To the extent that Applicant complies with Part 745, many of the provisions of the Act as well as regulations adopted by the Commission in Title 83 of The Illinois Administrative Code will be inapplicable to Applicant, since it plans to offer only competitive services.

As a new entrant in a competitive market, Applicant does not possess significant market power. The burden of fully complying with all of the rules and regulations of this Commission generally applicable to local exchange telephone companies would be unduly harsh and would make it impossible for Applicant to effectively compete in the cellular radio telecommunications services market. Therefore, Applicant asks that the Commission either waive application or confirm the inapplicability of the provisions of 83 Ill. Adm. Code Parts 210, 220, 240, 285, 300, 305, 705, 710, 720, 725, 730 and 735.

The requested waivers would reduce the economic burdens of regulation and would not be inconsistent with the law or the purposes and policies of Article XIII of the Act. The Commission has recently approved similar waivers for other cellular providers in Dockets 87-0072 and 87-0379. Based upon a review of the foregoing, the provisions of 83 Ill. Adm. Code Parts 210, 220, 240, 285, 300, 305, 705, 710, 720, 725, 730 and 735 may properly be waived or declared inapplicable by the Commission.

The Commission, after reviewing the entire record and being fully advised in the premises, is of the opinion and finds that:

- (1) Illinois SMSA Limited Partnership is an Illinois Limited Partnership seeking a Certificate of Service Authority to provide Domestic Public Cellular Radio Telecommunications Services, within the Springfield, Illinois MSA as defined by the FCC (encompassing Sangamon County and portions of Christian and Menard Counties) as a telecommunications carrier within the meaning of Section 13-202 of the Act;
- (2) the Commission has jurisdiction over the parties and the subject matter herein;
- (3) the recitals of fact and conclusions reached in the prefatory portion of this order are supported by evidence of record and are hereby adopted as findings of fact;
- (4) Applicant possesses sufficient technical, financial and managerial resources and abilities to provide Domestic Public Cellular Radio Telecommunications Services in the Springfield, Illinois MSA;
- (5) Applicant should be directed to file a tariff pursuant to this order prior to initiating service to the public;
- (6) except as provided for in Finding (7) hereinafter, the Parts of Title 83 the Illinois Administrative Code cited by Applicant are inapplicable to a telecommunications carrier providing only competitive services to the public; based on the evidence presented herein, the services Applicant proposes to offer are competitive telecommunications services as defined in Section 13-209 of the Act; if Applicant files rates and tariffs with the Commission that are in compliance with the filing requirements for competitive services under 83 Ill. Adm. Code 745, such tariffs may become effective immediately upon filing and thereafter the Administrative Code provisions cited by Applicant will not be applicable to Applicant; to the extent that Applicant seeks additional waivers or modifications, requests must conform to the requirements of 83 Ill. Adm. Code 750;
- (7) pursuant to Section 13-402 of the Act, waiver of Parts 710 and 735 of Title 83 of the Illinois Administrative

Code should be granted to Applicant because such action will reduce the economic burdens of regulation and is not inconsistent with the Act or the purposes and policies of Article XIII.

IT IS THEREFORE ORDERED that Illinois SMSA Limited Partnership be, and is hereby, granted a Certificate of Service Authority pursuant to Articles XIII of The Illinois Public Utilities Act to provide Domestic Public Cellular Radio Telecommunications Service.

IT IS FURTHER ORDERED that the Certificate hereinabove granted shall be the following:

CERTIFICATE OF SERVICE AUTHORITY

IT IS HEREBY CERTIFIED that Illinois SMSA Limited Partnership is authorized to provide Domestic Public Cellular Radio Telecommunications Service within the Springfield, Illinois Metropolitan Statistical Area, as described in Appendix A hereto, encompassing Sangamon County and portions of Christian and Menard Counties in the State of Illinois.

IT IS FURTHER ORDERED that 83 Ill. Adm. Code 210, 220, 240, 285, 300, 305, 705, 710, 720, 725, 730 and 735 be, and the same are, inapplicable or waived, with respect to Illinois SMSA Limited Partnership.

IT IS FURTHER ORDERED that Illinois SMSA Limited Partnership shall file a tariff with the Commission in accordance with Section 13-501 and 13-502 of The Public Utilities Act prior to providing service to the general public.

By order of the Commission this 30th day of September, 1987.

EXAMINER	<i>SES</i>
SECTION CHIEF	<i>JF</i>
Supervisor of Orders	

*Mary S. Lushnell*₂

Chairman

[Signature]

SPRINGFIELD ILLINOIS CGSA

The Cellular Geographic Service Area for the Springfield Metropolitan Area may generally be described as including the territory within a line beginning at 39° 31' 20" north/ 89° 48' 00" west and extending north to 39° 39' 53" north/89°48' 00" west; then proceeding on an arc with approximately a 12 mile radius to the north north west to the furthest western point at approximately 39° 47' 30" north/ 89° 51' 50" west. The line then continues along the same arc to the north east to the furthest north point approximately 39° 57' 30" north/89° 39' 30" west; then following the same arc to the east and south to a point at 39° 48' 37" north/89° 24' 51" west. The line then proceeds due south to where it meets the Sangamon County/Christian County border; then south along this border a point where Sangamon, Christian and Montgomery Counties meet; then proceeding west along the Sangamon County/Montgomery County border to the point where Sangamon, Montgomery and Macoupin Counties meet and then continues west along the Sangamon County/Macoupin County border to the point of origin.

STATE OF ILLINOIS
ILLINOIS COMMERCE COMMISSION

Illinois SMSA Limited Partnership :
: Application for issuance of a :
: Certificate of Service Authority to :
: provide a new Domestic Public : 87-0519
: Cellular Radio Telecommunications :
: Service to the public in the areas :
: described as Bloomington, :
: Champaign/Urbana/Rantoul and Decatur, :
: Illinois Cellular Geographic :
: Service Areas. :

ORDER

By the Commission:

On November 25, 1987, Illinois SMSA Limited Partnership ("Applicant") filed a verified application for a Certificate of Service Authority to provide Domestic Public Cellular Radio Telecommunications Service to the public in the Bloomington, Champaign/Urbana/Rantoul and Decatur, Illinois Metropolitan Statistical Areas ("MSAs"). For the purposes of this Order and Certification, the territories herein discussed are designated Cellular Geographic Service Areas ("CGSAs") and the caption herein has been changed to reflect this designation.

Pursuant to notice given in accordance with the law and the rules and regulations of the Commission, this matter came on for hearing before a duly authorized Hearing Examiner of the Commission in its offices in Chicago, Illinois, on January 7, 1988. At the hearing, Applicant was represented by counsel. John K. Cusack, Director - External Affairs for Ameritech Mobile Communications, Inc. ("AMCI"), testified and presented evidence on behalf of Applicant. No other appearances were entered. At the conclusion of the hearing, the record was marked "Heard and Taken."

The evidence indicates that Applicant is an Illinois Limited Partnership with its principal place of business in Schaumburg, Illinois. The General Partner, with a 51% ownership interest, is Ameritech Mobile Phone Service of Illinois, Inc. ("AMPS-I"), an Illinois corporation, which has its principal place of business in Schaumburg, Illinois. The Limited Partners are as follows: Inland Cellular Telephone Co., an Illinois corporation with its principal place of business in Champaign, Illinois; Mt. Pulaski Cellular Company, an Illinois corporation with its principal place of business in Lincoln, Illinois; U.S. West NewVector Group, Inc., a Colorado corporation with its principal place of business in Bellevue, Washington; and Midwest Cellular

Associates, an Illinois general partnership with its principal place of business in Mattoon, Illinois. The interest of Inland Cellular Telephone Co. is in the process of being divided equally between Inland and Prairie Cellular Telephone Company. In Docket No. 87-0384, Applicant was granted a Certificate of Authority to provide cellular radio telecommunications service in Springfield, Illinois.

The evidence in this proceeding indicates that Applicant has the financial capability to construct and operate its proposed cellular system. Applicant's General and Limited Partners are affiliates of substantial and well-funded public and private corporations, who have agreed to make both initial and subsequent capital contributions pursuant to the Partnership Agreement admitted into evidence as Petitioner's Exhibit B. American Information Technologies Corporation, the parent of AMCI, which in turn owns 100% of the stock of the General Partner, has stated its intention to fund and support cellular operations as shown in Applicant's Exhibit F. The Limited Partners have access to substantial financial resources through their affiliation with other companies in the telecommunications business.

Applicant's General Partner will enter into contracts with affiliates who have substantial managerial and technical experience in the cellular industry. They currently provide Domestic Public Cellular Radio Telecommunications Services in a number of cities in five states, including Chicago and Springfield, Illinois. These markets include over 160 cell sites.

Applicant seeks Commission authority to provide Domestic Public Cellular Radio Telecommunications Services in the Bloomington, Champaign/Urbana/Rantoul and Decatur, Illinois CGSAs, as described in Appendices A, B and C attached hereto and made a part hereof. The Federal Communications Commission has authorized Applicant to provide cellular telephone services in these areas.

Applicant will initially construct and operate cell sites in each of the three CGSAs. As the cellular market develops, Applicant may construct additional cell sites as needed. Service will be provided 24 hours a day and a combined business/sales office has been established in Springfield. Applicant has also made arrangements for customer repair and billing services.

Applicant intends to separately file tariffs to provide both retail and wholesale service on a competitive basis, pursuant to Section 13-502(b) of The Illinois Public Utilities Act ("Act") and 83 Ill. Adm. Code 745. Mr. Cusack testified that substitutable or functionally equivalent services are available from more than one provider in each of the three CGSAs. These include one and two-way (unregulated) paging, Improved Mobile Telephone

Service, private and public two-way radio and a second cellular carrier which will operate in each of the three CGSAs within 18 months. Until the second carrier builds its system and inaugurates its own service, it is entitled to resell Applicant's services on equal footing with Applicant.

In Docket No. 87-0384, the Commission made certain declarations and granted to Applicant certain waivers and modifications of the rules and regulations of the Commission. Section 13-101 of the Act provides that "[e]xcept to the extent modified or supplemented by the specific provisions of this Article [XIII], Articles I through V, Sections 9-221, 9-222 and 9-250, Articles X and XI of this Act are fully and equally applicable to competitive telecommunications carriers rates and services, and the regulation thereof." Section 13-502 of the Act provides that telecommunications carriers can file tariffs for the offering of provision of competitive services and the Commission has adopted 83 Ill. Adm. Code 745, implementing Section 13-502 and prescribing the procedure for telecommunications carriers to declare their services competitive. To the extent that Applicant continues to comply with Part 745, many of the provisions of the Act as well as regulations adopted by the Commission in Title 83 of the Illinois Administrative Code will continue to be inapplicable to Applicant, since it plans to offer only competitive services.

The additional waivers granted in Docket No. 87-0384 will also continue to apply to Applicant. Applicant does not possess significant market power in the three CGSAs involved in this proceeding. The burden of fully complying with all of the rules and regulations of this Commission generally applicable to local exchange telephone companies would be unduly harsh and would make it impossible for Applicant to effectively compete in the cellular radio telecommunications services market. The waivers previously granted will continue to reduce the economic burdens of regulation and will be consistent with the law and the purposes and policies of Article XIII of the Act. The Commission has recently approved similar waivers for other cellular providers in several proceedings, including Dockets 87-0072, 87-0379, 87-0451 and 87-0452.

The Commission, having considered the entire record herein and being fully advised in the premises, is of the opinion and finds that:

- (1) Illinois SMSA Limited Partnership is an Illinois Limited Partnership seeking a Certificate of Service Authority to provide Domestic Public Cellular Radio Telecommunications Services within the Bloomington, Champaign/Urbana/Rantoul and Decatur, Illinois CGSAs as set forth in Appendices A, B and C of this Order and is

a telecommunications carrier within the meaning of Section 13-202 of The Illinois Public Utilities Act;

- (2) the Commission has jurisdiction over the parties and the subject matter herein;
- (3) Applicant possesses sufficient technical, financial and managerial resources and abilities to provide Domestic Public Cellular Radio Telecommunications Services in the Bloomington, Champaign/Urbana/Rantoul and Decatur, Illinois CGSAs;
- (4) Applicant should be directed to file a tariff pursuant to this Order prior to initiating service to the public in the Bloomington, Champaign/Urbana/Rantoul and Decatur, Illinois CGSAs;
- (5) based on the evidence presented herein, the services Applicant proposes to offer are competitive telecommunications services as defined in Section 13-209 of The Illinois Public Utilities Act; the declarations and waivers previously granted to Applicant in Docket 87-0384 should continue in effect.

IT IS THEREFORE ORDERED that Illinois SMSA Limited Partnership be, and is hereby, granted a Certificate of Service Authority pursuant to Article XIII of The Illinois Public Utilities Act to provide Domestic Public Cellular Radio Telecommunications Service.

IT IS FURTHER ORDERED that the Certificate hereby granted shall be the following:

CERTIFICATE OF AUTHORITY

IT IS HEREBY CERTIFIED that Illinois SMSA Limited Partnership is authorized to provide Domestic Public Cellular Radio Telecommunications Service within the Bloomington, Champaign/Urbana/Rantoul and Decatur, Illinois Cellular Geographic Service Areas, as described in Appendices A, B and C attached hereto, which are hereby incorporated into and made a part of this Certificate as if set forth in full herein.

IT IS FURTHER ORDERED that the declarations and waivers granted to Illinois SMSA Limited Partnership in Docket 87-0384 shall continue in effect.

IT IS FURTHER ORDERED that Illinois SMSA Limited Partnership shall file a tariff with the Commission in accordance with

87-0519

Sections 31-501 and 13-502 of The Illinois Public Utilities Act prior to providing service to the general public in its newly certificated areas.

By Order of the Commission this 20th day of January, 1988.

Nancy S. DeBorja
Chairman ²
[Signature]

EXAMINER <i>QAB</i>
SECTION CHIEF
Supervisor of Orders <i>ST</i>

APPENDIX A
BLOOMINGTON - NORMAL

The cellular Geographic Service Area for the Bloomington-Normal Metropolitan Area may generally be described as including the territory with a line beginning on the McLean/Logan County boundary at 40° 17' 02" north/89° 13' 45" West, then proceeding northeast to a point on an arc at 40° 19' 56" north/89° 10' 10" West; then proceeding along this arc, having approximately a 11.5 mile radius, to the north to the furthest west point at 40° 27' 00" north/89° 15' 00" west. The line then continues along this same arc to the north to 40° 34' 48" north/89° 10' 02" west, then proceeds due north to the McLean/Fayewell County boundary. The line then follows this boundary to the east and north to 40° 37' 50" north/89° 02' 41" west; it then proceeds east and slightly south to 40° 36' 38" north/88° 53' 30" west. The line now proceeds northeasterly paralleling the direction of the I.C.G. Railroad line yet approximately 2 miles to the west to where it intersects the McLean/Livingston County boundary at 40° 45' 25" north/88° 45' 00" west, then proceeds east along this boundary to 40° 45' 25" north/88° 40' 32" west. The line now proceeds to the southwest to 40° 37' 30" north/88° 45' 40" west, then again southwesterly to 40° 33' 59" north/88° 50' 49" west. The line now proceeds south to 40° 24' 12" north/88° 50' 35" west, then proceeds southeast to 40° 21' 00" north/88° 43' 32" west. The line continues to the south southwest to 40° 19' 05" north/88° 44' 47" west, then proceeds to the west northwest to 40° 21' 33" north/88° 52' 04" west. The line now proceeds in a slight arc to 40° 19' 32" north/88° 55' 12" west, then continues south and west along an arc to the southern most point of the arc at 40° 17' 27" north/88° 58' 26" west, then continues to the west northwest to 40° 19' 26" north/89° 06' 59" west. The line now proceeds southwest to a point on the McLean/Logan County boundary at 40° 17' 00" north/89° 09' 38" west, then follows this boundary west to the point of origin.

APPENDIX B
CHAMPAIGN - URBANA

The Cellular Geographic Service Area for the Champaign-Urbana Metropolitan Area may generally be described as including the territory within a line beginning at 39° 52' 40" north/88° 16' 21" west; then proceeding along an arcing line to the northwest to 39° 58' 38" north/88° 22' 09" west, then proceeding on a shorter arc to the northwest to 40° 01' 30" north/88° 23' 17" west. Again proceeding to the northwest on a greater arc to a point at 40° 06' 49" north/88° 25' 17" west on the Champaign/Piatt County boundary; then proceeding due north to 40° 12' 57" north/88° 25' 17" west. The line proceeds on an arc with approximately a 11 mile radius to the northeast to 40° 22' 09" north/88° 13' 26" west. The line now proceeds in a semicircle with a 4 mile radius up to the Champaign/Ford County boundary and back southeast to 40° 05' 21" north/88° 05' 08" west; then proceeding again on an arc with approximately an 11 mile radius south southeast to 40° 09' 53" north/88° 01' 07" west. The line again proceeds on a short arc to the southeast to 40° 06' 18" north/87° 56' 26" west, a point on the Champaign/Vermillion County boundary. The line then proceeds south along this boundary to where Champaign, Vermillion, Edgar and Douglas Counties meet; then proceeding west along the Champaign/Douglas County boundary to the point of origin.

APPENDIX C

DECATUR

The Cellular Geographic Service Area for the Decatur Metropolitan Area may generally be described as including the territory within a line beginning at 39° 51' 49" north/89° 13' 10" west; then proceeding east to a point on an arc at 39° 51' 49" north/89° 09' 11" west. The line then proceeds along an arc with a radius of approximately 9.5 miles to the north and east to the northern most point on the arc at 39° 58' 38" north/88° 58' 48" west, then continues along the arc to the east and south to 39° 57' 12" north/88° 52' 51" west. The line then proceeds northeast to 39° 59' 29" north/88° 50' 36" west, then continues to the east northeast on a gradual arc to the Macon/Piatt County boundary at 40° 01' 20" north/88° 44' 33" west. The line then proceeds south along the boundary to 39° 59' 50" north/88° 44' 33" west, then continues southwest on a slight arc to 39° 58' 22" north/88° 48' 10" west and then onward to the southwest to the beginning point of an arc at 39° 55' 44" north/88° 50' 36" west. The line then proceeds along an arc with a radius of approximately 9.5 miles southward to the end of the arc at 39° 48' 35" north/88° 48' 30" west, then proceeds on a slight arc to a point on the Macon/Piatt County boundary at 39° 48' 10" north/88° 44' 33" west. The line then proceeds southwest to a point on the Macon/Moultrie County boundary at 39° 44' 11" north/88° 48' 35" west, then along that boundary south to 39° 42' 35" north/88° 48' 35" west, and then proceeds northwest to the beginning of an arc at 39° 44' 50" north/88° 51' 27" west. The line proceeds to follow this arc having approximately a 9.5 mile radius, to the west and south to the end point of the arc at 39° 43' 01" north/88° 58' 45" west, then continues almost due south to a point on the Macon/Shelby County boundary at 39° 39' 12" north/88° 59' 47" west; then proceeds along this boundary to the west to 39° 39' 12" north/89° 01' 29" west. The line now continues to the north and slightly east to 39° 42' 27" north/89° 00' 54" west, then proceeds due west to a point on the Macon/Christian County boundary at 39° 40' 28" north/89° 08' 30" west. The line continues along the Macon/Christian County boundary to the north to 39° 42' 56" north/89° 08' 30" west, then proceeds northeast to 39° 43' 38" north/89° 06' 32" west, then continues due north to a point on an arc at 39° 45' 00" north/89° 06' 32" west and then proceeds along this arc to the northwest intersecting with the Macon/Christian County boundary at 39° 48' 00" north/89° 08' 33" west and then continues to the end of the arc at 39° 49' 36" north/89° 09' 51" west. The line then proceeds west northwest to a point on the Macon/Sangamon County boundary at 39° 50' 13" north/89° 13' 10" west, then proceeds north along this boundary to the point of origin.

REFERENCE COPY

This is not an official FCC license. It is a record of public information contained in the FCC's licensing database on the date that this reference copy was generated. In cases where FCC rules require the presentation, posting, or display of an FCC license, this document may not be used in place of an official FCC license.



Federal Communications Commission
Wireless Telecommunications Bureau

RADIO STATION AUTHORIZATION

2015 52
RECEIVED
SEP 30 2015
BY:

LICENSEE: CELLCO PARTNERSHIP

ATTN: REGULATORY
CELLCO PARTNERSHIP
1120 SANCTUARY PKWY, #150 GASA5REG
ALPHARETTA, GA 30009-7630

Call Sign KNLF207	File Number 0003864847
Radio Service CW - PCS Broadband	

FCC Registration Number (FRN): 0003290673

Grant Date 08-15-2005	Effective Date 06-11-2009	Expiration Date 06-23-2015	Print Date 06-11-2009
Market Number MTA003	Channel Block B	Sub-Market Designator 11	
Market Name Chicago			
1st Build-out Date	2nd Build-out Date	3rd Build-out Date	4th Build-out Date

Waivers/Conditions:

This authorization is subject to the condition that, in the event that systems using the same frequencies as granted herein are authorized in an adjacent foreign territory (Canada/United States), future coordination of any base station transmitters within 72 km (45 miles) of the United States/Canada border shall be required to eliminate any harmful interference to operations in the adjacent foreign territory and to ensure continuance of equal access to the frequencies by both countries.

This authorization is subject to the condition that the remaining balance of the winning bid amount will be paid in accordance with Part 1 of the Commission's rules, 47 C.F.R. Part 1.

Conditions:

Pursuant to §309(h) of the Communications Act of 1934, as amended, 47 U.S.C. §309(h), this license is subject to the following conditions: This license shall not vest in the licensee any right to operate the station nor any right in the use of the frequencies designated in the license beyond the term thereof nor in any other manner than authorized herein. Neither the license nor the right granted thereunder shall be assigned or otherwise transferred in violation of the Communications Act of 1934, as amended. See 47 U.S.C. § 310(d). This license is subject in terms to the right of use or control conferred by §706 of the Communications Act of 1934, as amended. See 47 U.S.C. §606.

This license may not authorize operation throughout the entire geographic area or spectrum identified on the hardcopy version. To view the specific geographic area and spectrum authorized by this license, refer to the Spectrum and Market Area information under the Market Tab of the license record in the Universal Licensing System (ULS). To view the license record, go to the ULS homepage at <http://wireless.fcc.gov/uls/index.htm?job=home> and select "License Search". Follow the instructions on how to search for license information.




HUTTER TRANKINA ENGINEERING
CONSULTING STRUCTURAL ENGINEERS

32 W 273 Army Trail Road, Suite # 100, Wayne, IL 60184

Phone: 630-513-6711 Fax: 630-513-2925
htedesign.com

September 21, 2015

Mr. Michael Callaghan
Terra Consulting Group, Ltd.
600 Busse Highway
2nd Floor
Park Ridge, IL 60068-2568

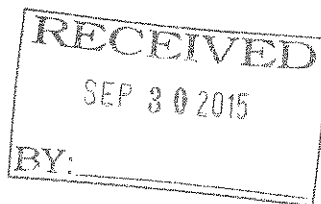

2015 52

Re: VZN: Pingree Rd Metra SC – Wood Pole
Loc. # 292279 / Terra # 88063
Hutter Trankina # 15381

Dear Mr. Callaghan:

Per your request, we have analyzed the above-referenced pole, which will be located in Crystal Lake, Illinois. The following paragraphs summarize our findings.

PURPOSE

The purpose of this analysis was to verify the structural adequacy of a new utility pole to resist the proposed equipment loads.

DESCRIPTION

The proposed pole shall be a 55' long, class 1 Southern Yellow Pine. The analysis was performed assuming a standard embedment of 7'-6"; thus, the pole will extend approximately 47'-6" above grade. We assumed the pole embedment is sufficient to support all loads.

ANTENNA CONFIGURATION

The following antenna layout was employed in the analysis:

<u>Elevation</u>	<u>Antenna or Appurtenance</u>	<u>Qty.</u>
30'	Amphenol QXW63206340BFEDIN	3
Varies	Coax Sleeve	1

Page 2
September 21, 2015
VZN: Pingree Rd Metra SC
Loc. # 292279 / Terra # 88063
Hutter Trankina # 15381

ANALYSIS PROCEDURE AND RESULTS

The pole was subjected to the ANSI C2-2007 (NESC 2007) Code standards. The following two (2) loading cases were considered:

- I. Rule 250B – Grade B: Forces due to a wind speed of 40 mph in conjunction with ½” ice build-up around all elements (i.e. Heavy Loading District); and
- II. Rule 250C – Grade B: Forces due to a wind speed of 90 mph.


Pole Rating: 43%

CONCLUSION


Based on the performed calculations, the utility pole is structurally acceptable to resist the wind loads imposed by the proposed equipment.

Should you have any questions regarding this report or require further analysis, please feel free to contact us.


Sincerely,

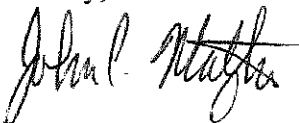

John C. Matzke
Project Engineer

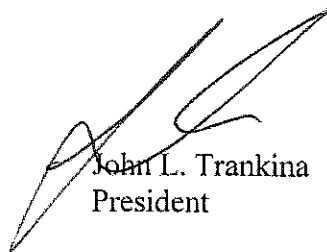

John L. Trankina
President

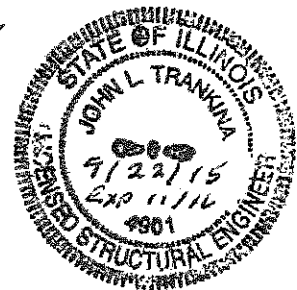

Structural Calculations

For

Verizon Loc. # 292279

Pingree Rd Metra SC

Crystal Lake, Illinois

September 21, 2015




PREPARED BY:
HUTTER TRANKINA ENGINEERING
32 W 273 Army Trail Road, Suite 100, Wayne, IL 60184

Phone: 630-513-6711 Fax: 630-513-2925
htedesign.com

Project # 15381

O-Calc® Pro Analysis Report

File Name:	15381 O-Calc.pplx	Pole Length / Class:	55 / 1	Code:	NESC
Pole Num:	Unset	Pole Species:	SOUTHERN PINE	NESC Rule:	Rule 250B
Aux Data 1	Unset	Setting Depth (ft):	7.50	Const. Grade:	B
Aux Data 2	Unset	G/L Circumference (in):	45.90	Load District:	Heavy
Aux Data 3	Unset	G/L Fiber Stress (psi):	8,000	Ice Thickness (in):	0.50
Aux Data 4	Unset	Allowable Stress (psi):	5,200	Wind Speed (mph):	39.53
Aux Data 5	Unset	Fiber Stress Ht. Reduction:	No	Wind Pressure (psf):	4.00

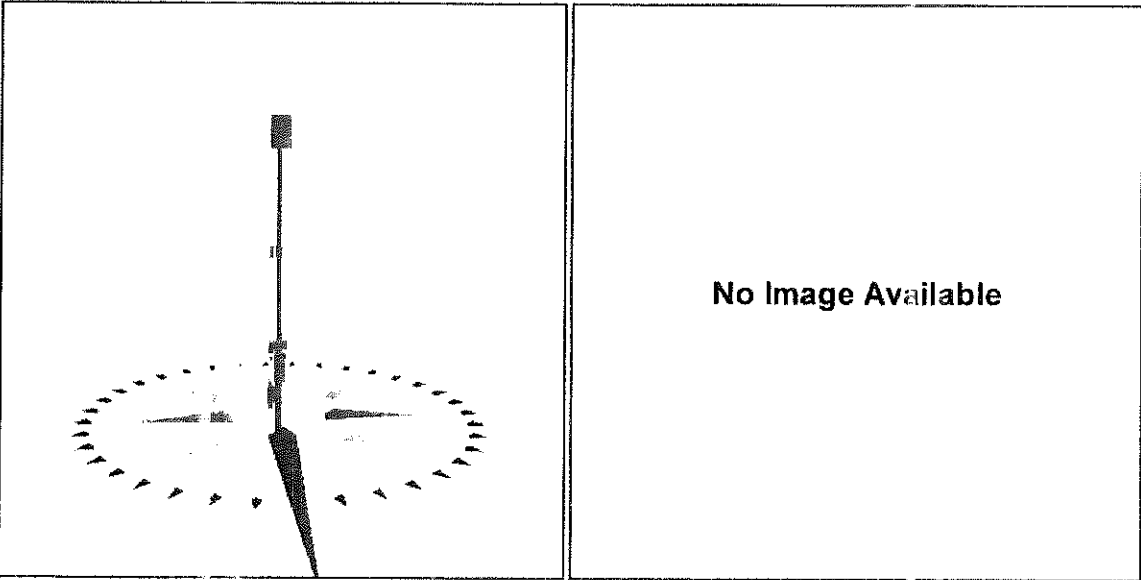

Pole Capacity Utilization	
Maximum:	26.1%
Groundline:	26.1%
Vertical:	10.9%

Pole Moments	
Max Capac. Util:	33,868 ft-lb
Groundline:	33,868 ft-lb

GROUNDLINE LOAD SUMMARY: *Wind at 20.0°, Applied Moment 33,868 ft-lb at 20.1°, Allowable Moment

	Shear Load (lbs)*	Percent Applied Load	Bending Moment (ft-lb)	Percent of Applied Moment	Percent of Pole Capacity	Bending Stress (+/-psi)	Vertical Load (lbs)	Vertical Stress (psi)
Generic Equipment:	718	61.0	23,903	70.6	18.0	937	1,752	
Pole:	459	39.0	9,965	29.4	7.5	390	3,209	
Pole Load:	1,177	100.0	33,868	100.0	25.5	1,327	4,961	
Pole Reserve Capacity:			98,840		74.5	3,873		

Version: 4.11.2/4.11

* includes Load Factor(s)

¹ Worst Wind Per Guy Wire (Guy LF)

² Worst Wind per Guy Wire (Pole LF)

³ Wind at 20.0° (Guy LF)

LOAD SUMMARY BY OWNER

<Undefined>:	718	23,903	937	1,752
Pole:	459	9,965	390	3,209
Totals	1,177	33,868	1,327	4,961

Detailed Load Components

Generic Equipment:	Owner	Height (ft)	Horiz. Offset (in)	Offset Angle (deg)	Rotate Angle (deg)	Unit Weight (lbs)	Unit Height (in.)	Unit Depth (in)	Unit Diameter (in)	Unit Length (in)	Tension Moment (ft-lb)*
Box	Siren	50.30	24.62	0.0	0.0	450.00	67.00	41.00	-	37.00	-
Box	Siren Antenna	37.00	17.46	90.0	0.0	10.00	104.00	1.00	-	1.00	-
Box	Amphenol QXW632634BFEDIN	30.00	16.96	0.0	0.0	11.00	23.20	7.10	-	12.00	-
Box	Amphenol QXW632634BFEDIN	30.00	16.96	90.0	0.0	11.00	23.20	7.10	-	12.00	-
Box	Amphenol QXW632634BFEDIN	30.00	16.96	180.0	0.0	11.00	23.20	7.10	-	12.00	-
Cylinder	Coax Sleeve	24.00	12.79	0.0	0.0	50.00	573.00	-	2.00	-	-
Box	Siren Battery Cabinet	14.00	20.01	0.0	0.0	150.00	11.00	15.19	-	28.00	-
Box	Siren Control Box	10.00	21.14	0.0	0.0	150.00	62.50	16.94	-	23.50	-
Box	AC Box	13.00	17.48	90.0	0.0	150.00	23.00	10.00	-	11.00	-
Box	Disconnect	11.00	16.61	90.0	0.0	150.00	9.00	8.00	-	8.00	-
Box	Electric Meter	3.00	17.62	90.0	0.0	25.00	24.00	9.00	-	12.00	-
Totals:											0

Pole Buckling

Buckling Constant	Buckling Column Hgt (ft)	Buckling Section Height (% Buckling Col Hgt.)	Buckling Section Diam. (in)	Min. Buckling Diam. at GL (in)	Diameter at Tip (in)	Diameter at GL (in)	Modulus of Elasticity (psi)	Pole Density (pcf)	Ice Density (pcf)	Pole Tip Height (ft)	Buckling Lc Capacity at (lbs)
2.00	25.39	33.30	13.54	19.62	8.60	14.62	1,600,000	60.00	57.00	47.50	45.1


Legend

Insulators/Attachment dimensions

	Dimension 1	Dimension 2
Pin	Body Length	Diameter
Post	Body Length	Diameter
Underhung	Body Length	Diameter
Bolt	Length	Width
Spool	Width	Height

O-Calc® Pro Analysis Report

File Name:	15381 O-Calc.pplx	Pole Length / Class:	55 / 1	Code:	NESC
Pole Num:	Unset	Pole Species:	SOUTHERN PINE	NESC Rule:	Rule 250C
Aux Data 1	Unset	Setting Depth (ft):	7.50	Const. Grade:	B
Aux Data 2	Unset	G/L Circumference (in):	45.90	Load District:	Special
Aux Data 3	Unset	G/L Fiber Stress (psi):	8,000	Ice Thickness (in):	0.00
Aux Data 4	Unset	Allowable Stress (psi):	6,000	Wind Speed (mph):	90.00
Aux Data 5	Unset	Fiber Stress Ht. Reduction:	No	Wind Pressure (psf):	20.74

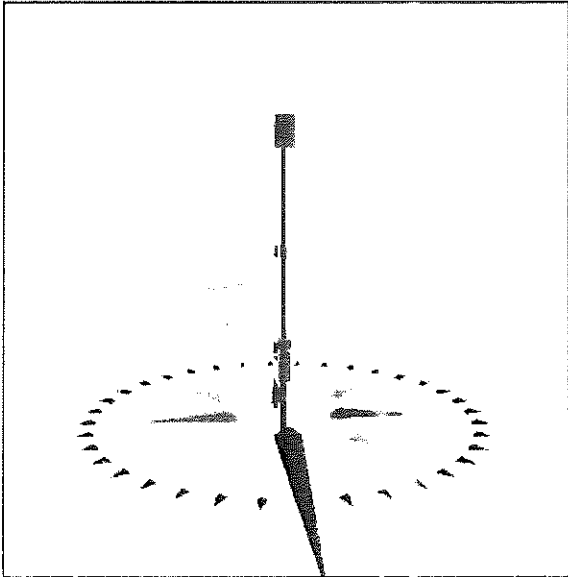

No Image Available

Pole Capacity Utilization	
Maximum:	42.7%
Groundline:	42.7%
Vertical:	6.3%

Pole Moments	
Max Capac. Util:	64,846 ft-lb
Groundline:	64,846 ft-lb

GROUNDLINE LOAD SUMMARY: *Wind at 60.0°, Applied Moment 64,846 ft-lb at 59.5°, Allowable Momen

	Shear Load (lbs)*	Percent Applied Load	Bending Moment (ft-lb)	Percent of Applied Moment	Percent of Pole Capacity	Bending Stress (+/-psi)	Vertical Load (lbs)	Ve Si (
Generic Equipment:	1,375	60.9	45,720	70.5	29.9	1,791	1,168	
Pole:	831	39.1	19,126	29.5	12.5	749	2,140	
Pole Load:	2,256	100.0	64,846	100.0	42.3	2,541	3,308	
Pole Reserve Capacity:			88,279		57.7	3,459		

Version: 4.11.2/4.11

* Includes Load Factor(s)

¹ Worst Wind Per Guy Wire (Guy LF)

² Worst Wind per Guy Wire (Pole LF)

³ Wind at 60.0° (Guy LF)

LOAD SUMMARY BY OWNER

<Undefined>:	1,375	45,720	1,791	1,168
Pole:	881	19,126	749	2,140
Totals	2,256	64,846	2,541	3,308

Detailed Load Components

Generic Equipment:	Owner	Height (ft)	Horiz. Offset (in)	Offset Angle (deg)	Rotate Angle (deg)	Unit Weight (lbs)	Unit Height (in)	Unit Depth (in)	Unit Diameter (in)	Unit Length (in)	Tension Moment (ft-lb)*
Box	Siren	50.30	24.62	0.0	0.0	450.00	67.00	41.00	-	37.00	-
Box	Siren Antenna	37.00	17.46	90.0	0.0	10.00	104.00	1.00	-	1.00	-
Box	Amphenol QKW632634BFEDIN	30.00	16.96	0.0	0.0	11.00	23.20	7.10	-	12.00	-
Box	Amphenol QKW632634BFEDIN	30.00	16.96	90.0	0.0	11.00	23.20	7.10	-	12.00	-
Box	Amphenol QKW632634BFEDIN	30.00	16.96	180.0	0.0	11.00	23.20	7.10	-	12.00	-
Cylinder	Coax Sleeve	24.00	12.79	0.0	0.0	50.00	576.00	-	2.00	-	-
Box	Siren Battery Cabinet	14.00	20.01	0.0	0.0	150.00	18.00	15.19	-	28.00	-
Box	Siren Control Box	10.00	21.14	0.0	0.0	150.00	62.50	16.94	-	23.50	-
Box	AC Box	13.00	17.48	90.0	0.0	150.00	23.00	10.00	-	11.00	-
Box	Disconnect	11.00	16.61	90.0	0.0	150.00	8.00	8.00	-	8.00	-
Box	Electric Meter	3.00	17.62	90.0	0.0	25.00	24.00	9.00	-	12.00	-
Totals:											0

Pole Buckling

Buckling Constant	Buckling Column Hgt (ft)	Buckling Section Height (% Buckling Col. Hgt.)	Buckling Section Diam. (in)	Min. Buckling Diam. at GL (in)	Diameter at Tip (in)	Diameter at GL (in)	Modulus of Elasticity (psi)	Pole Density (pcf)	Ice Density (pcf)	Pole Tip Height (ft)	Buckling Lc Capacity at L (lbs)
2.00	25.39	33.30	13.54	15.45	8.60	14.62	1,600,000	60.00	57.00	47.50	52,600

Legend

Insulators/Attachment dimensions

	Dimension 1	Dimension 2
Pin	Body Length	Diameter
Post	Body Length	Diameter
Underhung	Body Length	Diameter
Bolt	Length	Width
Spool	width	Height

CONSULTANT TEAM



PROJECT CONSULTANT: TERRA CONSULTING GROUP, LTD.
600 BUSSE HIGHWAY
PARK RIDGE, IL 60068
(847) 698-6400

STRUCTURAL:

PROJECT TYPE

PROPOSED VERIZON WIRELESS SMALL CELL EQUIPMENT AND ANTENNA ON EXISTING UTILITY POLE.

SITE COORDINATES:
LATITUDE: 42° 14' 01.20" N (1A CERTIFICATON)
LONGITUDE: 88° 18' 05.09" W (1A CERTIFICATON)
ELEVATION: ±905' (1A CERTIFICATON)

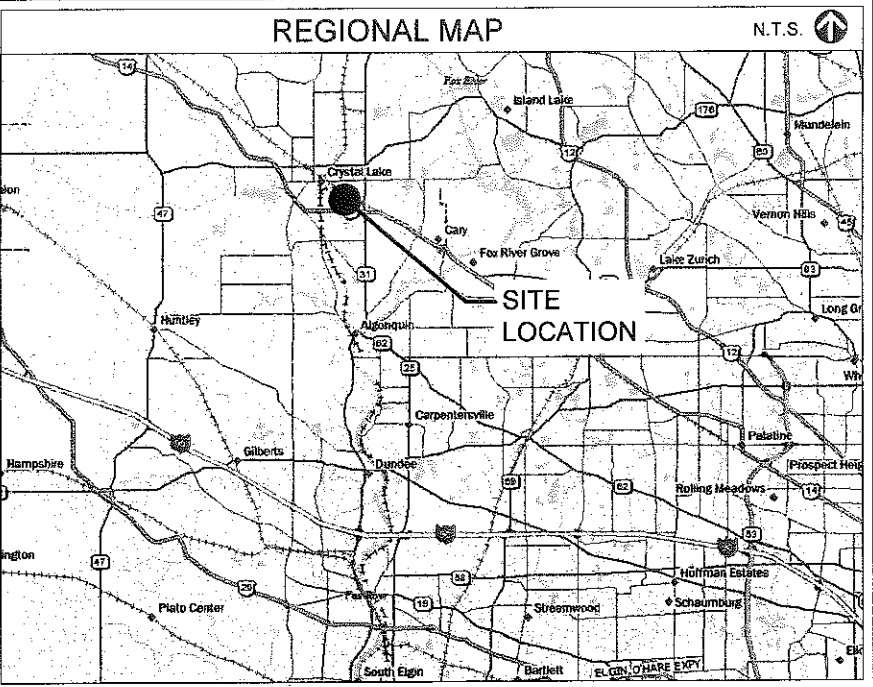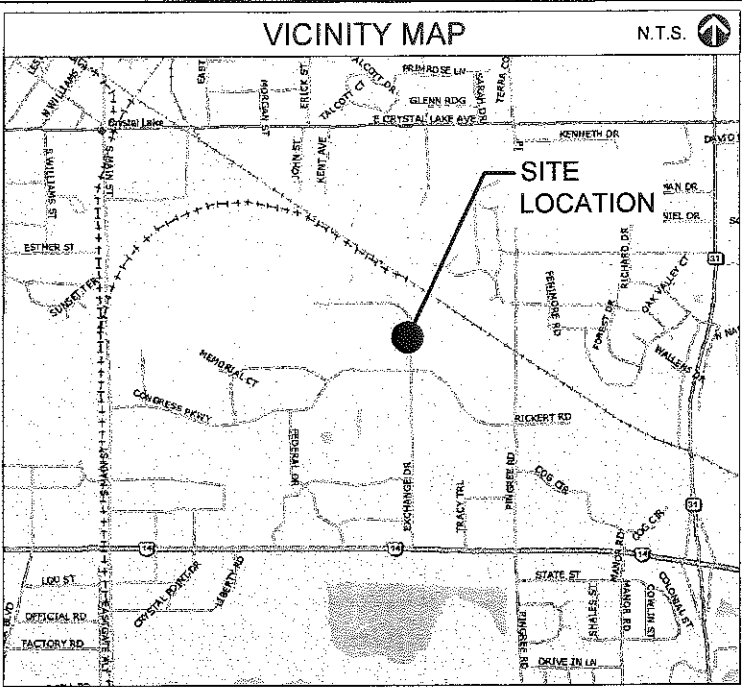

APPROVALS

REAL ESTATE: _____

RF: _____

CONSTRUCTION: _____

OPERATIONS: _____

EQUIPMENT ENGINEERING: _____

CHICAGO SMSA
limited partnership
d/b/a VERIZON WIRELESS

TERRA CONSULTING GROUP, LTD.
600 BUSSE HIGHWAY
PARK RIDGE, IL 60068
PH: 847-698-6400
FAX: 847-698-6401

CHICAGO SMSA

limited partnership

CHICAGO SMSA LIMITED PARTNERSHIP
d/b/a VERIZON WIRELESS
1515 WOODFIELD ROAD, SUITE 1400
SCHAUMBURG, ILLINOIS 60173
PHONE: (847) 619-5397 FAX: (847) 706-7415

LOCATION NUMBER: 292279

SITE NAME: PINGREE ROAD METRA SC

282 EXCHANGE DRIVE
CRYSTAL LAKE, IL 60014

PROJECT INFORMATION

PROJECT #: 20141048397
UTILITIES: POWER: COMED FIBER: WOW
JURISDICTION: CITY OF CRYSTAL LAKE
OCCUPANCY: UNINHABITED
ZONING: -
CONSTRUCTION TYPE: CO LO
PROPERTY OWNER: -

APPLICANT: CHICAGO SMSA
limited partnership
d/b/a Verizon Wireless
1515 WOODFIELD ROAD
SCHAUMBURG, IL 60173

CONSTRUCTION MANAGER: JASON EISELEIN (847) 706-7118
REAL ESTATE MANAGER: KATHY COGSWELL (847) 619-4270

SHEET	DRAWING INDEX	REVISION
T-1	TITLE SHEET	-
LP-1	AERIAL LOCATION & EXHIBIT PHOTO	-
ANT-1	EXISTING SITE ELEVATIONS	-
ANT-2	PROPOSED SITE ELEVATIONS	-
ANT-3	PROPOSED ANTENNA CONFIGURATION	-
ANT-4	ANTENNA & EQUIPMENT DETAILS	-
ANT-5	CABINET INFORMATION AND DETAILS	-
E-1	UTILITY ROUTING DETAILS	-
E-2	GROUNDING PLAN & DETAILS	-
S-1	STRUCTURAL DETAILS	-
SP-1	SPECIFICATIONS	-

RECEIVED
SEP 30 2015
BY: _____

FULL SCALE PRINT IS ON 22"x34" MEDIA

REVISIONS

NO.	DESCRIPTION	DATE	BY
1	ISSUED FOR REVIEW	08/11/15	LRB

LOC# 292279
PINGREE RD.
METRA SC

282 EXCHANGE DR.
CRYSTAL LAKE, IL 60014


DRAWN BY: MPC
CHECKED BY: TAZ
DATE: 06/26/15
PROJECT #: 88-063

SHEET TITLE
TITLE SHEET


SHEET NUMBER
T-1



2015 52

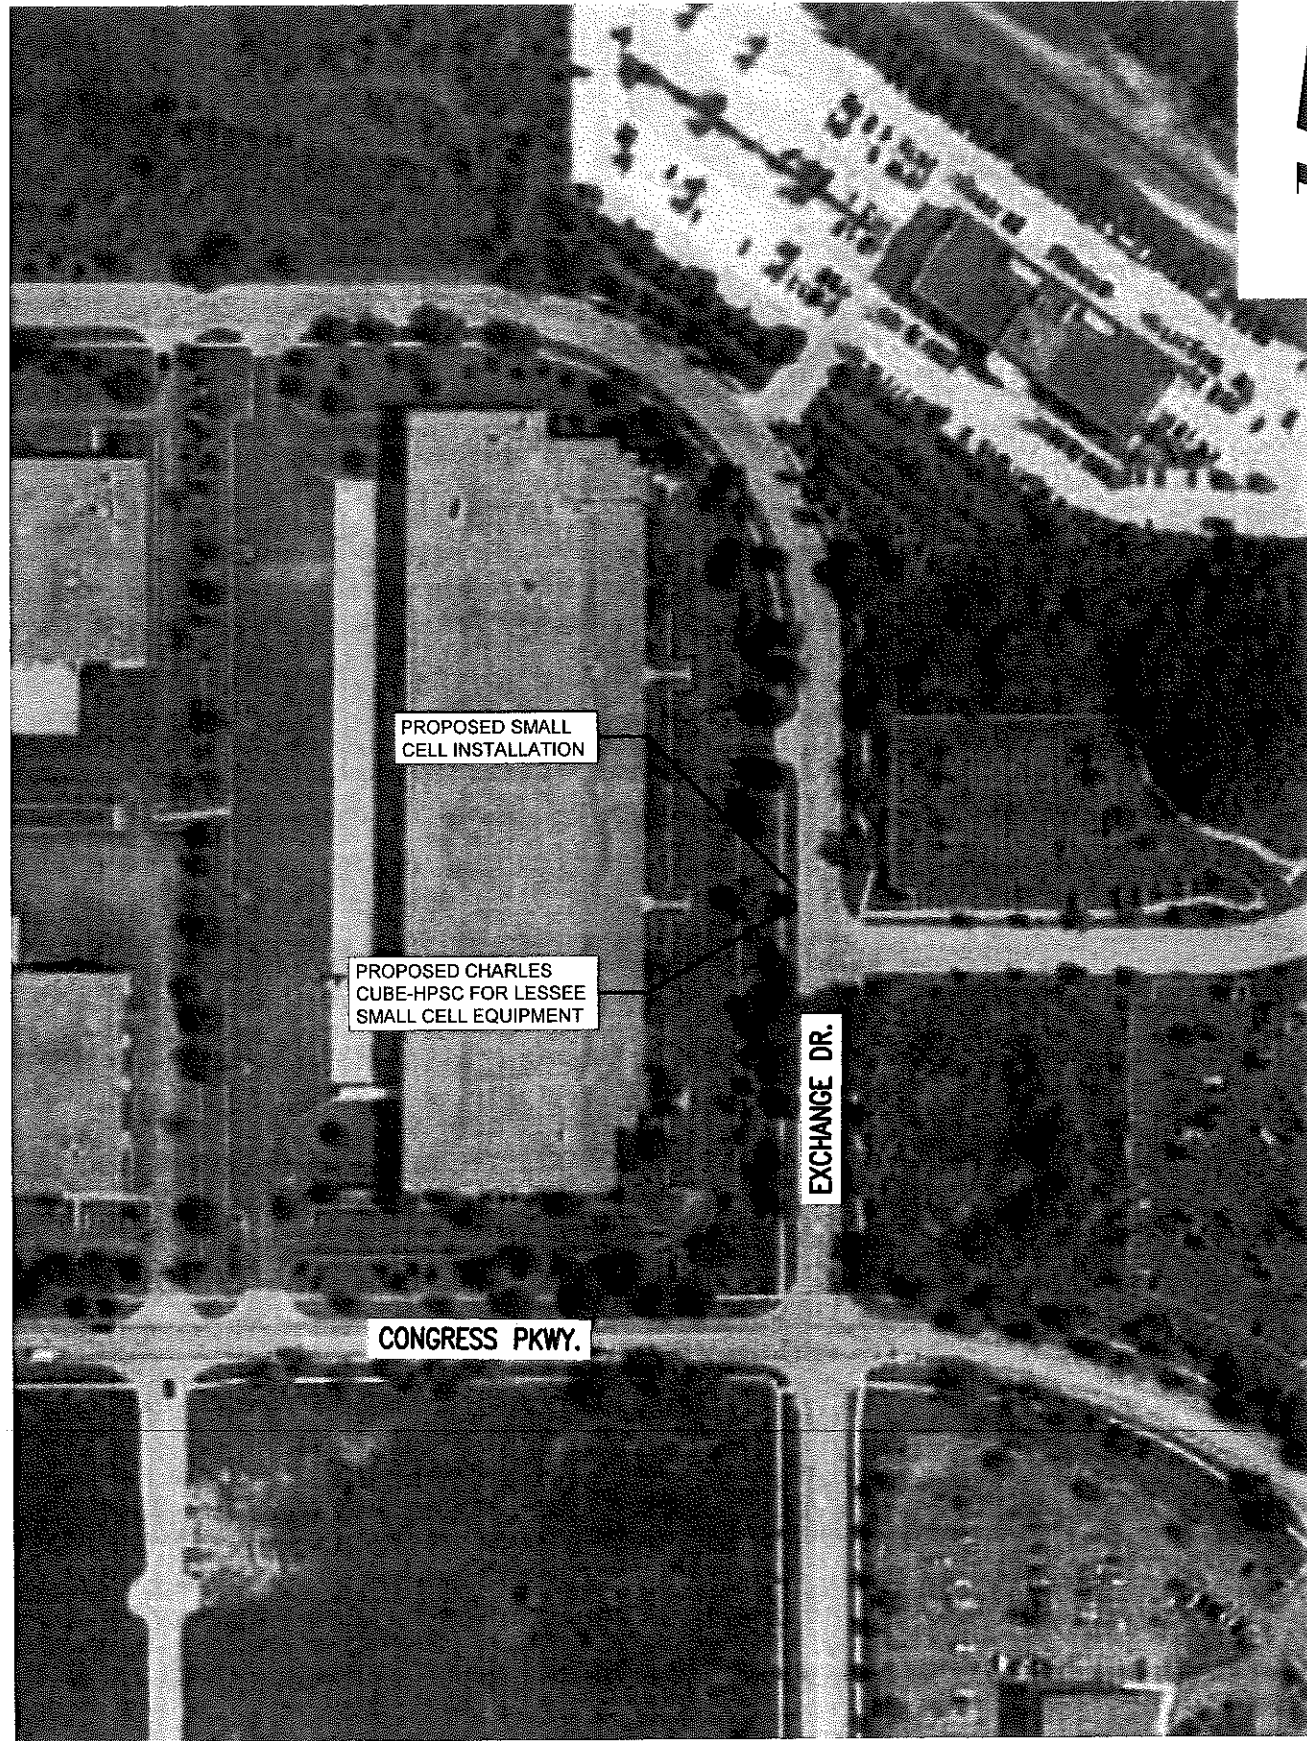

1 AERIAL LOCATION
SCALE: N.T.S.

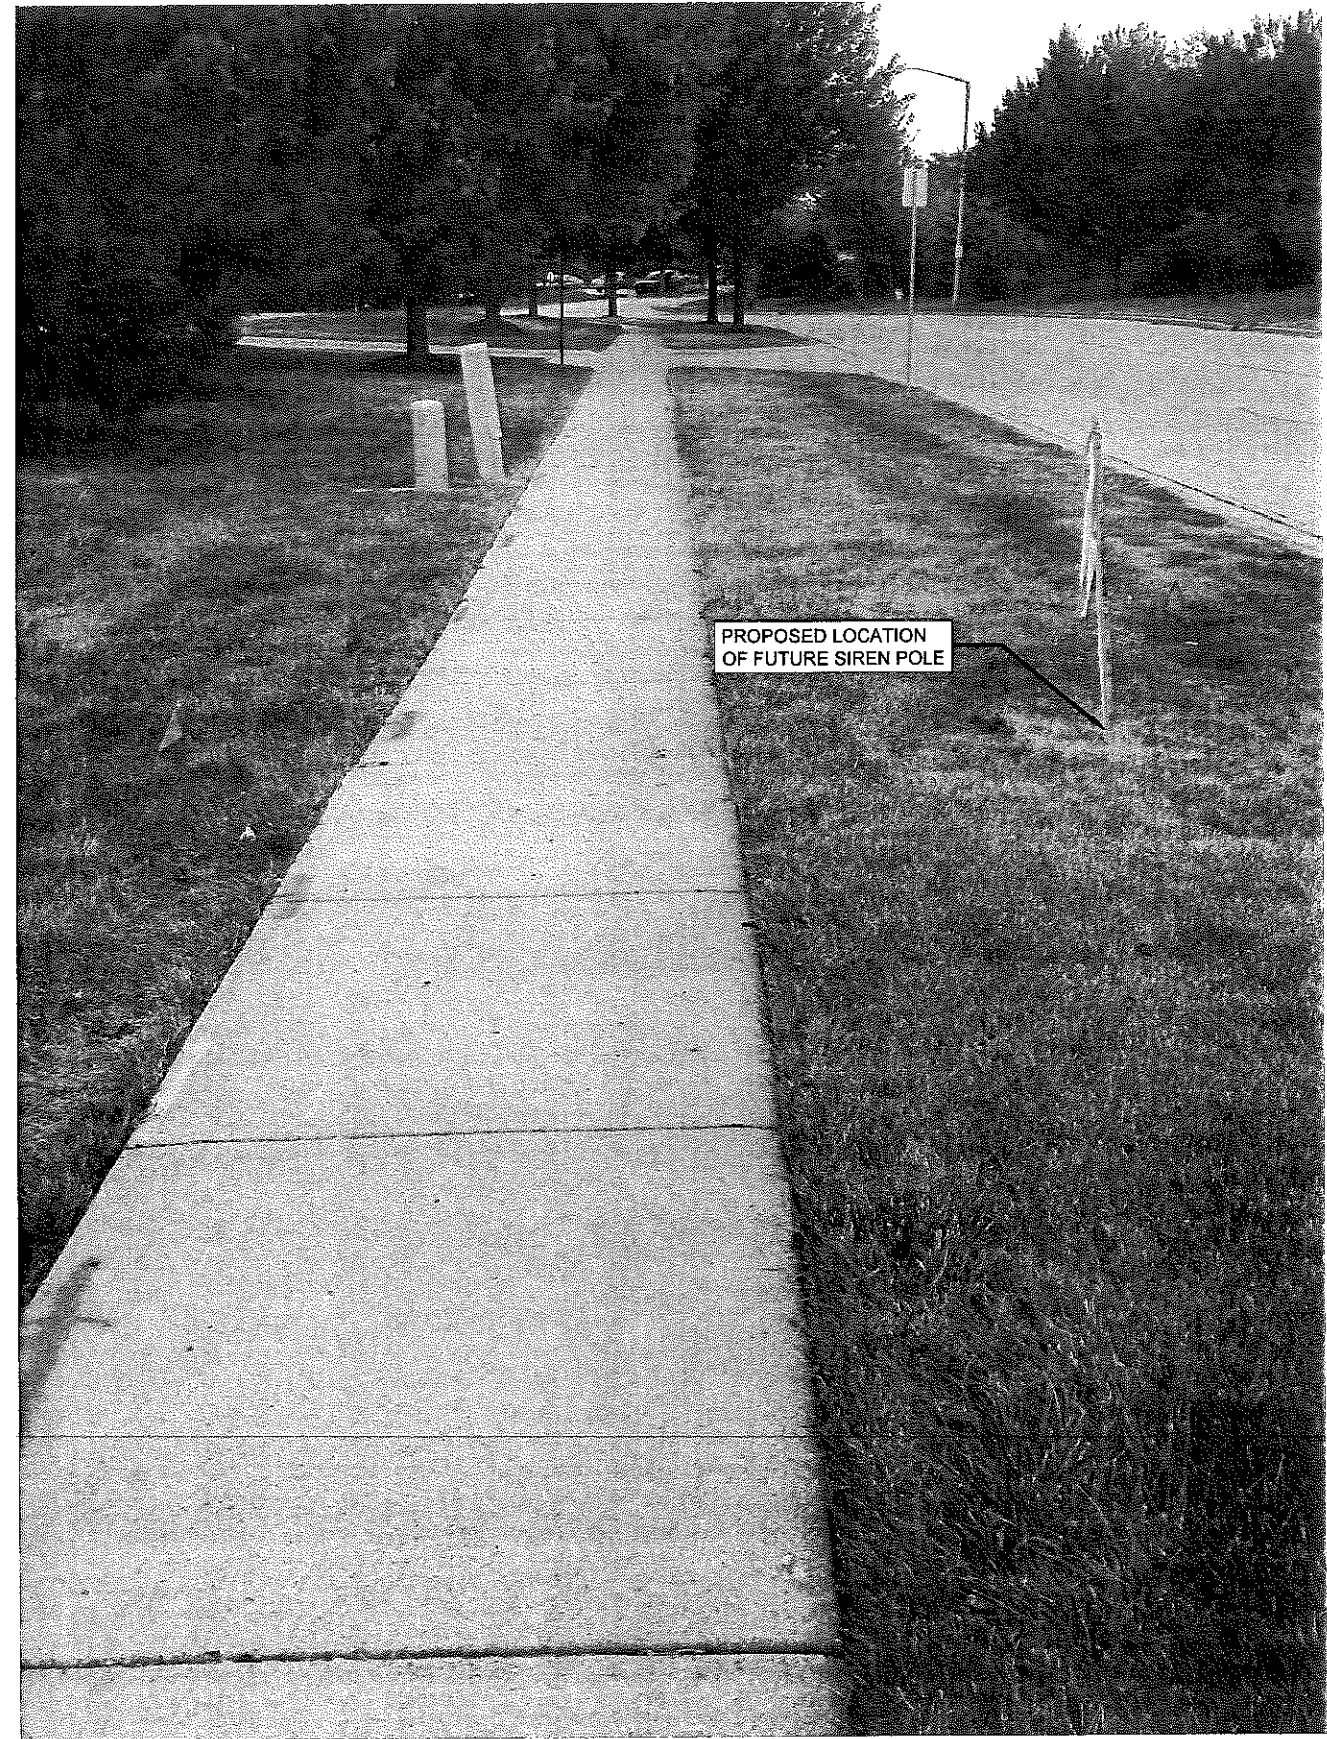

2 EXHIBIT PHOTO OF POLE
SCALE: N.T.S.

**CHICAGO
SMSA**
limited partnership
d/b/a VERIZON WIRELESS

TERRA
COMMUNICATIONS GROUP, LLC
600 BUSSE HIGHWAY
PARK RIDGE, IL 60068
PH: 847-698-6400
FAX: 847-698-6401

NO.	REVISIONS	DESCRIPTION	DATE	BY	
				ISSUED FOR REVIEW	LRB
			08/11/15		


LOC# 292279
PINGREE RD.
METRA SC

282 EXCHANGE DR.
CRYSTAL LAKE, IL 60014


DRAWN BY: MPC
CHECKED BY: TAZ
DATE: 06/26/15
PROJECT #: 88-063

SHEET TITLE
AERIAL LOCATION &
EXHIBIT PHOTO

SHEET NUMBER
LP-1

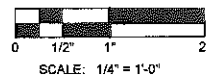


22" x 34" PRINT IS THE FULL SCALE
FORMAT. ANY SIZE OTHER THAN
THAT IS AT REDUCED SCALE.

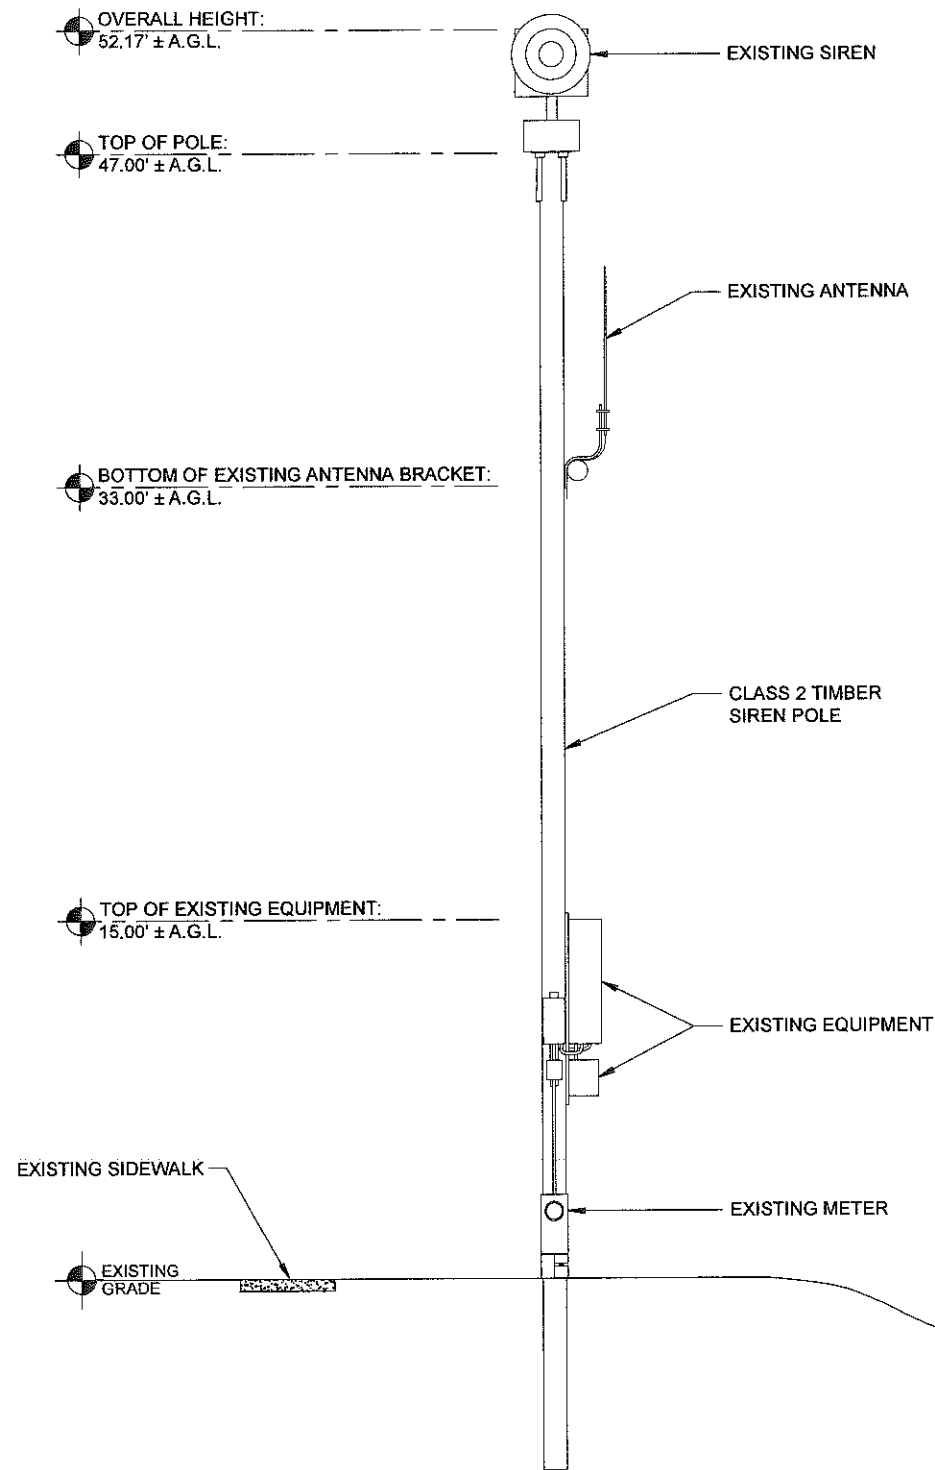


1 EXISTING SOUTH ELEVATION
SCALE: 1/4" = 1'-0" ±

NOTE:
THIS DRAWING IS FOR EXHIBIT
AND LAYOUT PURPOSES ONLY.

PLEASE REFER TO STRUCTURAL
REPORT PREPARED BY HUTTER
FRANKINA ENGINEERING.

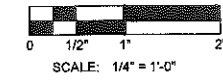

22" x 34" PRINT IS THE FULL SCALE
FORMAT. ANY SIZE OTHER THAN
THAT IS AT REDUCED SCALE.

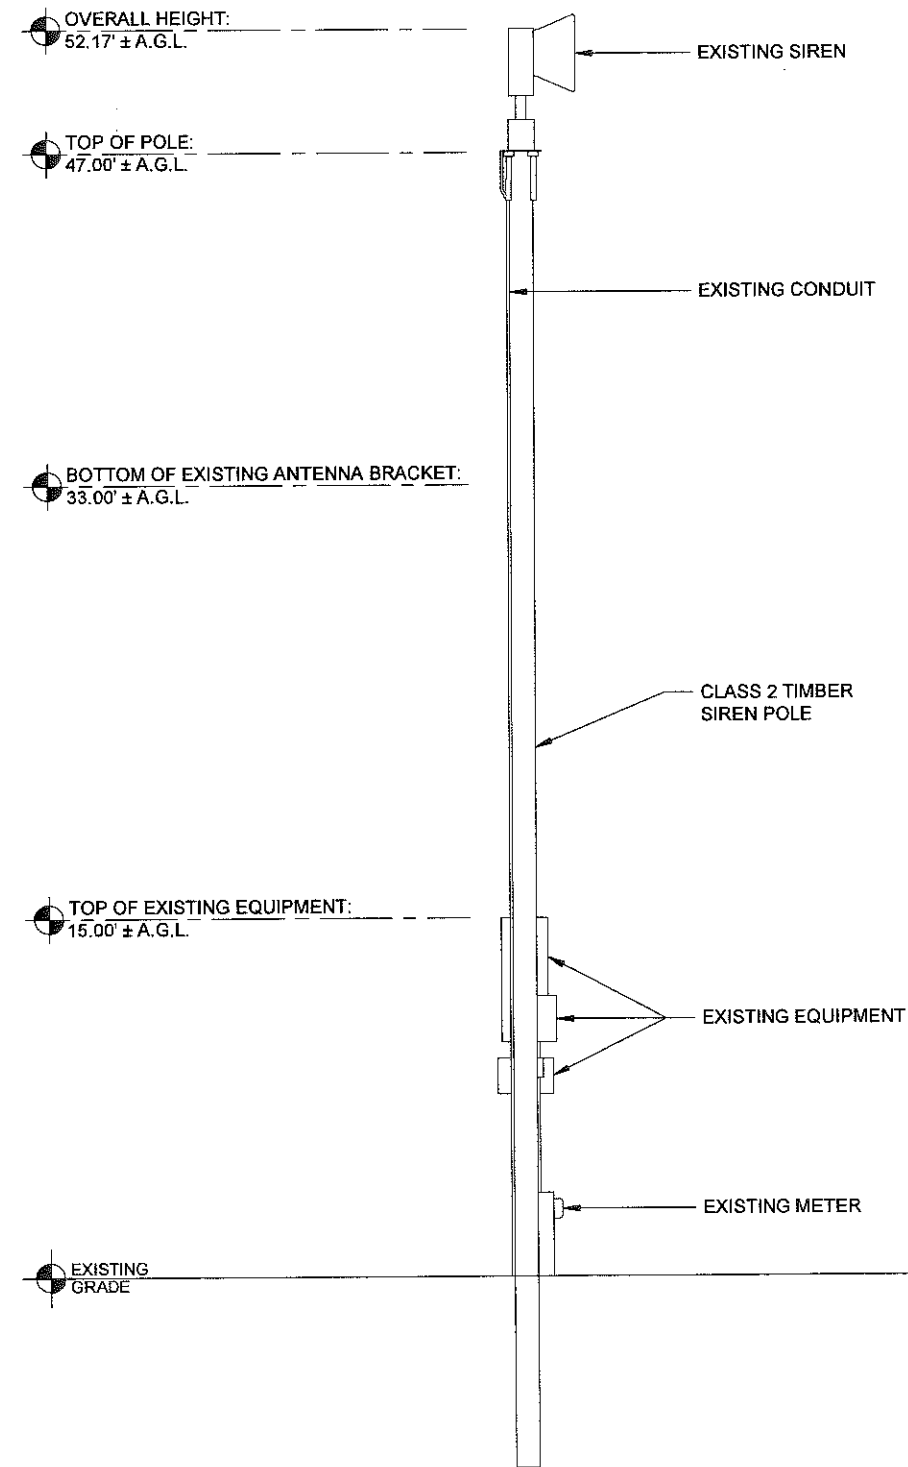

2 EXISTING WEST ELEVATION
SCALE: 1/4" = 1'-0" ±

CHICAGO
SMSA
limited partnership
d/b/a VERIZON WIRELESS

TERRA
CONSULTING GROUP, L.P.
600 BUSSE HIGHWAY
PARK RIDGE, IL 60068
PH: 847-698-6400
FAX: 847-698-6401

NO.	REVISIONS	DESCRIPTION	BY		DATE
			LRB	LRB	
		ISSUED FOR REVIEW			08/17/15

LOC# 292279
PINGREE RD.
METRA SC


282 EXCHANGE DR.
CRYSTAL LAKE, IL 60014

DRAWN BY:	MPC
CHECKED BY:	TAZ
DATE:	06/26/15
PROJECT #:	88-063

SHEET TITLE
EXISTING SITE
ELEVATIONS


SHEET NUMBER

ANT-1

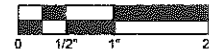


SCALE: 1/4" = 1'-0"

22" x 34" PRINT IS THE FULL SCALE FORMAT. ANY SIZE OTHER THAN THAT IS AT REDUCED SCALE.

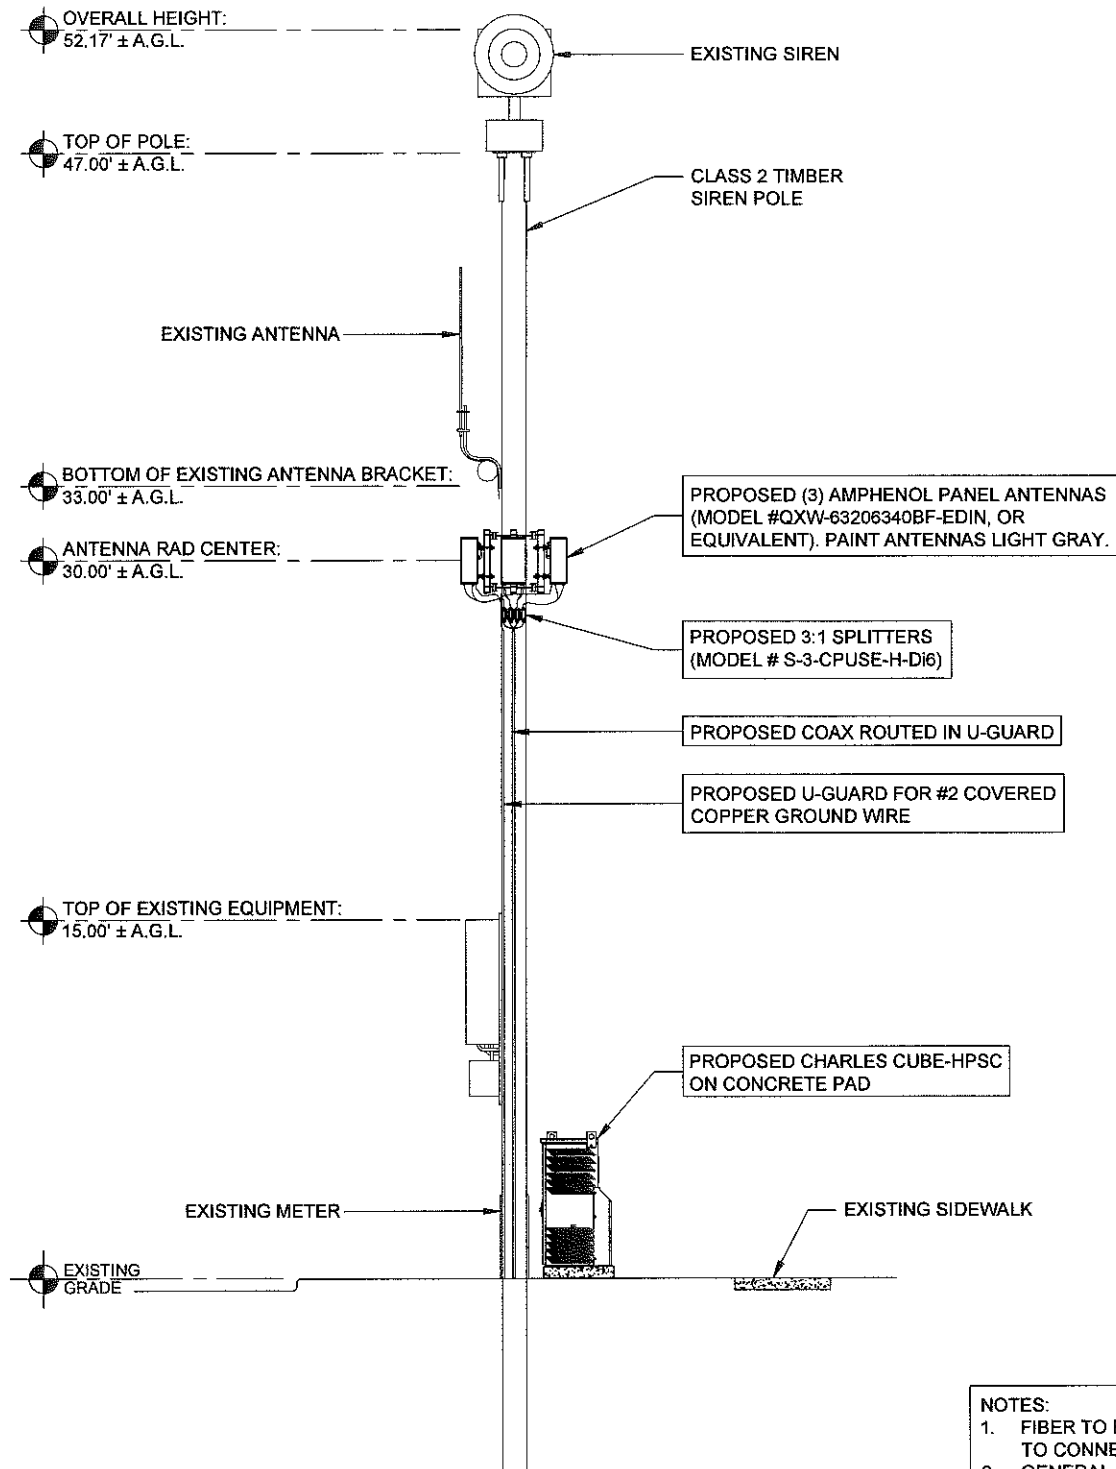


1 PROPOSED NORTH ELEVATION
SCALE: 1/4" = 1'-0" ±

- NOTES:
1. FIBER TO BE CLEAN AND TESTED PRIOR TO CONNECTING TO RRU'S.
 2. GENERAL CONTRACTOR TO ENSURE BATTERIES ARE NOT CONNECT PRIOR TO COMMERCIAL POWER ACTIVATION.
 3. THIS DRAWING IS FOR EXHIBIT AND LAYOUT PURPOSES ONLY. PLEASE REFER TO STRUCTURAL REPORT PREPARED BY HUTTER TRANKINA ENGINEERING.

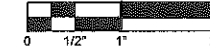

SCALE: 1/4" = 1'-0"

22" x 34" PRINT IS THE FULL SCALE FORMAT. ANY SIZE OTHER THAN THAT IS AT REDUCED SCALE.

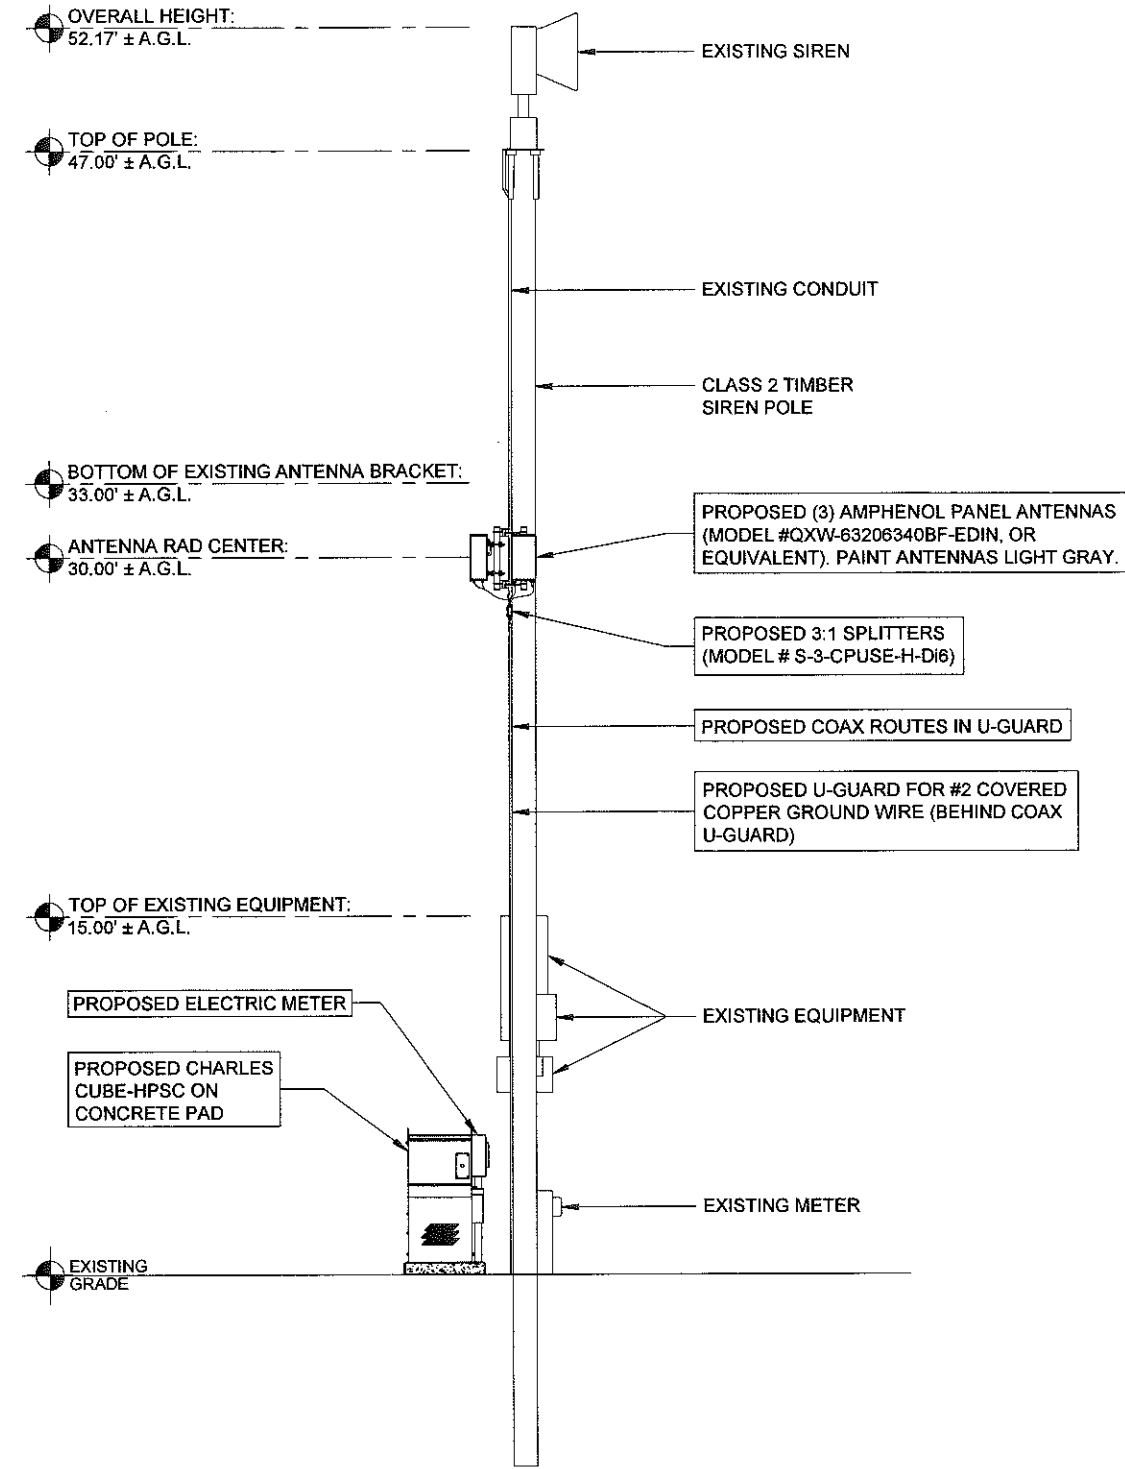

2 PROPOSED WEST ELEVATION
SCALE: 1/4" = 1'-0" ±

CHICAGO SMSA
limited partnership
d/b/a VERIZON WIRELESS

TERRA
ENGINEERING & ARCHITECTURE, L.P.
600 BUSSE HIGHWAY
PARK RIDGE, IL 60068
PH: 847-698-6400
FAX: 847-698-6401

NO.	REVISIONS	DATE	BY	LRB
	DESCRIPTION	06/11/15		
	ISSUED FOR REVIEW			

LOC# 292279
PINGREE RD.
METRA SC

282 EXCHANGE DR.
CRYSTAL LAKE, IL 60014

DRAWN BY:	MPC
CHECKED BY:	TAZ
DATE:	06/26/15
PROJECT #:	88-063

SHEET TITLE
PROPOSED SITE ELEVATIONS

SHEET NUMBER
ANT-2



EQUIPMENT CHANGE REQUEST FORM - ECR

Name Pingree Road Metra SC - Small Cell Build		RF Engineer Sabhi Siddiqui		Cell ID		282 Exchange Dr. (W side of Exchange across from Metra driveway), Crystal Lake, IL	
Location Number 292279		Market Chicago-EL1		Address		Utility Pole/Tower	
Date of Request 5/27/2015		Carriers 700 & AWS		Structure Type			
Sector	Power Required	Antenna Manufacturer	Antenna Model	Centerline*	Azimuth	Mechanical Tilt	Variable Tilt
Alpha	40 W	Amphenol	QXW-63206340BF-EDIN	30	0	0	0
Beta	40 W	Amphenol	QXW-63206340BF-EDIN	30	120	0	0
Gamma	40 W	Pingree	QXW-63206340BF-EDIN	30	240	0	0

*Centerline may vary +/- 3', not to fall below 27'

Component	Count	Action
3-way splitter	4	Install
Passive Components		
Coax	12	Install
	4	Install

See Layout Tab
 Radio to Splitter
 Splitter to Antenna

Carrier - LTE/AWS	Power Required	Equipment Manufacturer	Equipment Model	CWDM?
700	40 W	Ericsson	RRUS11 B13	No
2100	40 W	Ericsson	RRUS12 B4	-

*When no Cabinets are used AC/DC converters need to be mounted behind the radios


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		ISSUED FOR REVIEW	08/11/15		

LOC# 292279
PINGREE RD.
METRA SC
 282 EXCHANGE DR.
 CRYSTAL LAKE, IL 60014

DRAWN BY: MPC
 CHECKED BY: TAZ
 DATE: 06/26/16
 PROJECT #: 88-063

SHEET TITLE
PROPOSED ANTENNA CONFIGURATION

SHEET NUMBER
ANT-3

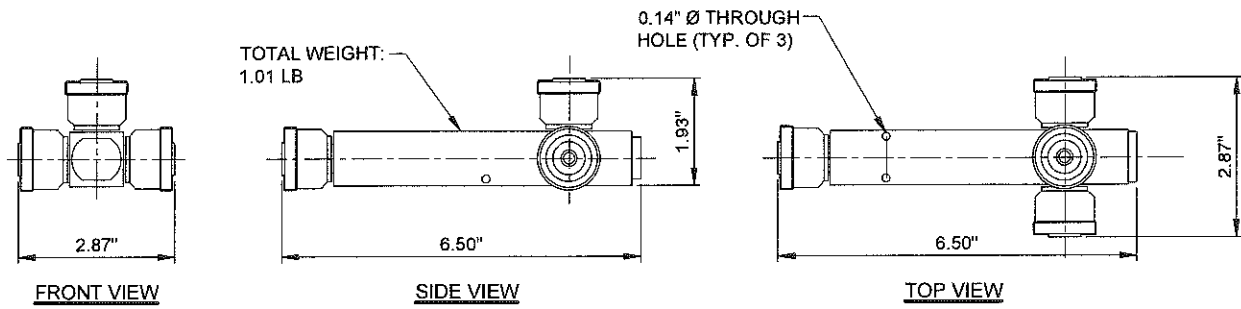

2 COMMSCOPE S-3-CPUSE-H-DI6 SPLITTER DETAIL
SCALE: N.T.S.

696-900 / 1710-2170 MHz




QXW-632X634XBF-EDIN


Replace "X" with desired electrical downlink.

XX-Pol | Dual Band FET Panel | 63° / 63° | 11.6 / 14.3 dBi

Electrical Characteristics	696-900 MHz		1710-2170 MHz		
	696-606	606-900	1710-1680	1680-1990	1900-2170
Frequency bands	696-606	606-900	1710-1680	1680-1990	1900-2170
Polarization	±45°				
Horizontal beamwidth	70°	65°	66°	63°	61°
Vertical beamwidth	37°	35°	18°	18°	18°
Gain	9.0 dBi / 11.1 dBi	9.5 dBi / 11.6 dBi	11.8 dBi / 13.9 dBi	12.1 dBi / 14.2 dBi	12.2 dBi / 14.3 dBi
Electrical downlink (X)	0				
Impedance	50Ω				
VSWR	≤1.5:1				
Isolation between ports	25 dB				
Input power	500 W		300 W		
Lightning protection	Direct ground				
Connectors	4 / 7-16 DIN / Female / Bottom				
Mechanical Characteristics					
Dimensions Length x Width x Depth	589 x 305 x 160 mm		23.2 x 12.0 x 7.1 in		
Weight without mounting brackets	5 kg		11 lbs		
Survival wind speed	> 201 km/hr		> 125 mph		
Wind area	Front: 0.18 m ²	Side: 0.11 m ²	Front: 1.9 ft ²	Side: 1.1 ft ²	
Wind load @ 161 km/hr (100 mph)	Front: 219 N	Side: 129 N	Front: 49 lbf	Side: 29 lbf	
Mounting Options					
	Part Number	Fit Dia	Dimension	Weight	
2-Point Mounting & Downlink Bracket Kit	3621006	40-115 mm	1.57-4.5 in	4.1 kg	9.0 lbs

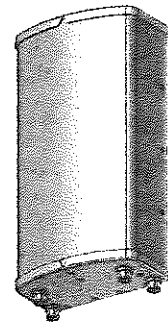





Antenna Bottom View

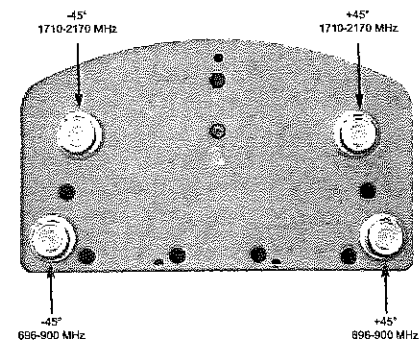

Quoted performance parameters are provided to offer typical or range values only and may vary as a result of normal manufacturing and operational conditions. Extreme operational conditions and/or stress on structural supports is beyond our control. Such conditions may result in damage to this product. Improvements to product may be made without notice.





1 ANTENNA SPECIFICATIONS SHEET
N.T.S.

RRUS12 B4 UNIT
WEIGHT = 58 POUNDS

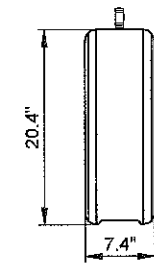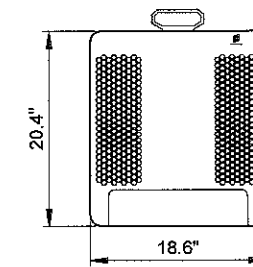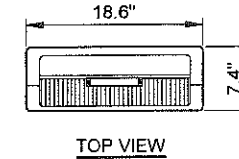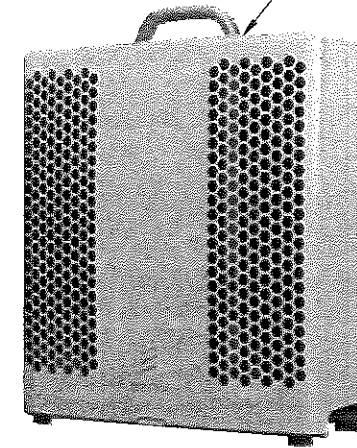

3 RRUS12 B4 INFORMATION
N.T.S.

RRUS11 B13 UNIT
WEIGHT = 51 POUNDS

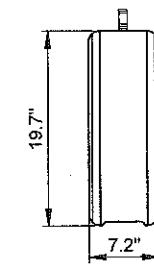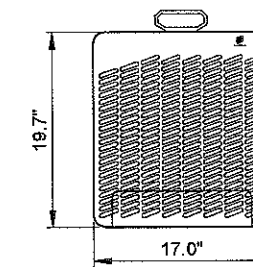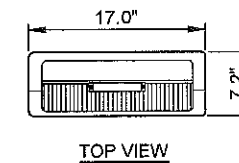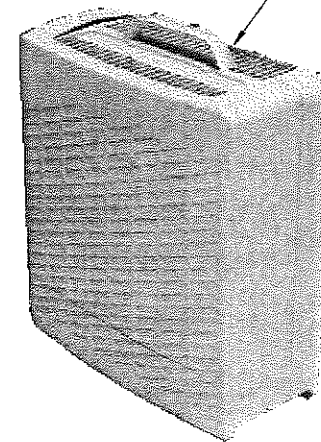

4 RRUS11 B13 INFORMATION
N.T.S.

CHICAGO SMSA
limited partnership
d/b/a VERIZON WIRELESS

TERRA
COMMERCIAL REAL ESTATE, LTD.
600 BUSSE HIGHWAY
PARK RIDGE, IL 60068
PH: 847-698-6400
FAX: 847-698-6401

NO.	REVISIONS	DESCRIPTION	ISSUED FOR REVIEW	DATE	BY
				08/11/15	LRB


LOC# 292279
PINGREE RD.
METRA SC

282 EXCHANGE DR.
CRYSTAL LAKE, IL 60014


DRAWN BY:	MPC
CHECKED BY:	TAZ
DATE:	06/26/15
PROJECT #:	88-063

SHEET TITLE
ANTENNA & EQUIPMENT DETAILS


SHEET NUMBER
ANT-4

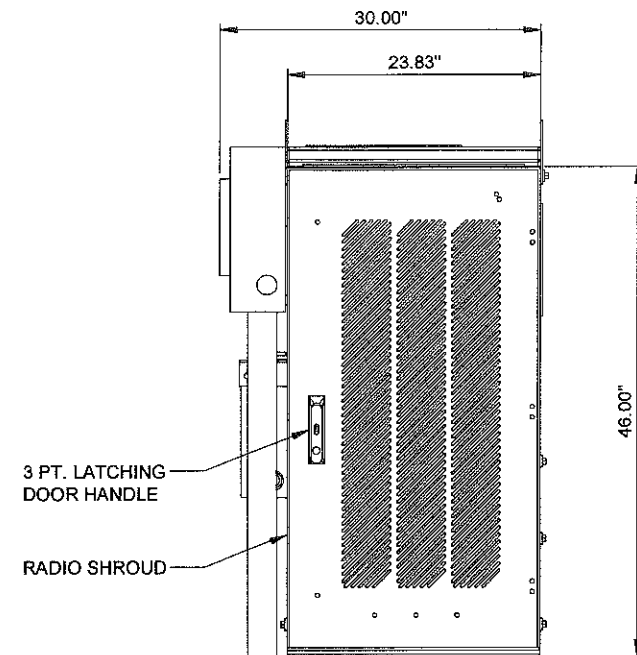

FRONT VIEW

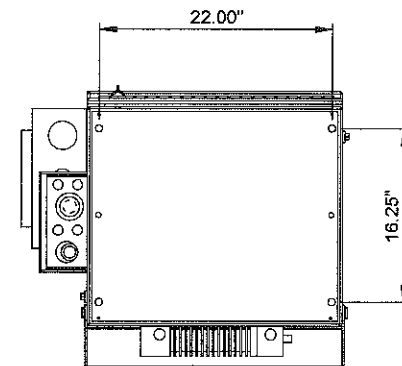


BOTTOM VIEW

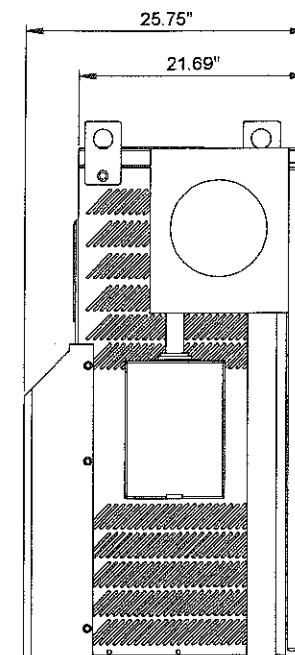

SIDE VIEW

1 CHARLES CUBE-HPSC CABINET DIMENSIONS
SCALE: N.T.S

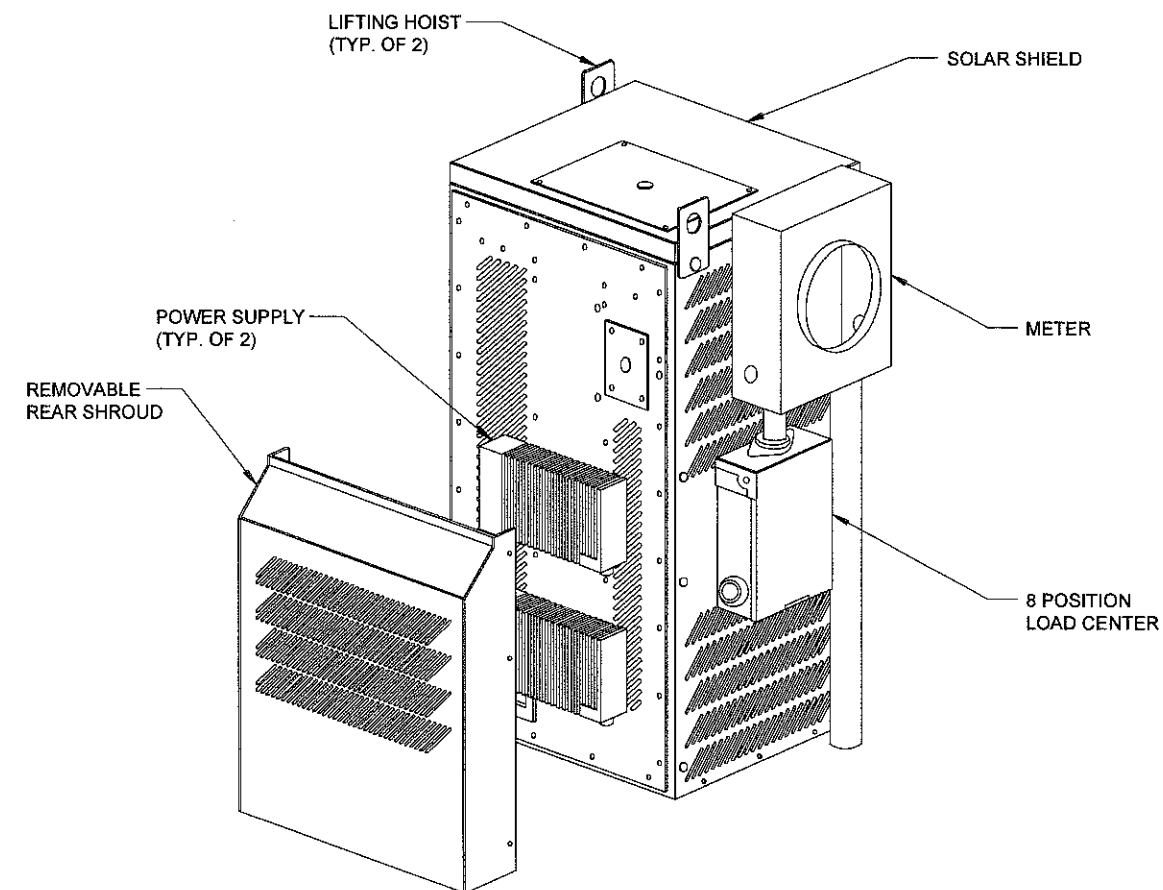

2 CHARLES CUBE-HPSC CABINET COMPONENTS
SCALE: N.T.S

CHICAGO SMSA
limited partnership
d/b/a VERIZON WIRELESS

TERRA
CONSULTING GROUP, LTD.
600 BUSSE HIGHWAY
PARK RIDGE, IL 60068
PH: 847-698-6400
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NO.	REVISIONS	DESCRIPTION	DATE	BY
			ISSUED FOR REVIEW	08/11/15

LOC# 292279
PINGREE RD.
METRA SC
282 EXCHANGE DR.
CRYSTAL LAKE, IL 60014

DRAWN BY: MPC
CHECKED BY: TAZ
DATE: 06/26/15
PROJECT #: 68-063

SHEET TITLE
CABINET DIMENSIONS
AND DETAILS

SHEET NUMBER
ANT-5

UTILITY NOTES:

WORK INCLUDES:
 THESE NOTES AND ACCOMPANYING DRAWINGS COMPLEMENT THE PROVISIONS AND INSTALLATIONS BY THE ELECTRICAL CONTRACTOR, OF ALL LABOR, MATERIALS AND EQUIPMENT REQUIRED TO INSTALL THE ELECTRICAL WORK COMPLETE IN CONNECTION WITH THIS VERIZON WIRELESS SITE AND SHALL INCLUDE, BUT NOT BE LIMITED TO THE FOLLOWING:

1. THE PROVISIONS, INSTALLATION, AND CONNECTION OF A GROUNDING ELECTRODE SYSTEM COMPLETE WITH SECONDARY GROUNDING, AND CONNECTIONS TO THE INCOMING ELECTRICAL DISTRIBUTION EQUIPMENT.
2. THE PROVISION AND INSTALLATION OF AN OVERHEAD ELECTRICAL SERVICE OR UNDERGROUND ELECTRICAL SERVICE AND ALL ASSOCIATED WIRE AND CONDUIT AS REQUIRED AND/OR INDICATED ON PLANS.
3. THE PROVISION, INSTALLATION OF CONDUIT AND CONNECTIONS FOR LOCAL FIBER SERVICE.
4. THE FURNISHING AND INSTALLATION OF THE ELECTRICAL SERVICE ENTRANCE CONDUCTORS, CONDUITS, METER SOCKET, AND CONNECTIONS TO THE SERVICE EQUIPMENT.
5. TWO INCH (2") AND THREE INCH (3") DIAMETER PVC CONDUITS SCHEDULE 40.
6. ALL PVC CONDUITS SHOULD BE LEFT WITH NYLON PULL CORD FOR FUTURE USE.
7. EXCAVATION, TRENCHING, AND BACKFILLING FOR CONDUIT(S), CABLE(S), AND EXTERNAL GROUNDING SYSTEM.

CODES, PERMITS, AND FEES:

1. ALL REQUIRED PERMITS, LICENSES, INSPECTIONS AND APPROVALS SHALL BE SECURED AND ALL FEES FOR SAME PAID BY CONTRACTOR.
2. THE INSTALLATION SHALL COMPLY WITH ALL APPLICABLE CODES: STATE, LOCAL AND NATIONAL, AND THE DESIGN, PERFORMANCE CHARACTERISTICS AND METHODS OF CONSTRUCTION OF ALL ITEMS AND EQUIPMENT SHALL BE IN ACCORDANCE WITH THE LATEST ISSUE OF THE VARIOUS APPLICABLE STANDARD SPECIFICATIONS OF THE FOLLOWING AUTHORITIES:

N.E.C.	NATIONAL ELECTRIC CODE
A.N.S.I.	AMERICAN NATIONAL STANDARDS INSTITUTE
I.E.E.E.	INSTITUTE OF ELECTRICAL AND ELECTRONICS ENGINEERS
A.S.T.M.	AMERICAN SOCIETY FOR TESTING MATERIALS
N.E.M.A.	NATIONAL ELECTRICAL MANUFACTURERS ASSOCIATION
U.L.	UNDERWRITERS LABORATORIES, INC.
N.F.P.A.	NATIONAL FIRE PROTECTION ASSOCIATION

RACEWAYS AND WIRING:

1. WIRING OF EVERY KIND MUST BE INSTALLED IN CONDUIT, UNLESS NOTED OTHERWISE, OR AS APPROVED BY THE ENGINEER.
2. UNLESS OTHERWISE SPECIFIED, ALL WIRING SHALL BE COPPER (CU) TYPE THWN, SIZED IN ACCORDANCE WITH THE NATIONAL ELECTRICAL CODE.
3. RACEWAYS SHALL BE GALVANIZED STEEL, SIZED IN ACCORDANCE WITH THE NATIONAL ELECTRICAL CODE, UNLESS OTHERWISE NOTED. ALL RACEWAYS SHALL BE APPROVED FOR THE INSTALLATION.
4. PULL OR JUNCTION BOXES SHALL BE PROVIDED AS REQUIRED TO FACILITATE INSTALLATION OF RACEWAYS AND WIRING. PROVIDE JUNCTION AND PULLBOXES FOR CONDUIT RUNS WITH MORE THAN (360) DEGREES OF BENDS.
5. PROVIDE A COMPLETE RACEWAY AND WIRING INSTALLATION, PERMANENTLY AND EFFECTIVELY GROUNDED IN ACCORDANCE WITH ARTICLE 250 OF THE NATIONAL ELECTRICAL CODE AND LOCAL CODES.
6. ALL STEEL CONDUIT SHALL BE BONDED AT BOTH ENDS WITH GROUNDING BUSHING.

GENERAL NOTES:

SEE DETAILS AND SCHEDULES ON DRAWINGS AND SPECIFICATIONS FOR MEANING OF ABBREVIATIONS AND ADDITIONAL REQUIREMENTS AND INFORMATION. CHECK ARCHITECTURAL, STRUCTURAL AND OTHER MECHANICAL AND ELECTRICAL DRAWINGS FOR SCALE, SPACE LIMITATIONS, COORDINATION, AND ADDITIONAL INFORMATION, ETC. REPORT ANY DISCREPANCIES, CONFLICTS, ETC. TO ENGINEER BEFORE SUBMITTING BID. ALL EQUIPMENT FURNISHED BY OTHERS (FBO) SHALL BE PROVIDED WITH PROPER MOTOR STARTERS, DISCONNECTS, CONTROLS, ETC. BY THE ELECTRICAL CONTRACTOR UNLESS SPECIFICALLY NOTED OTHERWISE. THE ELECTRICAL CONTRACTOR SHALL INSTALL AND COMPLETELY WIRE ALL ASSOCIATED EQUIPMENT IN ACCORDANCE WITH MANUFACTURER'S WIRE DIAGRAMS AND AS REQUIRED FOR A COMPLETE OPERATING INSTALLATION. ELECTRICAL CONTRACTOR SHALL VERIFY AND COORDINATE ELECTRICAL CHARACTERISTICS AND REQUIREMENTS OF (FBO) EQUIPMENT PRIOR TO ROUGH-IN OF CONDUIT AND WIRING TO AVOID CONFLICTS.

COORDINATION WITH UTILITY COMPANY:

THE ELECTRICAL CONTRACTOR SHALL COORDINATE COMPLETE ELECTRICAL SERVICE WITH LOCAL UTILITY COMPANY FOR A COMPLETE OPERATIONS SYSTEM, INCLUDING TRANSFORMER CONNECTIONS, CONCRETE TRANSFORMER PADS, IF REQUIRED, METER SOCKETS, PRIMARY CABLE RACEWAY REQUIREMENTS, SECONDARY SERVICE, ETC. PRIOR TO SUBMITTING BID TO INCLUDE ALL LABOR AND MATERIALS. THE ELECTRICAL CONTRACTOR SHALL INCLUDE IN THE BID ANY OPTIONAL OR EXCESS FACILITY CHARGES ASSOCIATED WITH PROVIDING ELECTRICAL SERVICE FROM LOCAL UTILITY COMPANY. VERIFY BEFORE BIDDING TO INCLUDE ALL COSTS. THE ELECTRICAL CONTRACTOR SHALL VERIFY THE AVAILABLE FAULT CURRENT WITH THE LOCAL UTILITY COMPANY PRIOR TO SUBMITTING BID. ADJUST A.I.C. RATINGS OF ALL OVER CURRENT PROTECTION DEVICES IN DISTRIBUTION EQUIPMENT AS REQUIRED TO COORDINATE WITH AVAILABLE FAULT CURRENT FROM LOCAL UTILITY COMPANY. ALL GROUNDING RODS PROVIDED BY THE POWER OR TELEPHONE UTILITY COMPANIES MUST BE TIED INTO THE MAIN EXTERNAL GROUND RING.

UTILITY CONTACTS:


POWER - COMED

FIBER - WOW

ELECTRICAL CONTRACTOR SHALL COORDINATE WITH POWER COMPANY FOR ENTRY INTO FENCED AREA BY EITHER MAILING A KEY TO A SLAVE LOCKED CHAIN AT THE FENCE GATE OR CALLING AND LEAVING A COMBINATION.

FOR CONTINUATION AND CONNECTION OF ELECTRIC AND TELEPHONE SERVICE. COORDINATE WITH ELECTRIC AND PHONE COMPANY

NOTE:
 1. FIBER TO BE CLEAN AND TESTED PRIOR TO CONNECTING TO RRU'S.
 2. NO FIBER INFORMATION WAS PROVIDED TO DEMONSTRATE IN THE DRAWINGS.

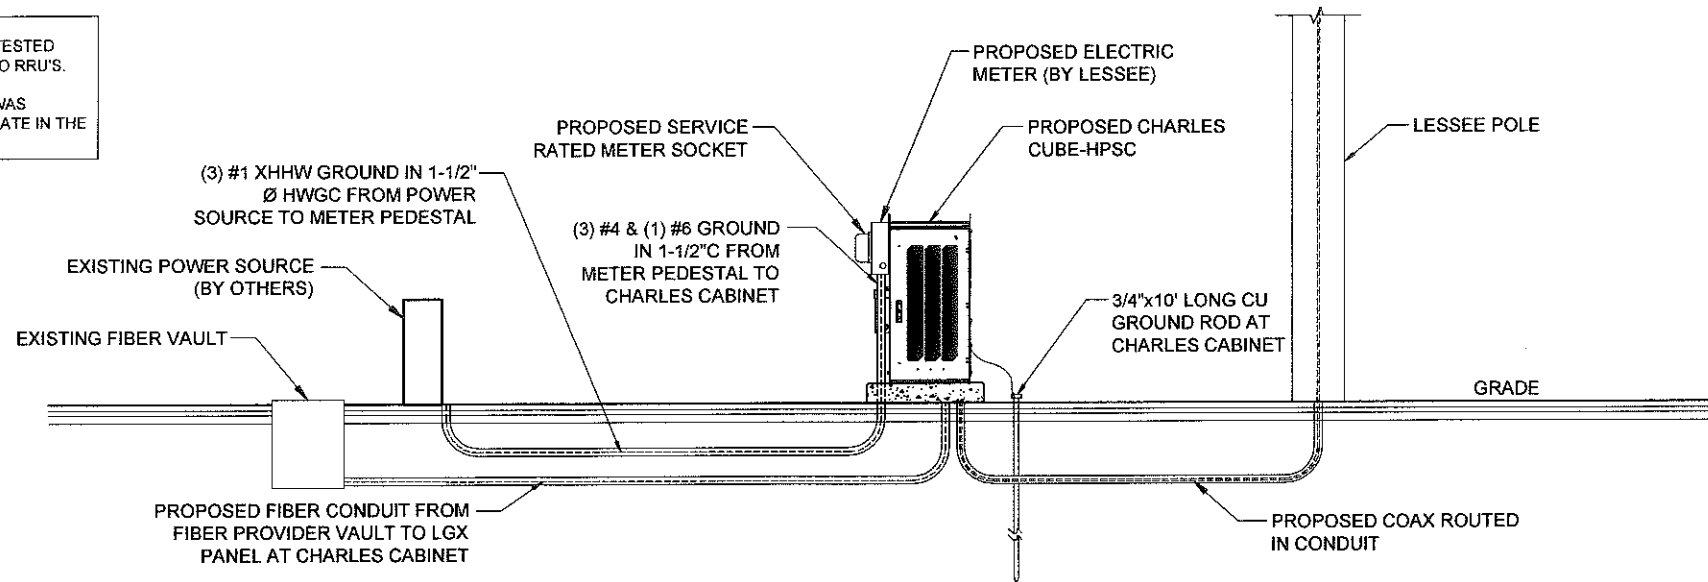

ELECTRICAL SERVICE: 200 AMP 120/240V SINGLE PHASE 3 WIRE

NOTE: VERIFY TELEPHONE ROUTING REQUIREMENTS WITH LOCAL TELEPHONE COMPANY

2 ELECTRICAL RISER DIAGRAM

SCALE: N.T.S.

CONTRACTOR SHALL BUILD INTO THE PRICE OF THE BID THE COST OF TWO (2) MOBILIZATIONS.
 1) POWER/FIBER PERMIT PULLED PRIOR TO BUILDING PERMIT AND PRELIMINARY WORK (SMART JACK ON A STICK, ETC) COMPLETED PRIOR TO GENERAL CONSTRUCTION
 2) RETURN TO COMPLETE GENERAL ELECTRICAL CONSTRUCTION

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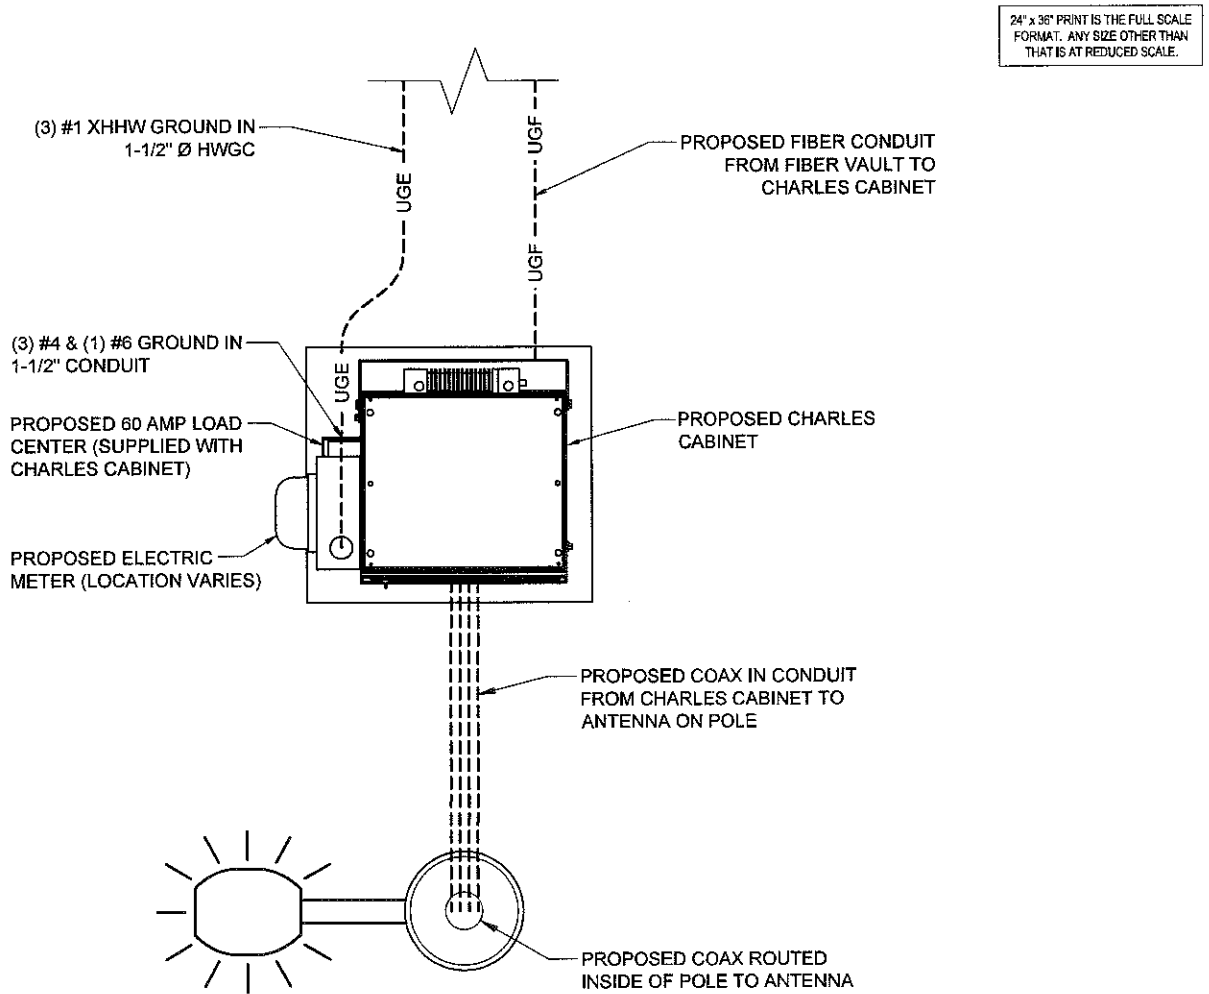
UTILITY CONTACTS:

POWER - COMED

FIBER - WOW


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FOR CONTINUATION AND CONNECTION OF ELECTRIC AND TELEPHONE SERVICE. COORDINATE WITH ELECTRIC AND PHONE COMPANY



1 UTILITY ROUTING PLAN (UNDERGROUND)

SCALE: N.T.S.

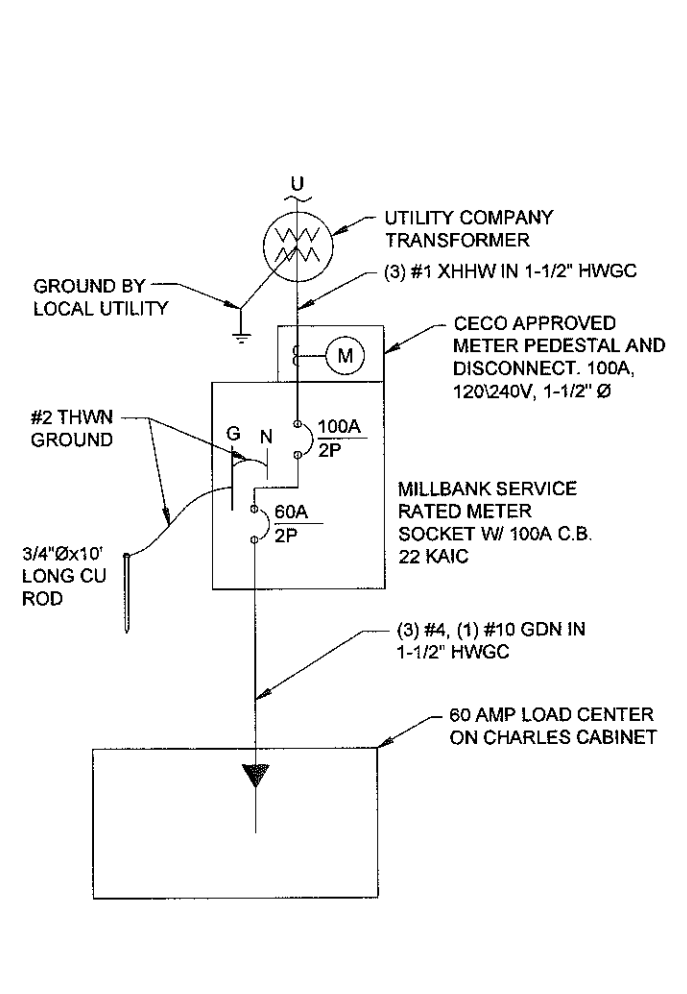

2 SINGLE LINE DIAGRAM

N.T.S.

CHICAGO SMSA
 limited partnership
 d/b/a VERIZON WIRELESS

TERRA
 CONSULTING ENGINEERS, LTD.
 600 BUSSE HIGHWAY
 PARK RIDGE, IL 60068
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 FAX: 847-698-6401

NO.	REVISIONS	DESCRIPTION	DATE	BY
1	ISSUED FOR REVIEW		08/11/15	LRB

LOC# 292279
PINGREE RD.
METRA SC

282 EXCHANGE DR.
 CRYSTAL LAKE, IL 60014

DRAWN BY:	MPC
CHECKED BY:	TAZ
DATE:	06/26/15
PROJECT #:	88-063

SHEET TITLE
UTILITY ROUTING DETAILS

SHEET NUMBER
E-1

GROUNDING ELECTRODE SYSTEM NOTES:

1. ALL GROUNDING CONNECTIONS SHALL BE MADE BY THE EXOTHERMIC PROCESS CONNECTIONS SHALL INCLUDE ALL CABLE TO CABLE, SPLICES, ETC. ALL CABLE TO GROUND RODS, GROUND RODS SPLICES AND LIGHTNING PROTECTION SYSTEM AS INDICATED. GROUND FOUNDATION ONLY AS INDICATED BY PM. ALL MATERIALS USED (MOLDS, WELDING, METAL, TOOLS, ETC.) SHALL BE BY EXOTHERMIC PROCESS AND INSTALLED PER MANUFACTURERS RECOMMENDATIONS AND PROCEDURES. GROUND CONDUCTOR SHALL HAVE A MINIMUM 24" BENDING RADIUS.

2. ALL EXOTHERMIC CONNECTIONS ON GALVANIZED SURFACES SHALL BE CLEANED THOROUGHLY AND COLORED TO MATCH SURFACE WITH (2) TWO COATS OF SHERWIN-WILLIAMS GALVITE (WHITE) PAINT B50WS (OR EQUAL) OR SHERWIN-WILLIAMS SILVERBRITE (ALUMINUM) B59S11 (OR EQUAL).

3. ALL ELECTRICAL & MECHANICAL GROUND CONNECTIONS SHALL HAVE ANTI-OXIDANT COMPOUND APPLIED TO CONNECTION


LEGEND	
SYMBOL	DESCRIPTION
⊗	5/8" DIAMETER X 10'-0" LONG COPPER CLAD GROUND ROD (HARGER-5810)
○	5/8" DIAMETER X 10'-0" LONG COPPER CLAD GROUND ROD WITH INSPECTION WELL
---	#2 AWG TNNB SOLID BARE COPPER WIRE MINIMUM 42" BELOW GRADE (HARGER-L2)
---	UNDERGROUND ELECTRICAL
---	UNDERGROUND TELEPHONE
---	UNDERGROUND FIBER
•	EXOTHERMIC WELD
—○—	OVERHEAD ELECTRICAL SERVICE
—○—	OVERHEAD TELEPHONE SERVICE

6. UTILITY COMPANY COORDINATION: ELECTRICAL CONTRACTOR SHALL CONFIRM THAT ALL WORK IS IN ACCORDANCE WITH THE RULES OF THE LOCAL UTILITY COMPANY BEFORE SUBMITTING THE BID, THE CONTRACTOR SHALL CHECK WITH THE UTILITY COMPANIES SUPPLYING SERVICE TO THIS PROJECT AND SHALL DETERMINE FROM THEM ALL EQUIPMENT AND CHARGES WHICH THEY WILL REQUIRE AND SHALL INCLUDE THE COST IN THE BID.

7. GROUND TEST: GROUND TESTS SHALL BE PERFORMED AS REQUIRED BY LESSEE STANDARD PROCEDURES. GROUND GRID RESISTANCE SHALL NOT EXCEED 5 OHMS.

8. CONTRACTOR SHALL SUBMIT THE GROUND RESISTANCE TEST REPORT AS FOLLOWS:


1. ONE (1) COPY TO OWNER REPRESENTATIVE
2. ONE (1) COPY TO ENGINEER
3. ONE (1) COPY TO KEEP INSIDE EQUIPMENT ENCLOSURE

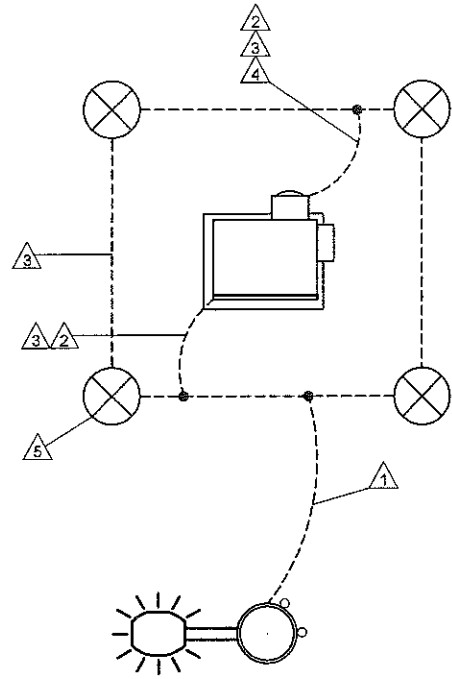


1 TYPICAL NODE GROUNDING PLAN
SCALE: 1" = 2'

NOTES:

1. ALL HARDWARE 18-8 STAINLESS STEEL INCLUDING BELLEVILLES. COAT ALL SURFACES WITH KOPR-SHIELD BEFORE MATING.
2. FOR GROUND BOND TO STEEL ONLY: INSERT A DRAGON TOOTH WASHER BETWEEN LUG AND STEEL, COAT ALL SURFACES WITH KOPR-SHIELD.
3. GROUND BARS, INSTALL BOLT HEAD TOWARD WALL
4. ENCLOSURES, INSTALL BOLT HEAD ON OUTSIDE OF ENCLOSURE

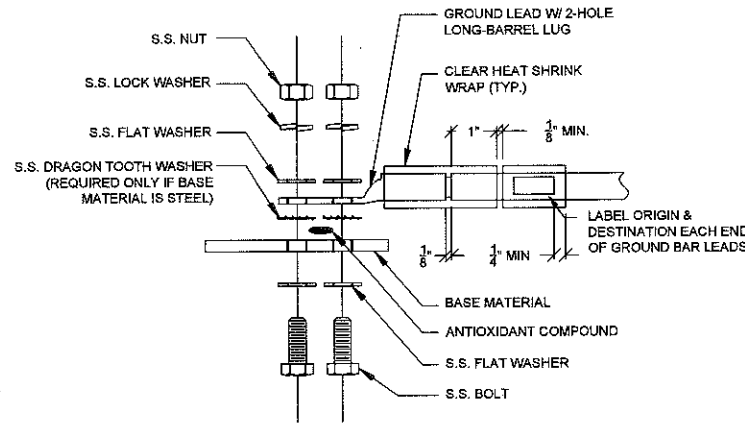


2 GROUND LIG INSTALLATION DETAIL
N.T.S.

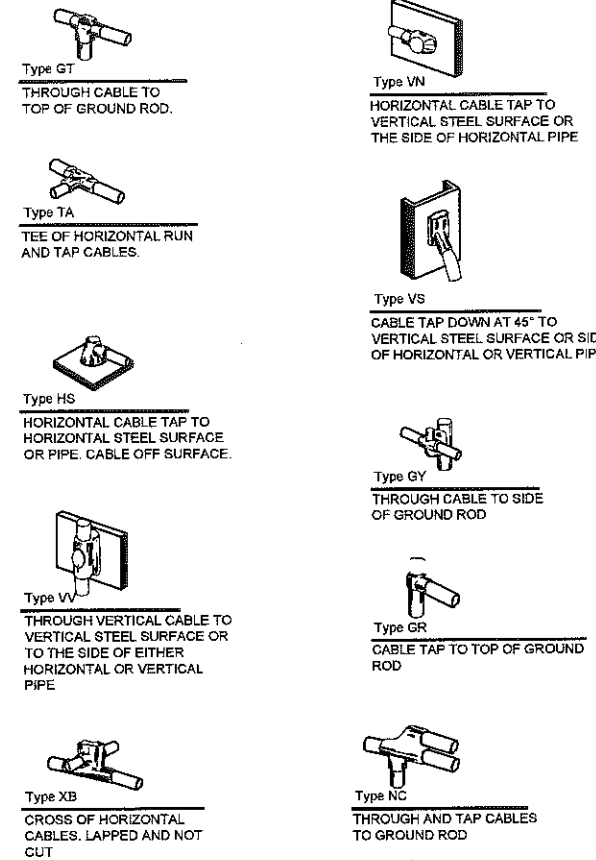

3 EXOTHERMIC WELD DETAILS
EXOTHERMIC AND HARGER ULTRAWELD OR APPROVED EQUAL

TYPICAL KEYED GROUNDING NOTES

- 1 3/0 STRANDED SOLID BARE COPPER CONDUCTOR 42" BELOW GRADE (TYPICAL) MINIMUM 24" BENDING RADIUS
- 2 ENCLOSURE GROUND (TYP.) IN 1/2" DIAMETER SCHEDULE 40 PVC CONDUIT
- 3 #2 AWG TNNB SOLID BARE COPPER CONDUCTOR 42" BELOW GRADE (SEE DETAIL, SHEET E-3)
- 4 ELECTRIC METER AND ELECTRIC SERVICE GROUNDING, COORDINATE ALTERNATE WITH PM
- 5 5/8" DIAMETER X 10'-0" LONG COPPER CLAD GROUND ROD (HARGER-5810) WITH EXOTHERMIC CONNECTION

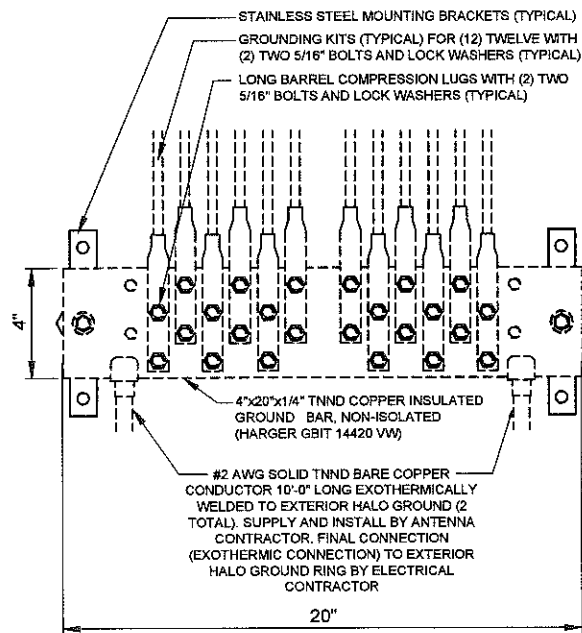

4 EXTERIOR GROUND BAR DETAIL
N.T.S.

OPERATES 24 HOURS
A DAY 365 DAYS A YEAR



CALL JULIE TOLL FREE
1(800) 892-0123
48 HOURS BEFORE
YOU DIG

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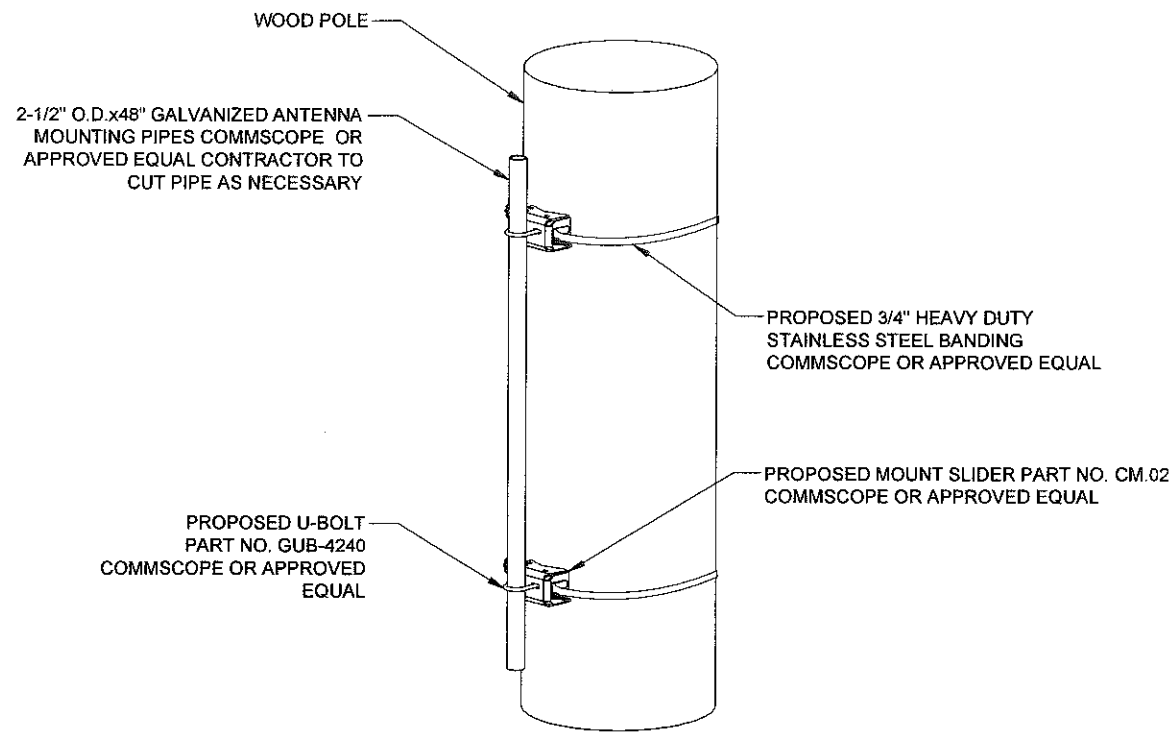
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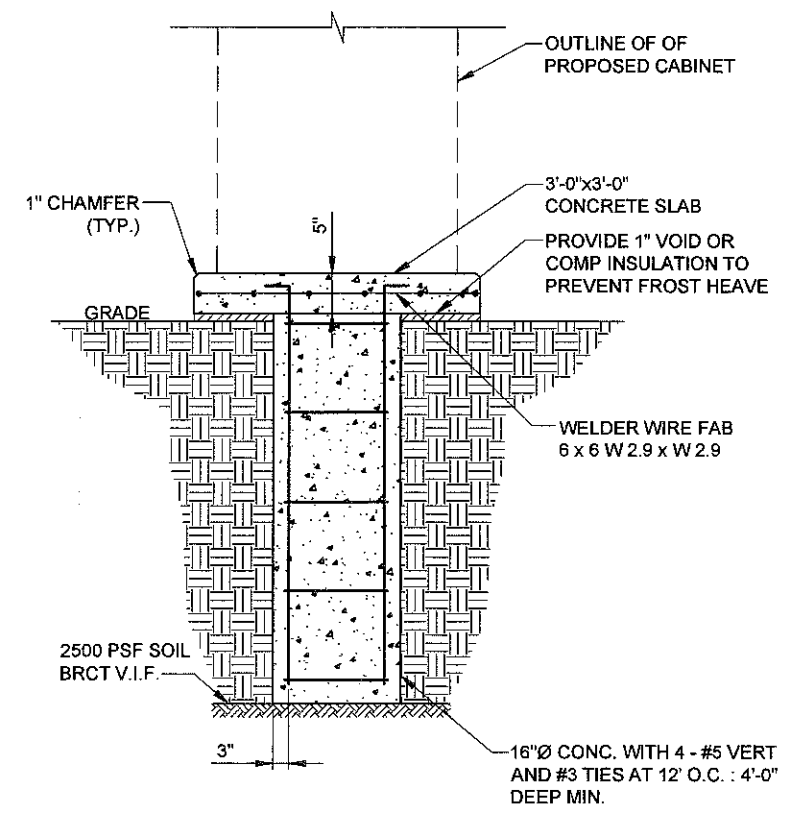
SHEET TITLE
**GROUNDING PLAN
AND DETAILS**

SHEET NUMBER

E-2



1 TYPICAL ANTENNA MOUNTING DETAIL
SCALE: N.T.S.



2 CHARLES CABINET FOUNDATION DETAIL
SCALE: N.T.S.

CHICAGO SMSA
limited partnership
d/b/a VERIZON WIRELESS

TERRA
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SHEET TITLE
STRUCTURAL
DETAILS

SHEET NUMBER
S-1

