

#2021-01 Crystal Lake Public Library – Variation Project Review for Planning and Zoning Commission

Meeting Date: January 20, 2021

Requests: A variation from Article 3-200 Table 3-200A to allow an

impervious surface coverage of 57.75%, a variation of

17.75%.

Location: 126 W Paddock St

Existing Zoning: R-2 Single-Family Residential & R-3A Two-Family

Residential

Surrounding Properties: North: R-3A – Two-Family Residential

South: R-2 – Single-Family Residential (Elementary

School)

East: R-3A – Two-Family Residential West: R-3A – Two-Family Residential

Staff Contact: Katie Cowlin (815.356.3798)

Background:


• <u>Previous Approvals</u>:

- In 1983, the Crystal Lake Public Library received a variation for setbacks and the parking lot.
- In 1995, a variation was granted for a reduced front yard setback, parking lot setback and parking lot landscaping requirements. The library addition was completed with this approval.
- o In 2001, a Special Use Permit was issued for an illuminated sign adjacent to residential.
- o In 2002, a variation was granted to allow a fence for the parking lot screening from residential.

Development Analysis:

- Request: The petitioner is requesting a variation to allow a 57.75% impervious surface coverage, a variation of 17.75%.
- <u>UDO Requirement</u>: Institutional uses (such as libraries and schools) are allowed a 40% impervious surface coverage in residentially zoned areas.

- The existing impervious surface coverage exceeds the UDO standards. The existing impervious surface coverage is 55.6%.
- The proposed impervious surface coverage is 57.75%, an increase of 2.15% (2,104 square feet).
- The increase in the impervious surface coverage is required to allow for the addition of a drive-through book pick-up and return.
- There is not any existing impervious surface that could be removed to bring the Library closer to the ordinance requirement.

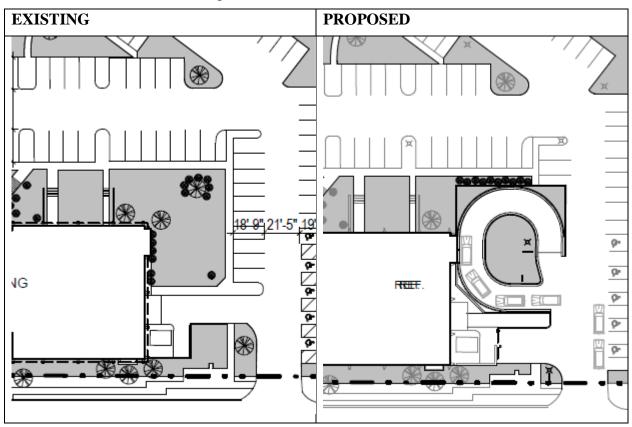

Comprehensive Land Use Plan 2030 Vision Summary Review:

The Comprehensive Plan designates the subject property as Public and Semi-Public, which allows for a mix of public facilities, such as schools, libraries, park district facilities and municipal facilities. The following goal is applicable to this request:

<u>Land Use – Public and Semi-Public</u>

Goal: Provide area for high quality public and semi-public facilities, such as schools, libraries, municipal facilities and private service providers, throughout the city to support the diverse and evolving needs of people in the city.

This can be accomplished with the following supporting action:

Supporting Action: The City shall support the school districts, library, park district, neighboring municipalities, private service providers and other public and semi-public agencies.

Findings of Fact:

ZONING ORDINANCE VARIATION

The petitioner is requesting a variation from Article 3-200 Table 3-200A to allow an impervious surface coverage of 57.75%, a variation of 17.75%.

The Unified Development Ordinance lists specific standards for the review and approval of a variation. The granting of a variation rests upon the applicant proving practical difficulty or hardship caused by the Ordinance requirements as they relate to the property.

To be considered a zoning hardship, the specific zoning requirements; setbacks, lot width and lot area must create a unique situation on this property. It is the responsibility of the petitioner to prove hardship at the Planning and Zoning Commission public hearing.

Standards

When evidence in a specific case shows conclusively that literal enforcement of any provision of this Ordinance would result in a practical difficulty or particular hardship because:

a.	The plight of the property owner is due to unique circumstances, such as, unusual surroundings or conditions of the property involved, or by reason of exceptional narrowness, shallowness or shape of a zoning lot, or because of unique topography, or underground conditions.
	☐ Meets ☐ Does not meet
b.	Also, that the variation, if granted, will not alter the essential character of the locality.
	☐ Meets ☐ Does not meet
consider	purposes of supplementing the above standards, the Commission may take into ation the extent to which the following facts favorable to the application have been ed by the evidence presented at the public hearing:
a.	That the conditions upon which the application for variation is based would not be applicable generally to other property within the same zoning classification;
	☐ Meets ☐ Does not meet
b.	That the alleged difficulty or hardship has not been created by any person presently having interest in the property;
	☐ Meets ☐ Does not meet
c.	That the granting of the variation will not be detrimental to the public welfare or injurious to other property or improvements in the neighborhood in which the property is located; or
	☐ Meets ☐ Does not meet
d.	That the proposed variation will not impair an adequate supply of light or air to adjacent

property, will not unreasonably diminish or impair the property values of adjacent


1 ,	nreasonably increase congestion in the public streets, substantially of fire or otherwise endanger public safety.
Meets	Does not meet
	und to justify such conditions, that fact shall be reported to the City on that the variation be denied.

Recommended Conditions:

If a motion is made to recommend approval of the petitioner's request, the following conditions are recommended:

- 1. Approved plans, to reflect staff and advisory board comments, as approved by the City Council:
 - A. Application (Crystal Lake Public Library, dated 01/05/2021).
 - B. Plan Set (Engberg Anderson Architects, dated 10/21/2020).
- 2. Provide landscaping in the landscape island in the drive-through circle.
- 3. The petitioner shall comply with all of the requirements of the Community Development, Public Works and Fire Rescue Departments.

PIQ MAP – CRYSTAL LAKE PUBLIC LIBRARY – VARIATION 126 W PADDOCK ST

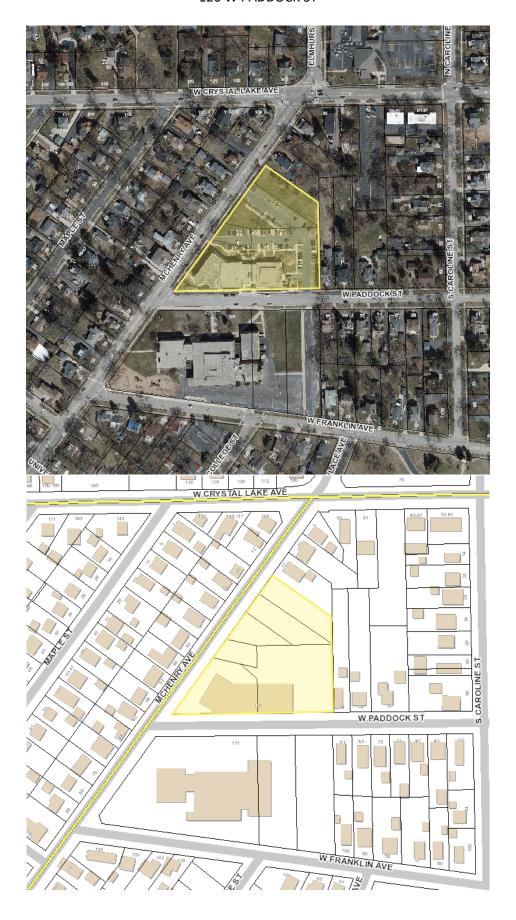

City of Crystal Lake Development Application

Office Use Only	
File #	

Project Title: Crystal Lake Public Library - Drive-Up Services			
Action Requested			
Annexation	Preliminary PUD		
Comprehensive Plan Amendment	Preliminary Plat of Subdivision		
Conceptual PUD Review	Rezoning		
Final PUD	Special Use Permit		
Final PUD Amendment	X Variation		
Final Plat of Subdivision	Other		
Petitioner Information	Owner Information (if different)		
Name: Crystal Lake Public Library	Name:		
Address: 126 Paddock Street	Address:		
Crystal Lake, IL 60014			
815-526-5102 Phone:	Phone:		
Fax:			
E-mail: kmartens@crystallakelibrary.org	E-mail:		
Property Information			
	es lane to support drop off and pick up of library materials existing topography to support vehicle movements; and		
and a retaining wall to separate grade between the	drive up services area and the existing parking and drive		
anes, sidewalks and other landscaped areas.			
Project Address/Location: 126 Paddock Street	, Crystal Lake, IL 60014		

PIN Number(s): PIN 19-05-202-005, 19-05-202-006, 19-05-202-029, 19-05-202-004, 19-05-202-033 & 19-05-202-032.

Development Team

Developer:	
Architect:	Engberg Anderson, Inc. 8618 W. Catalpa Avenue, Suite 1116, Chicago, IL 60656 shaunk@engberganderson.com
Attorney:	
Engineer:	Eriksson Engineering Associates, Ltd., 145 Commerce Drive, Suite A, Grayslake IL 60030 mrenner@eea-ltd.com
Landscape	Architect:
Planner:	
Surveyor:	
Other:	
Signatur	es
PET	TITIONER: Print and Sign name (if different from owner) Date
As owner o	f the property in question, I hereby authorize the seeking of the above requested action.
Karty	put Maileus, Library Director 1/5/2021
NOTE: If trust officer	NER: Print and Sign name Pate Un I. Martens Library Director Date Property is held in trust, the trust officer must sign this petition as owner. In addition, the must provide a letter that names all beneficiaries of the trust.

PUBLIC NOTICES SALES CORPORATION

intercountyjudicialsales.com 13161837 (Published in Northwest

Herald, December 29. January 5. 2020 2021)

PUBLIC NOTICE BEFORE THE PLANNING AND ZONING COMMISSION OF THE CITY OF CRYSTAL LAKE, MCHENRY COUNTY, ILLINOIS

IN THE MATTER OF THE APPLICATION OF

Crystal Lake Public Library

LEGAL NOTICE

Notice is hereby given in compliance with the Unified Development Ordinance (UDO) of the City of Crystal Lake, Illinois, that a public hearing will be held before the Planning and Zoning Commission upon the application of the Crystal Lake Public Library, seeking an impervious surface coverage ated at 126 Crystal Lake, 19-05-202variation located Paddock St, Crys variano. Paddock St, PIN Illinois. PIN 19-00 005, 19-05-202-006, 19-05-202-05-202-029, 19-05-2 004, 19-05-202-033 19-05-202-032 This application is filed for the purpose of seeking an


impervious surface coverage variation to allow a 57.75% impervious surface coverage, variation of 17.75% rsuant to Article 3-200 a pursuant to Article 3-200 Dimensional Standards and Article 9-200(C) Variations as well as any other variations as necessary to complete the drive-through book pickup and drop-off project as proposed. Plans for this project can be viewed at the Crystal Lake Community Development

add of the transfer of the tra

Department at City Hall. public hearing Planning and before the Zonina Commission for this request will be held at 7:00 p.m. on Wednesday, January 20, Wednesday, January 20, 2021, at the Crystal Lake City Hall, 100 West City City Hall, 100 West Woodstock Street, at which time and place any person determining to be heard may be present.

Jeff Greenman, Chairperson Planning and Zoning Commission City of Crystal Lake

(Published in the Northwest Herald January 5, 2021) 1847910

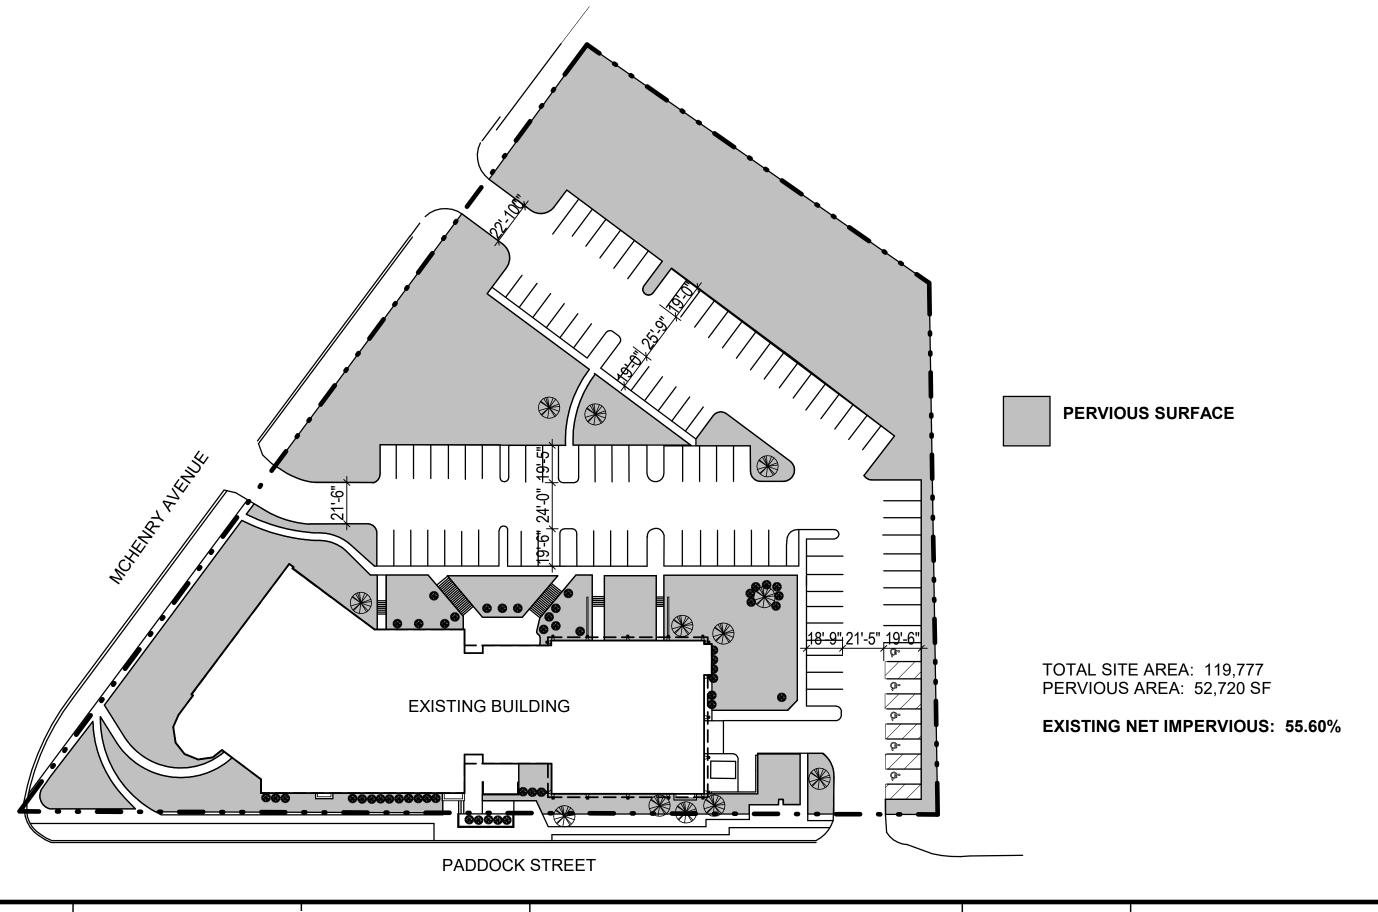



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CRYSTAL LAKE PUBLIC LIBRARY

126 W Paddock St

No.

Description

Date


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Author

Checker

PROPOSED SITE IMPERVIOUS


EXHIBIT B



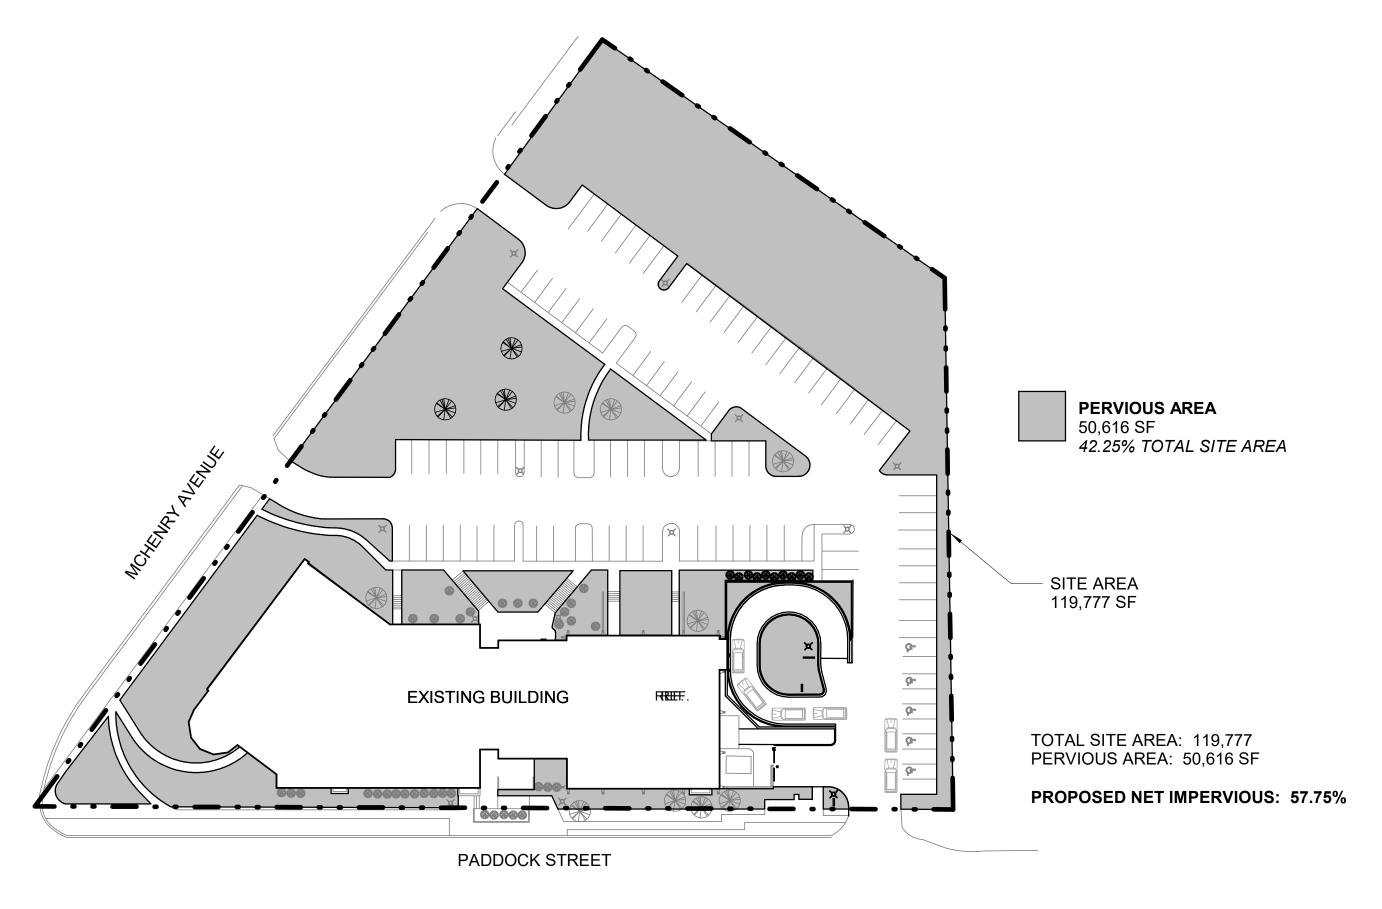


EXISTING SITE IMPERVIOUS

EXHIBIT A

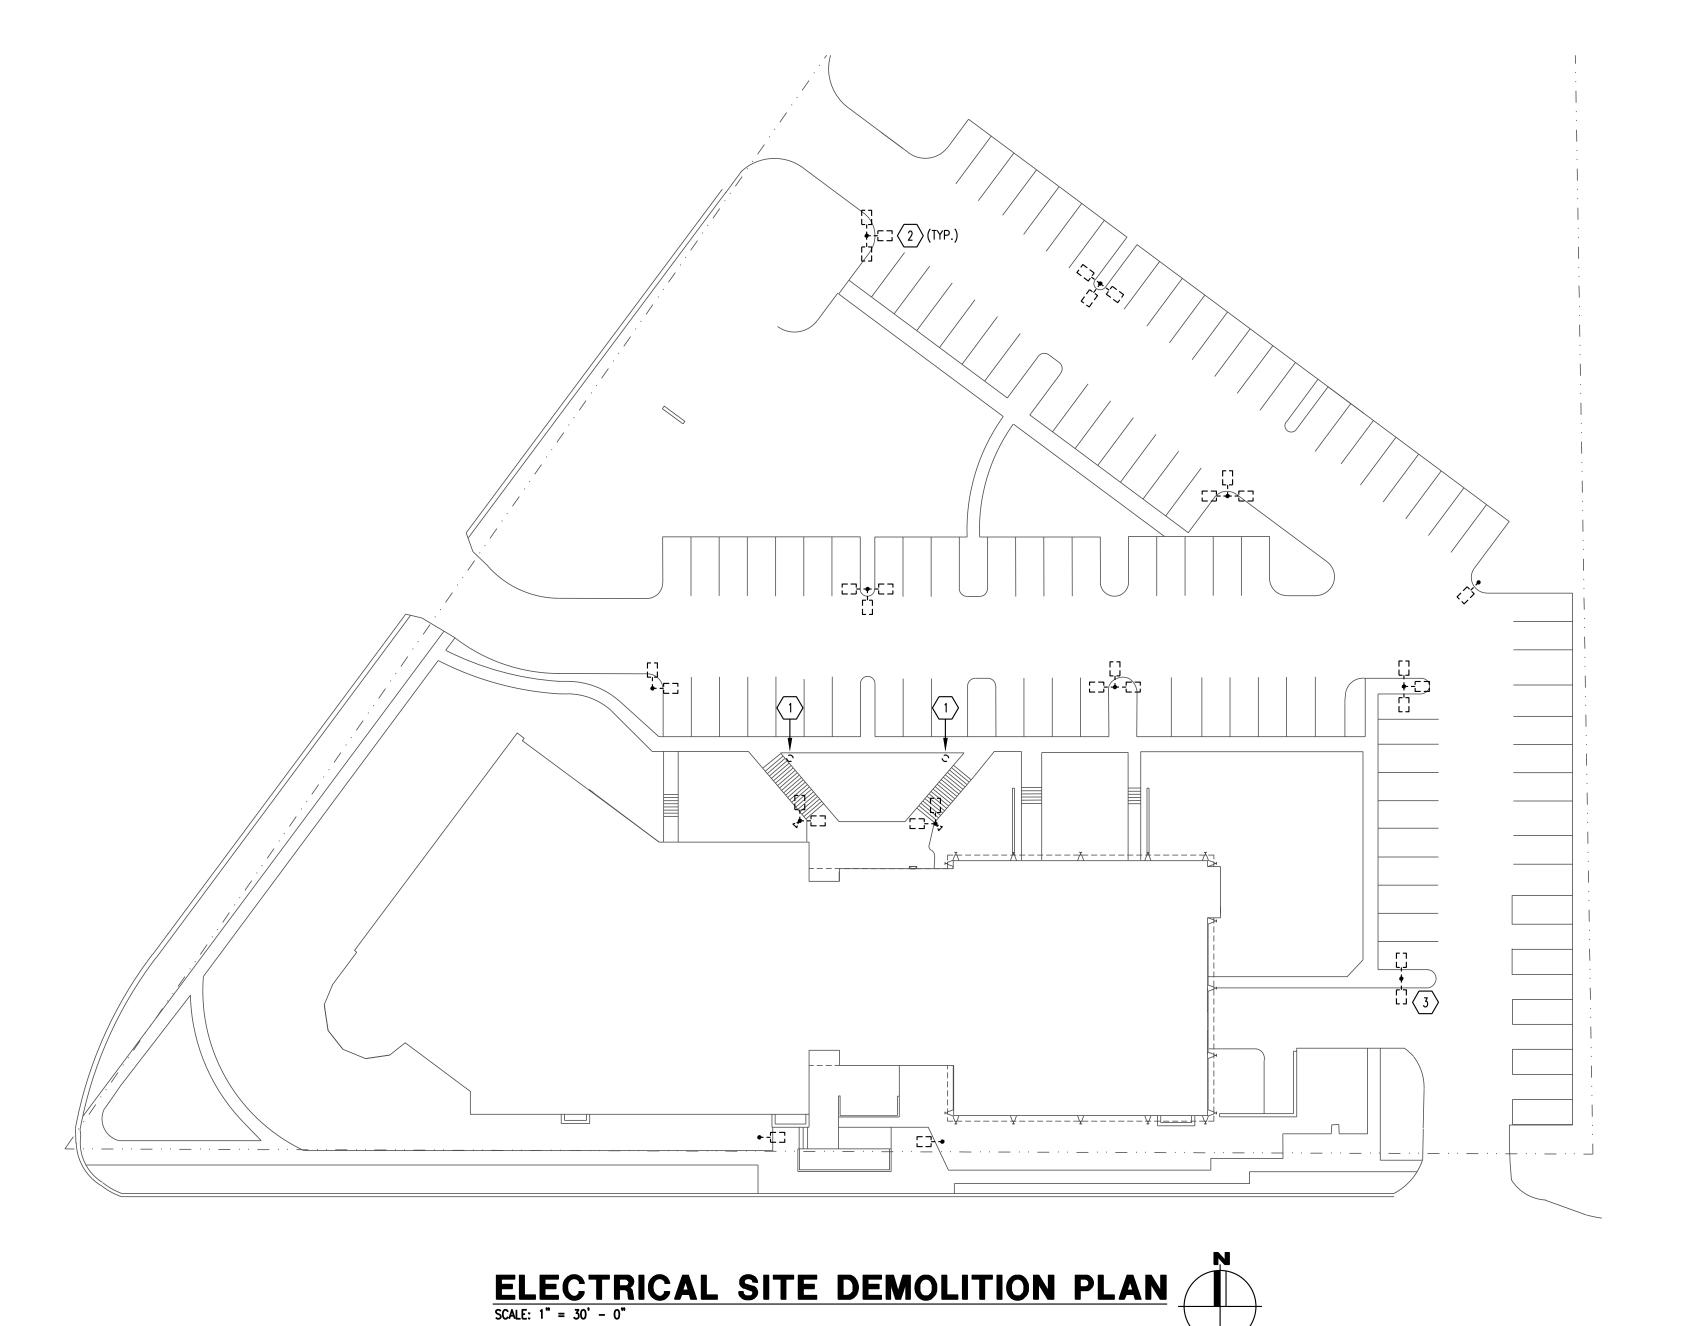

TYPE	DESCRIPTION	MANUFACTURER	LUMINAIRE SCHEDULE MODEL NUMBER	VOLTS	LAMPS	MOUNTING	NOTES
XA	TWIN HEAD LIGHT FIXTURE MOUNTED IN L PATTERN ON NEW 15 FOOT POLE WITH TYPE 4W OPTICS AND MOTION SENSOR TO REDUCE WATTAGE BY 50%.	HUBBELL	FIXTURES: RAR1-80L-50-4K7-4W-UNV-ASQ-DBT-SCP-40F POLE: SSS-H-15-40-A-2L-BLT	UNV	(2) 49.8W LED 4000K (2) 6245 LUMENS	MOUNTED ON EXISTING CONCRETE BASE	
ХВ	TWIN HEAD LIGHT FIXTURE MOUNTED AT 180 DEGREES ON NEW 15 FOOT POLE WITH TYPE 4W OPTICS AND MOTION SENSOR TO REDUCE WATTAGE BY 50%.	HUBBELL	FIXTURES: RAR1-80L-50-4K7-4W-UNV-ASQ-DBT-SCP-40F POLE: SSS-H-15-40-A-2-BLT	UNV	(2) 49.8W LED 4000K (2) 6245 LUMENS	MOUNTED ON EXISTING CONCRETE BASE	1,2
ХС	SINGLE HEAD LIGHT FIXTURE MOUNTED ON NEW 15 FOOT POLE WITH TYPE 4W OPTICS AND MOTION SENSOR TO REDUCE WATTAGE BY 50%.	HUBBELL	FIXTURE: RAR1-80L-50-4K7-4W-UNV-ASQ-DBT-SCP-40F POLE: SSS-H-15-40-A-1-BLT	UNV	49.8W LED 4000K 6405 LUMENS	MOUNTED ON EXISTING CONCRETE BASE	1,2
XC1	SINGLE HEAD LIGHT FIXTURE MOUNTED ON NEW 15 FOOT POLE WITH TYPE 4W OPTICS AND MOTION SENSOR TO REDUCE WATTAGE BY 50%.	HUBBELL	FIXTURE: RAR1-80L-50-4K7-4W-UNV-ASQ-DBT-SCP-40F POLE: SSS-H-15-40-A-1-BLT	UNV	49.8W LED 4000K 6405 LUMENS	MOUNTED ON NEW CONCRETE BASE. SEE DETAIL ON DRAWING EX100	1,3
XD	TWIN HEAD LIGHT FIXTURE MOUNTED AT 180 DEGREES ON NEW 15 FOOT POLE WITH TYPE 5 OPTICS AND MOTION SENSOR TO REDUCE WATTAGE BY 50%.	HUBBELL	FIXTURES: RAR1-80L-50-4K7-5QW-UNV-ASQ-DBT-SCP-40F POLE: SSS-H-15-40-A-2-BLT	UNV	(2) 49.8W LED 4000K (2) 6405 LUMENS	MOUNTED ON EXISTING CONCRETE BASE	1,2
XF	SINGLE HEAD LIGHT FIXTURE AND FLOOD LIGHT (FOR FLAG POLE) MOUNTED ON NEW 15 FOOT POLE WITH TYPE 5 OPTICS AND MOTION SENSOR TO REDUCE WATTAGE BY 50%.	HUBBELL	FIXTURE: RAR1-80L-50-4K7-5QW-UNV-ASQ-DBT-SCP-40F FLOOD LIGHT: FSL-10L-25-4K-M-U-k-DB-F-20750110264 POLE: SSS-H-15-40-A-2L-BLT	UNV	74.8W LED 4000K 8900 LUMENS	MOUNTED ON EXISTING CONCRETE BASE	1,2
XG	SINGLE HEAD LIGHT FIXTURE MOUNTED ON NEW 15 FOOT POLE WITH TYPE 5 OPTICS AND MOTION SENSOR TO REDUCE WATTAGE BY 50%.	HUBBELL	FIXTURE: RAR1-80L-50-4K7-5QW-UNV-ASQ-DBT-SCP-40F POLE: SSS-H-15-40-A-1-BLT	UNV	49.8W LED 4000K 6405 LUMENS	MOUNTED ON EXISTING CONCRETE BASE	1,2
ХН	SINGLE HEAD LIGHT FIXTURE MOUNTED ON NEW 12 FOOT POLE WITH TYPE 4W OPTICS AND MOTION SENSOR TO REDUCE WATTAGE BY 50%.	HUBBELL	FIXTURE: RAR1-80L-39-4K7-4W-UNV-ASQ-DBT-SCP-40F POLE: SSS-H-12-40-A-1-BLT	UNV	38W LED 4000K 5210 LUMENS	MOUNTED ON EXISTING CONCRETE BASE	1,2
ΧJ	42" LED ROUND BOLLARD WITH TYPE 5 OPTICS	КІМ	FIXTURE: PA7R-FT-NU-5-12L-020-4K7-42A-DB-UNV-SF	UNV	21.7W LED 4000K 1377 LUMENS	MOUNTED ON EXISTING CONCRETE BASE	1,2
ХК	TWIN HEAD LIGHT FIXTURE MOUNTED AT 180 DEGREES ON NEW 15 FOOT POLE WITH TYPE 3 OPTICS AND MOTION SENSOR TO REDUCE WATTAGE BY 50%.	HUBBELL	FIXTURES: RAR1-80L-50-4K7-3-UNV-ASQ-DBT-SCP-40F POLE: SSS-H-15-40-A-2-BLT	UNV	(2) 49.8W LED 4000K (2) 6405 LUMENS	MOUNTED ON NEW CONCRETE BASE. SEE DETAIL ON DRAWING EX100	1
XM	SINGLE HEAD LIGHT FIXTURE MOUNTED ON NEW 10 FOOT POLE WITH TYPE 2 OPTICS AND MOTION SENSOR TO REDUCE WATTAGE BY 50%.	HUBBELL	FIXTURE: RAR1-80L-39-4K7-2-UNV-ASQ-DBT-SCP-40F POLE: SSS-H-10-40-A-1-BLT	UNV	38W LED 4000K 5273 LUMENS	MOUNTED ON NEW CONCRETE BASE. SEE DETAIL ON DRAWING EX100	

1. EQUIVALENT LUMINAIRE SHALL BE ALLOWED AS MANUFACTURED BY H.E. WILLIAMS, EATON, PHILIPS, OR LITHONIA. 2. MODIFY EXISTING CONCRETE BASE AND BASEPLATE, AS REQUIRED TO MOUNT THE NEW POLE/FIXTURE. 3. PROVIDE ONE (1) #SCPREMOTE FOR THE PROJECT TO PROGRAM THE OCCUPANCY SENSORS

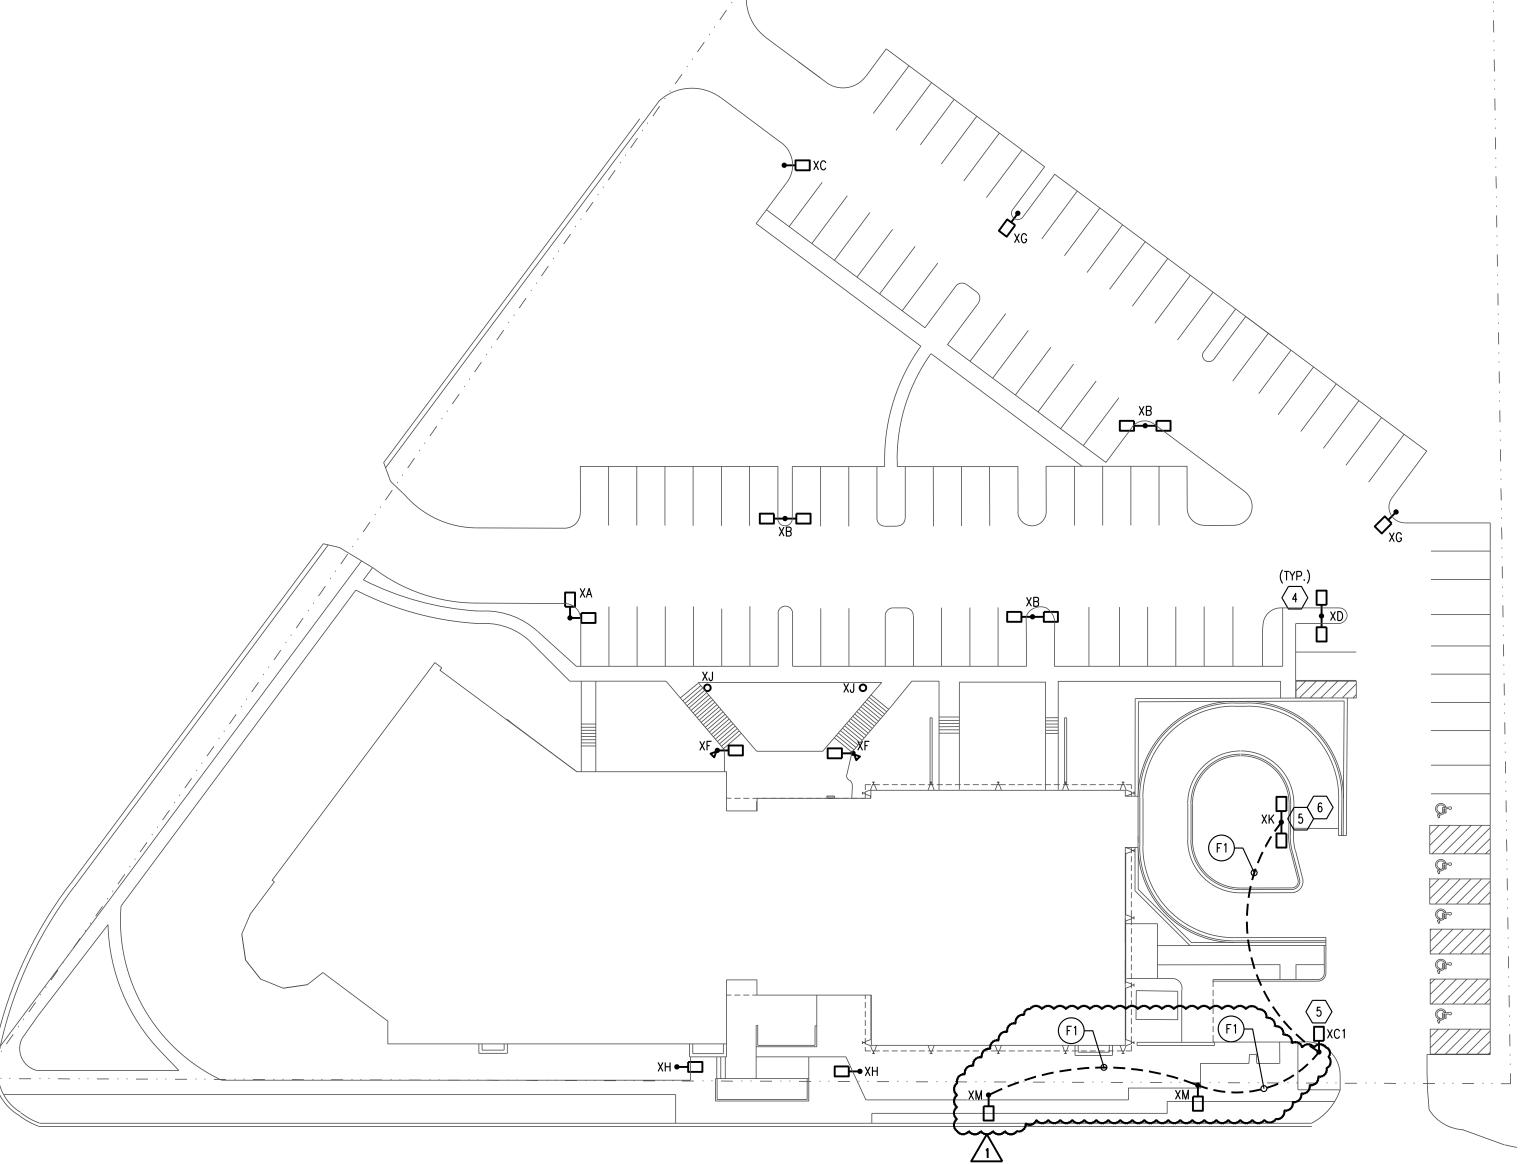

ELECTRICAL SITE PLAN

SCALE: 1" = 30' - 0"

FEEDER SCHEDULE

F1 = 2#8 & 1#8 GRD, 1" C.

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CRYSTAL LAKE PUBLIC LIBRARY

126 W Paddock St Crystal Lake, IL 60014


PROJECT NUMBER

ISSUED FOR:

BID PERMIT 10-21-2020 REVISION FOR: NO. DESCRIPTION


1 ADDENDUM #2

DATE

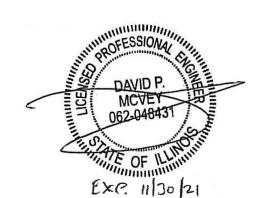

KEYNOTES (HEXAGON)

- 1. UNDER ALTERNATE #3, DISCONNECT AND REMOVE THE EXISTING LIGHTING BOLLARD. THE EXISTING CONCRETE BASE AND CIRCUITING SHALL REMAIN AND BE RE-USED.
- 2. UNDER ALTERNATE #3, DISCONNECT AND REMOVE THE EXISTING POLE AND LIGHTING FIXTURES. THE EXISTING CONCRETE BASE AND CIRCUITING SHALL REMAIN AND BE RE-USED.
- 3. UNDER BASE BID, DISCONNECT AND REMOVE THE EXISTING POLE AND CONCRETE BASE IN THEIR ENTIRETY. INTERCEPT THE EXISTING CIRCUITING AND REROUTE TO THE NEW POLES.
- 4. UNDER ALTERNATE #3, MOUNT THE NEW POLE/FIXTURES ONTO THE EXISTING CONCRETE BASE. CONNECT TO THE EXISTING CIRCUITING. MODIFY THE EXISTING ANCHOR BOLTS/BASE PLATE, AS REQUIRED TO MOUNT THE NEW POLE.
- 5. UNDER BASE BID, PROVIDE THE NEW LIGHT POLE AND CONCRETE BASE.
- 6. EXTEND THE EXISTING CIRCUITING TO THE NEW LIGHT POLE

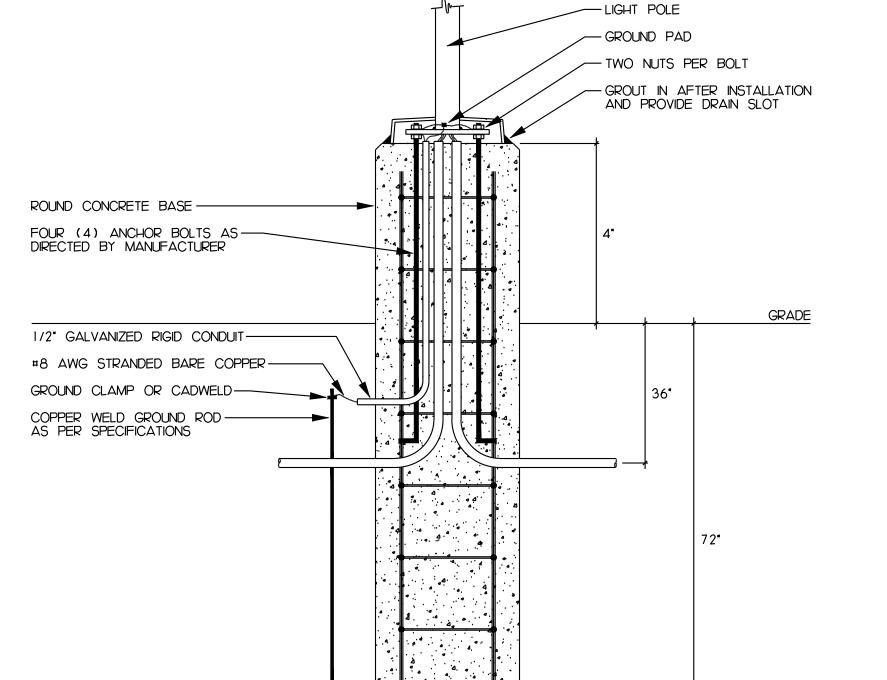

LIGHT POLE BASE DETAIL NOT TO SCALE DO00-0090

TLC SOLUTIONS 1301 W. 22nd St, Suite 210 Oak Brook, IL 60523 P 630.472.0918 www.tlc-engineers.com 6246-526-3 © Copyright 2020 TLC Engineering Solutions, Inc. THINK. LISTEN. CREATE.

DRAWN BY

DM


TLC ENGINEERING SOLUTIONS, INC. PROFESSIONAL DESIGN FIRM LICENSE NO. 184.003568, EXPIRES ON 04/30/2021

ELECTRICAL


SITE PLANS

CHECKED BY

EX100

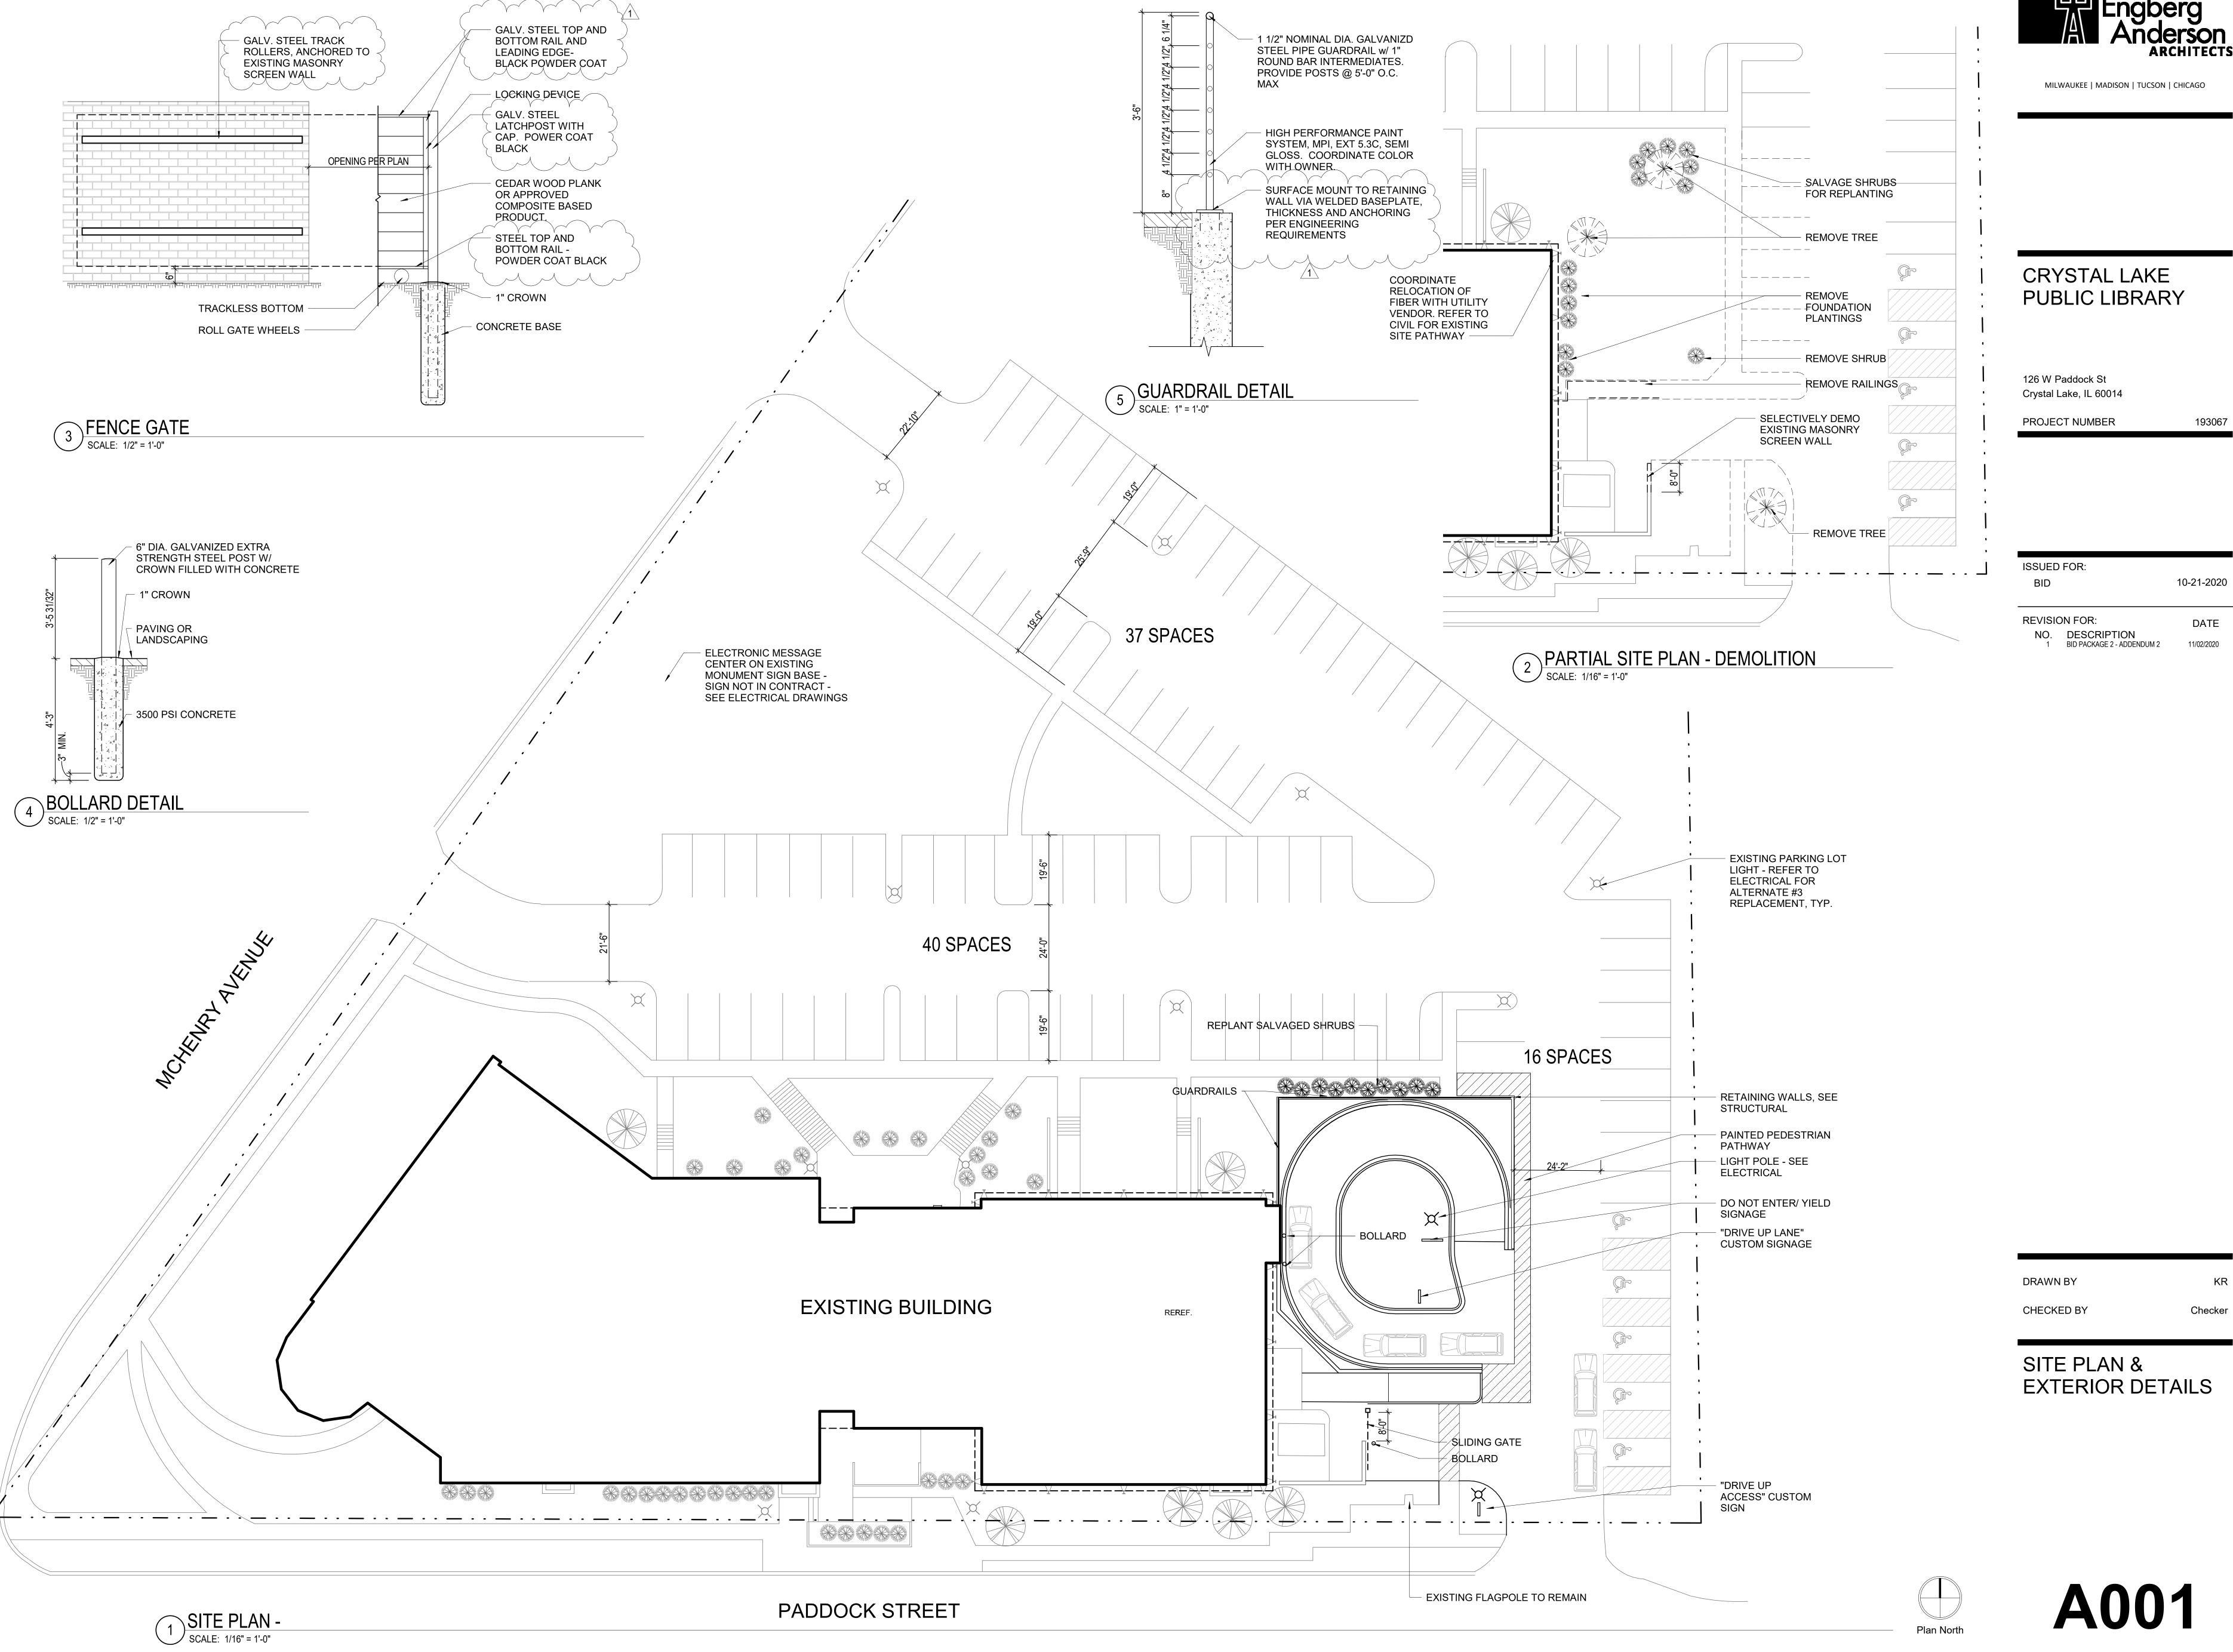

ARCHITECTS

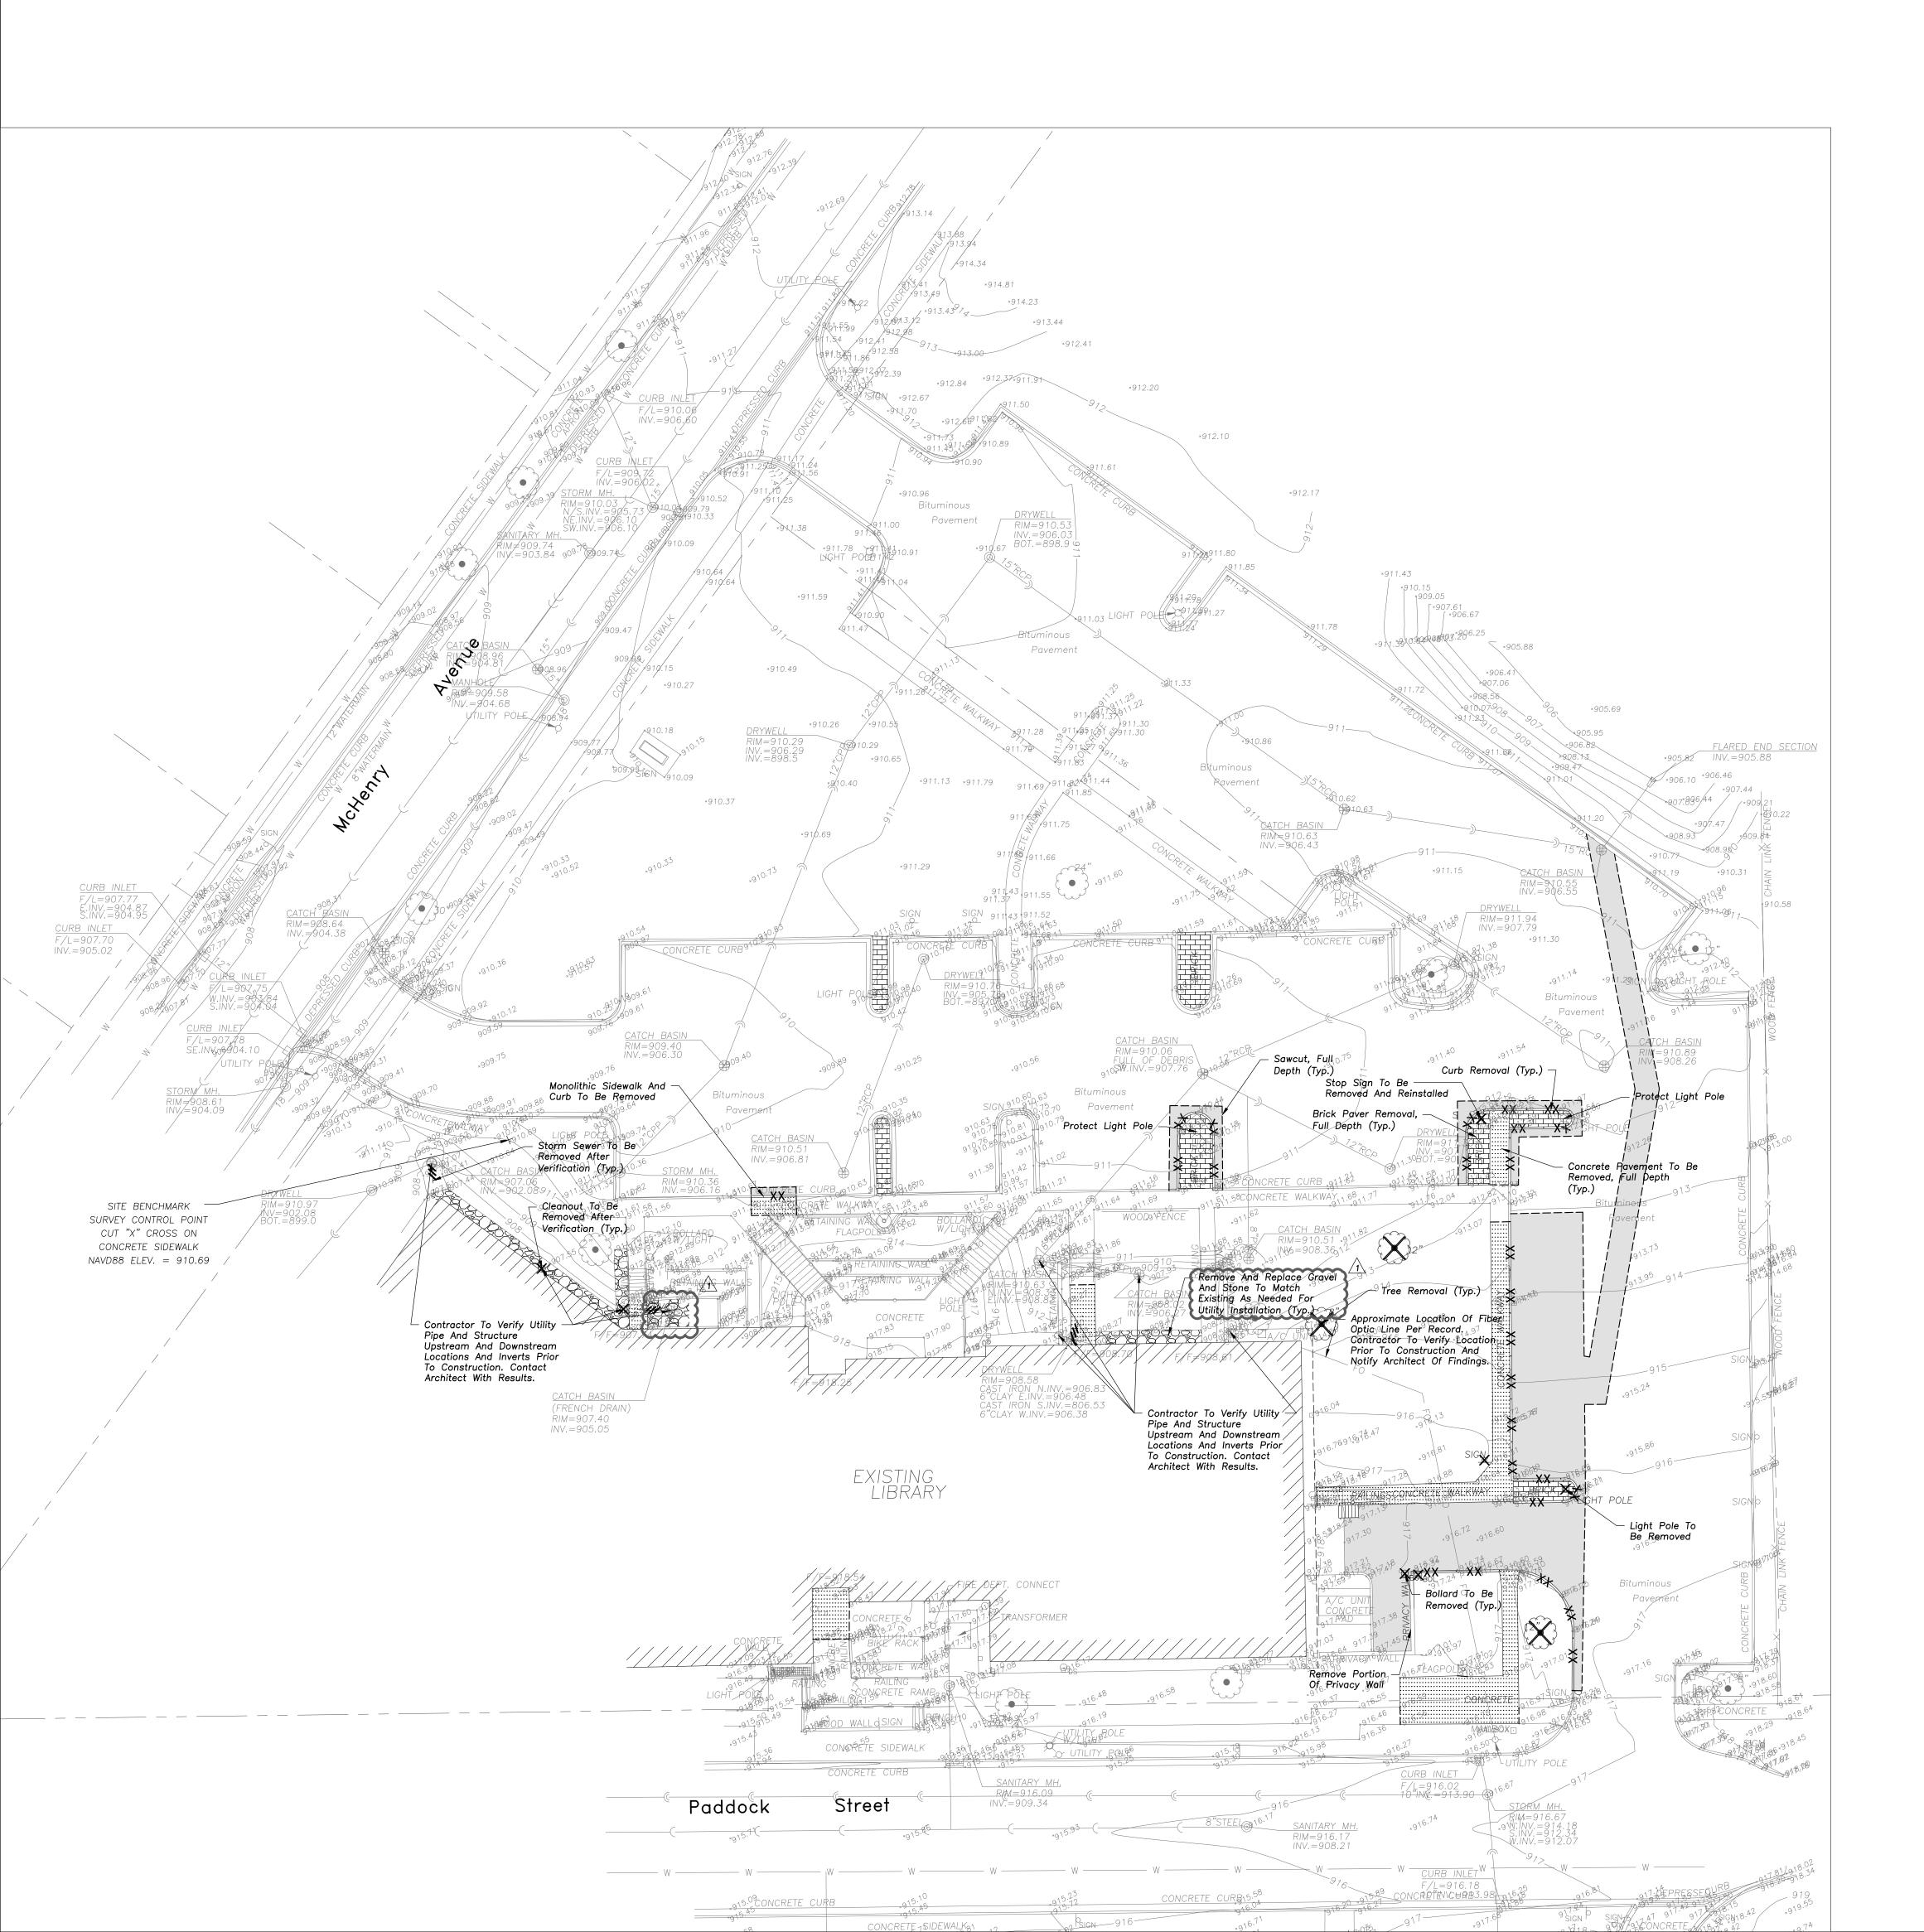



EXISTING


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x C 782.50

x G 782.00

x P 783.25

× T/W 785.20

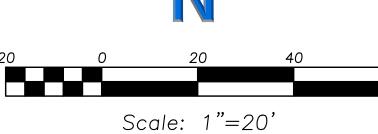

LEGEND

Manhole Catch Basin

Area Drain

Flared End Section

Sanitary Sewer

Overhead Wires

Telephone Line

Fire Hydrant

Buffalo Box

Downspout

Gas Meter

Light Pole

Utility Pole

Accessible Parking Stall

Curb & Gutter

Curb Elevation

Gutter Elevation

Pavement Elevation

Sidewalk Elevation

Ground Elevation

Coniferous Tree

Fencing at Drip Line

Telephone Pedestal

Telephone Manhole

Electric Meter

ComEd Manhole

Bollard Gas Valve PROPOSED

——**)**——

____w__

——-G——

——ОН——

——Е——

<u>—т</u>—

P 783.25

DEMOLITION NOTES

- All Signs to Be Removed Shall Be Salvaged and Stored in the Owner's Facility for Future Use as Applicable.
 Keep All City Streets Free and Clear of Construction Related Dirt/Dust/Debris.
- 3. Coordinate Existing Utility Removal with Local Authorities and Utility Companies Having Jurisdiction.
- 4. The Existing Building is to Remain Operational During Construction. Therefore, the Temporary Relocation of All Necessary Utilities Serving the Existing Building Shall Be Coordinated Prior to the Commencement of Construction
- 5. All Sawcutting Shall be Full Depth to Provide a Clean Edge to Match New Construction. Match Existing Elevations at Points of Connection for New and Existing Pavement, Curb, Sidewalks, etc. All Sawcut Locations Shown Are Approximate and May Be Field Adjusted to Accommodate Conditions, Joints, Material Type, etc. Remove Minimum Amount Necessary for Installation of Proposed Improvements.
- 6. Provide and Maintain All Necessary Traffic Control and Safety Measures Required During Demolition and Construction Operations Within or Near the Public
- All Light Poles to Be Removed From Private Property Shall Be Removed in Their Entirety, Including Base and All Appurtenances. Coordinate Abandonment of Electrical Lines With Electrical Engineer and Owner Prior to Demolition.
- 8. Perform Tree Pruning In All Locations Where Proposed Pavement And/Or Utility Installation Encroach Within The Existing Drip Line Of Trees To Remain. All Trenching Within The Drip Line Of Existing Trees To Remain Shall Be Done Radially Away From Trunk If Roots In Excess Of 1" Diameter Are Exposed. Roots Must Be Cut By Reputable Tree Pruning Service Prior To Any Transverse Trenching. Obtain Approval Of The Architect Prior To Operations For A Variance From This Procedure.
- Coordinate Tree Removal with Landscape Architect, All Trees To Be Removed Shall Be Ground To Proposed Subgrade. Use Mulch For Proposed Landscaping Where Applicable and Acceptable To Architect.
- 10. Provide Tree Protection Fencing Prior To Construction Operations. Maintain Throughout Construction.

DEMOLITION LEGEND

Bituminous Pavement Removal
(Full Depth)

Concrete Pavement Removal
(Full Depth)

Gravel And Stone Removal And
Replacement To Match Existing —
As Needed For Utility Installation

Brick Paver Removal
(Full Depth)

— — — — — Pavement Sawcut

XX XX Curb & Gutter Removal

×

Tree Removal

Structure Removal

CRYSTAL LAKE

ARCHITECTS

MILWAUKEE | MADISON | TUCSON | CHICAGO

126 W Paddock St

PUBLIC LIBRARY

Crystal Lake, IL 60014
PROJECT NUMBER

ISSUED FOR:

BID PERMIT

REVISION FOR: DATE
NO. DESCRIPTION

1 ADDENDUM #2 11-02-2020

10-21-2020

GENERAL NOTES

- 1. The Location of Existing Underground Utilities, Such As Watermains, Sewers, Gas Lines, Etc., As Shown On The Plans, Has Been Determined From The Best Available Information and Is Given For The Convenience of The Contractor. However, The Owner and The Engineer Do Not Assume Responsibility In The Event That During Construction, Utilities Other Than Those Shown May Be Encountered, and That The Actual Location of Those Which Are Shown May Be Different From The Location As Shown On The Drawings. Contact Engineer Immediately If Surface and/or Subsurface Features Are Different Than Shown On
- Notify The Engineer Without Delay of Any Discrepancies Between the Drawings and Existing Field Conditions.
- Notify The Owner, Engineer and The City of Crystal Lake A Minimum of 48 Hours In Advance of Performing Any Work.
- 4. All Areas, On or Off Site, Disturbed During Construction Operations and Not Part of the Work As Shown Hereon Shall Be Restored To Original Condition to the Satisfaction of the Owner at No Additional Cost to the Owner. It is Incumbent Upon Contractor to Show That Damaged Areas Were Not Disturbed By Construction Operations.
- These Drawings Assume That The Contractor Will Utilize An Electronic Drawing File (DWG) and Stake All Site Improvements Accordingly.
- No Person May Utilize The Information Contained Within These Drawings Without Written Approval From Eriksson Engineering Associates, Ltd.
- 7. The Engineer Is Furnishing These Drawings For Construction Purposes As A Convenience To The Owner, Architect, Surveyor, or Contractor. Prior To The Use Of These Drawings For Construction Purposes, The User Of This Media Shall Verify All Dimensions And Locations Of Buildings With The Foundation Drawings And Architectural Site Plan, and Coordinate All Dimensions and Locations of All Site Items. If Conflicts Exist The User Of This Information Shall Contact The Engineer Immediately.
- 8. Provide An As-built Survey Prepared By A Licensed Professional Land Surveyor In Accordance With The Authorities Having Jurisdiction Which Shall Include As a Minimum All Storm Sewers, Structure Locations, Sizes, Rim and Invert Elevations.
- 9. The Illinois Department Of Transportation Standard Specifications For Road And Bridge Construction Latest Edition, And All Addenda Thereto, Shall Govern The Earthwork And Paving Work Under This Contract Unless Noted Otherwise.

DRAWN BY MC

DEMOLITION PLAN

CHECKED BY

SURVEY PROVIDED BY:

Plat of Survey and Topography Provided By RE Allen And Associates, Ltd. For Eriksson Engineering Associates, Ltd. on July 24th, 2020. File Number 86—20.

PROJECT BENCHMARKS

<u>Site Benchmark</u> Description: Cut "X" Cross On Concrete Sidewalk. Elevation: 910.69 (NAVD88)

J.U.L.I.E.

Note: The exact location of all utilities shall be verified by the contractor prior to construction activities. For utility locations call: J.U.L.I.E. 1 (800) 892—0123

C100





MILWAUKEE | MADISON | TUCSON | CHICAGO

Scale: 1"=20'

LEGEND

GEOMETRY NOTES

- All Dimensions Contained Herein Reference Back Of Curb, Face Of Retaining Wall, Edge Of Pavement, Center of Structure And Outside Face Of Building Foundation Unless Otherwise Noted.
- All Pavement Striping Shall Be 4" Wide Yellow Paint Per Specifications. All Cross Hatch Striping Shall Be 45 At 2'-0" Centers.
- 3. Refer to Architectural Drawings for Exact Locations of All
- Refer to Architectural Drawings for Locations and Details of All Permanent Site Fencing.
- Traffic Sign Posts Shall Be Breakaway Green U-Channel Posts, 2-lb/ft, 11 Gauge Steel, Embedded 42" Minimum Into Ground.

EXISTING		PROPOSED
©	Manhole	• Nor 3322
	Catch Basin	
	Inlet	_
\wedge	Area Drain	_
	Clean Out	_
O _{c.o.}	Flared End Section	O _{c.o.}
	Storm Sewer	
	Sanitary Sewer	<u> </u>
>	Combined Sewer	<u> </u>
W	Water Main	w
——- G ———	Gas Line	——-G——-
OH	Overhead Wires	——он——
——— E ———	Electrical Cable (Buried)	——Е——
—— т——	Telephone Line	—т
A	Fire Hydrant	A
\otimes	Valve Vault	•
\bigotimes_{B}	Buffalo Box	₽
O _{DS}	Downspout	ODS
O _{BOL}	Bollard	O _{BOL}
$\otimes_{_{G}}$	Gas Valve	
\bigcirc _G	Gas Meter	
\bigcirc E	Electric Meter	
© _{CE}	ComEd Manhole	
Н	Hand Hole	
X	Light Pole	\mathbf{x}
$\circ \longrightarrow \hspace{-0.5cm} \swarrow$	Light Pole w/ Mast Arm	
-0-	Utility Pole	-0-
⊠ _T	Telephone Pedestal	
○ _T	Telephone Manhole	
0	Sign	•
××	Fence	xx
	Accessible Parking Stall	<u>E</u>
	Curb & Gutter	
	Depressed Curb	
× C 782.50	Curb Elevation	C 782.50_
x G 782.00	Gutter Elevation	G 782.00
x P 783.25	Pavement Elevation	P 783.25
× W 782.10	Sidewalk Elevation	<i>₩ 782.10</i>
x 784.0	Ground Elevation	_x 784.0
× T/W 785.20	Top of Retaining Wall Elevation	T/W 785.20
701	Swale	701
781—	Contour Line	781
M (•)	Deciduous Tree	
W W	Coniferous Tree	
V \	Brushline	
	Tree Protection Fencing at Drip Line	——-х

GENERAL NOTES

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- 8. Provide An As-built Survey Prepared By A Licensed Professional Land Surveyor In Accordance With The Authorities Having Jurisdiction Which Shall Include As a Minimum All Storm Sewers, Structure Locations, Sizes, Rim and Invert Elevations.
- 9. The Illinois Department Of Transportation Standard Specifications For Road And Bridge Construction Latest Edition, And All Addenda Thereto, Shall Govern The Earthwork And Paving Work Under This Contract Unless Noted Otherwise.

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PROJECT NUMBER

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REVISION FOR: DATE NO. DESCRIPTION 1 ADDENDUM #2 11-02-2020

DRAWN BY CHECKED BY

GEOMETRY PLAN

SURVEY PROVIDED BY:


Plat of Survey and Topography Provided By RE Allen And Associates, Ltd. For Eriksson Engineering Associates, Ltd. on July 24th, 2020. File Number 86—20.


PROJECT BENCHMARKS

<u>Site Benchmark</u> Description: Cut "X" Cross On Concrete Sidewalk. Elevation: 910.69 (NAVD88)


J.U.L.I.E.

Note: The exact location of all utilities shall be verified by the contractor prior to construction activities. For utility locations call: J.U.L.I.E. 1 (800) 892-0123

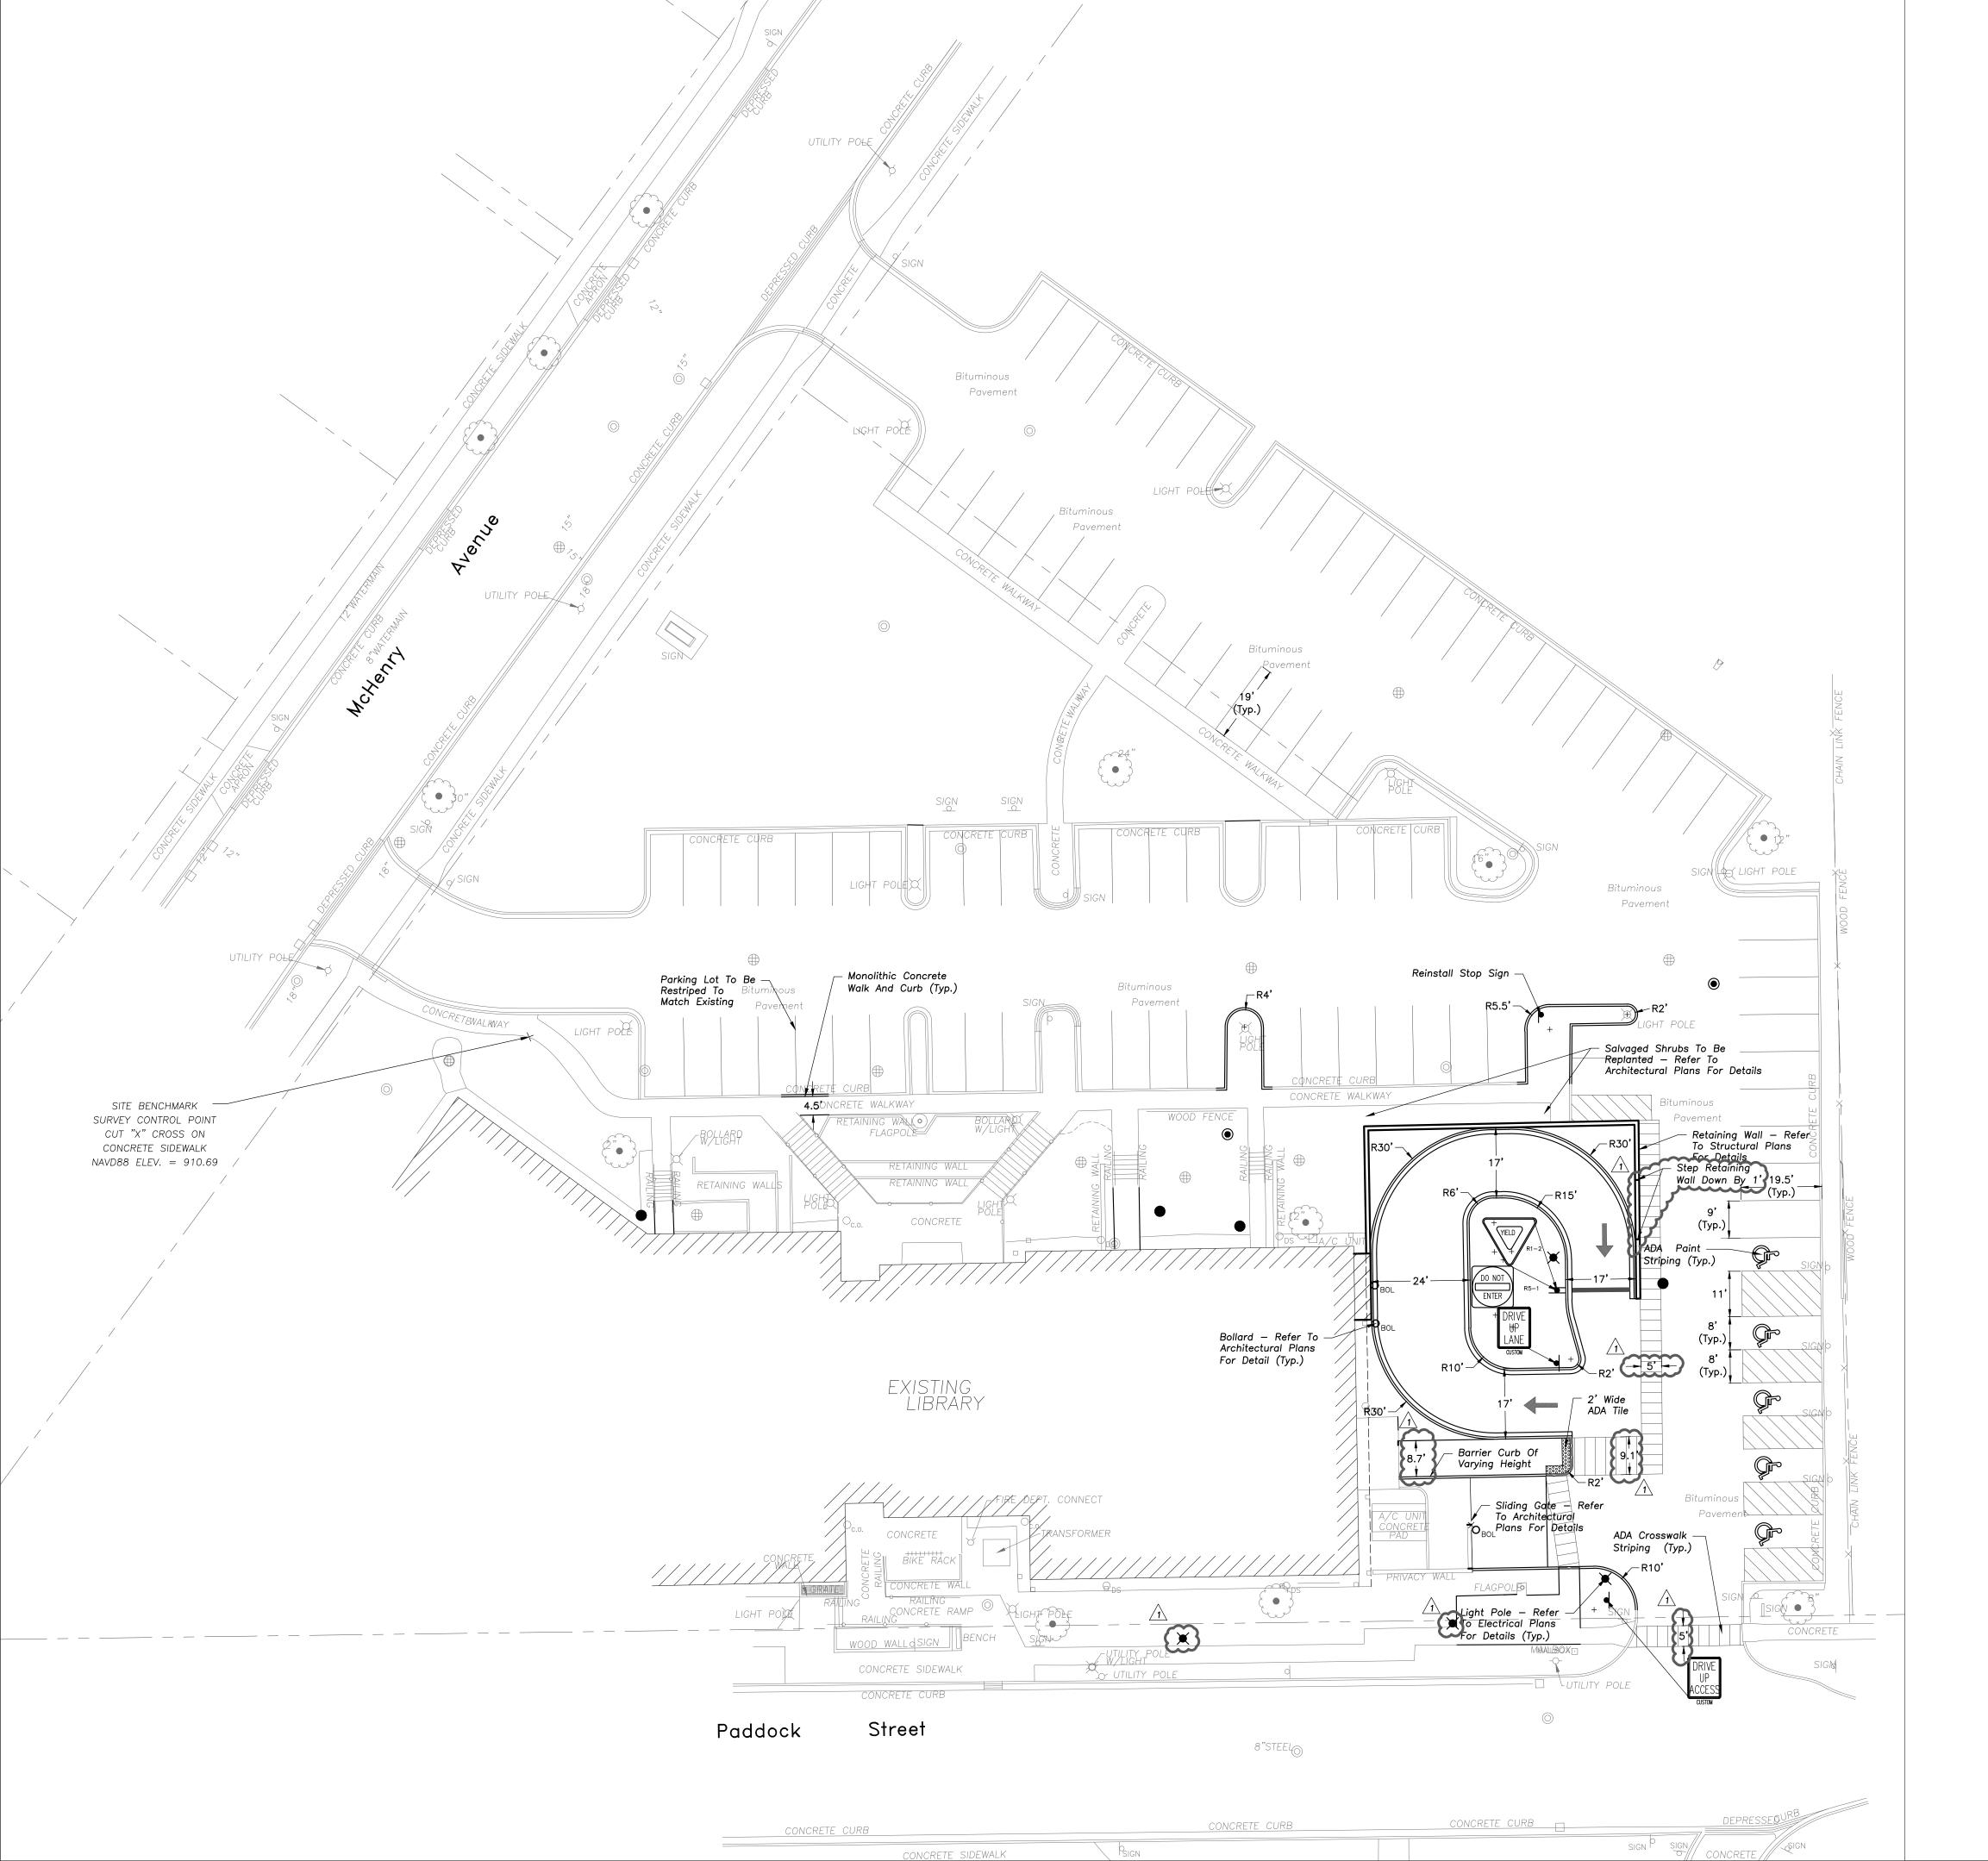

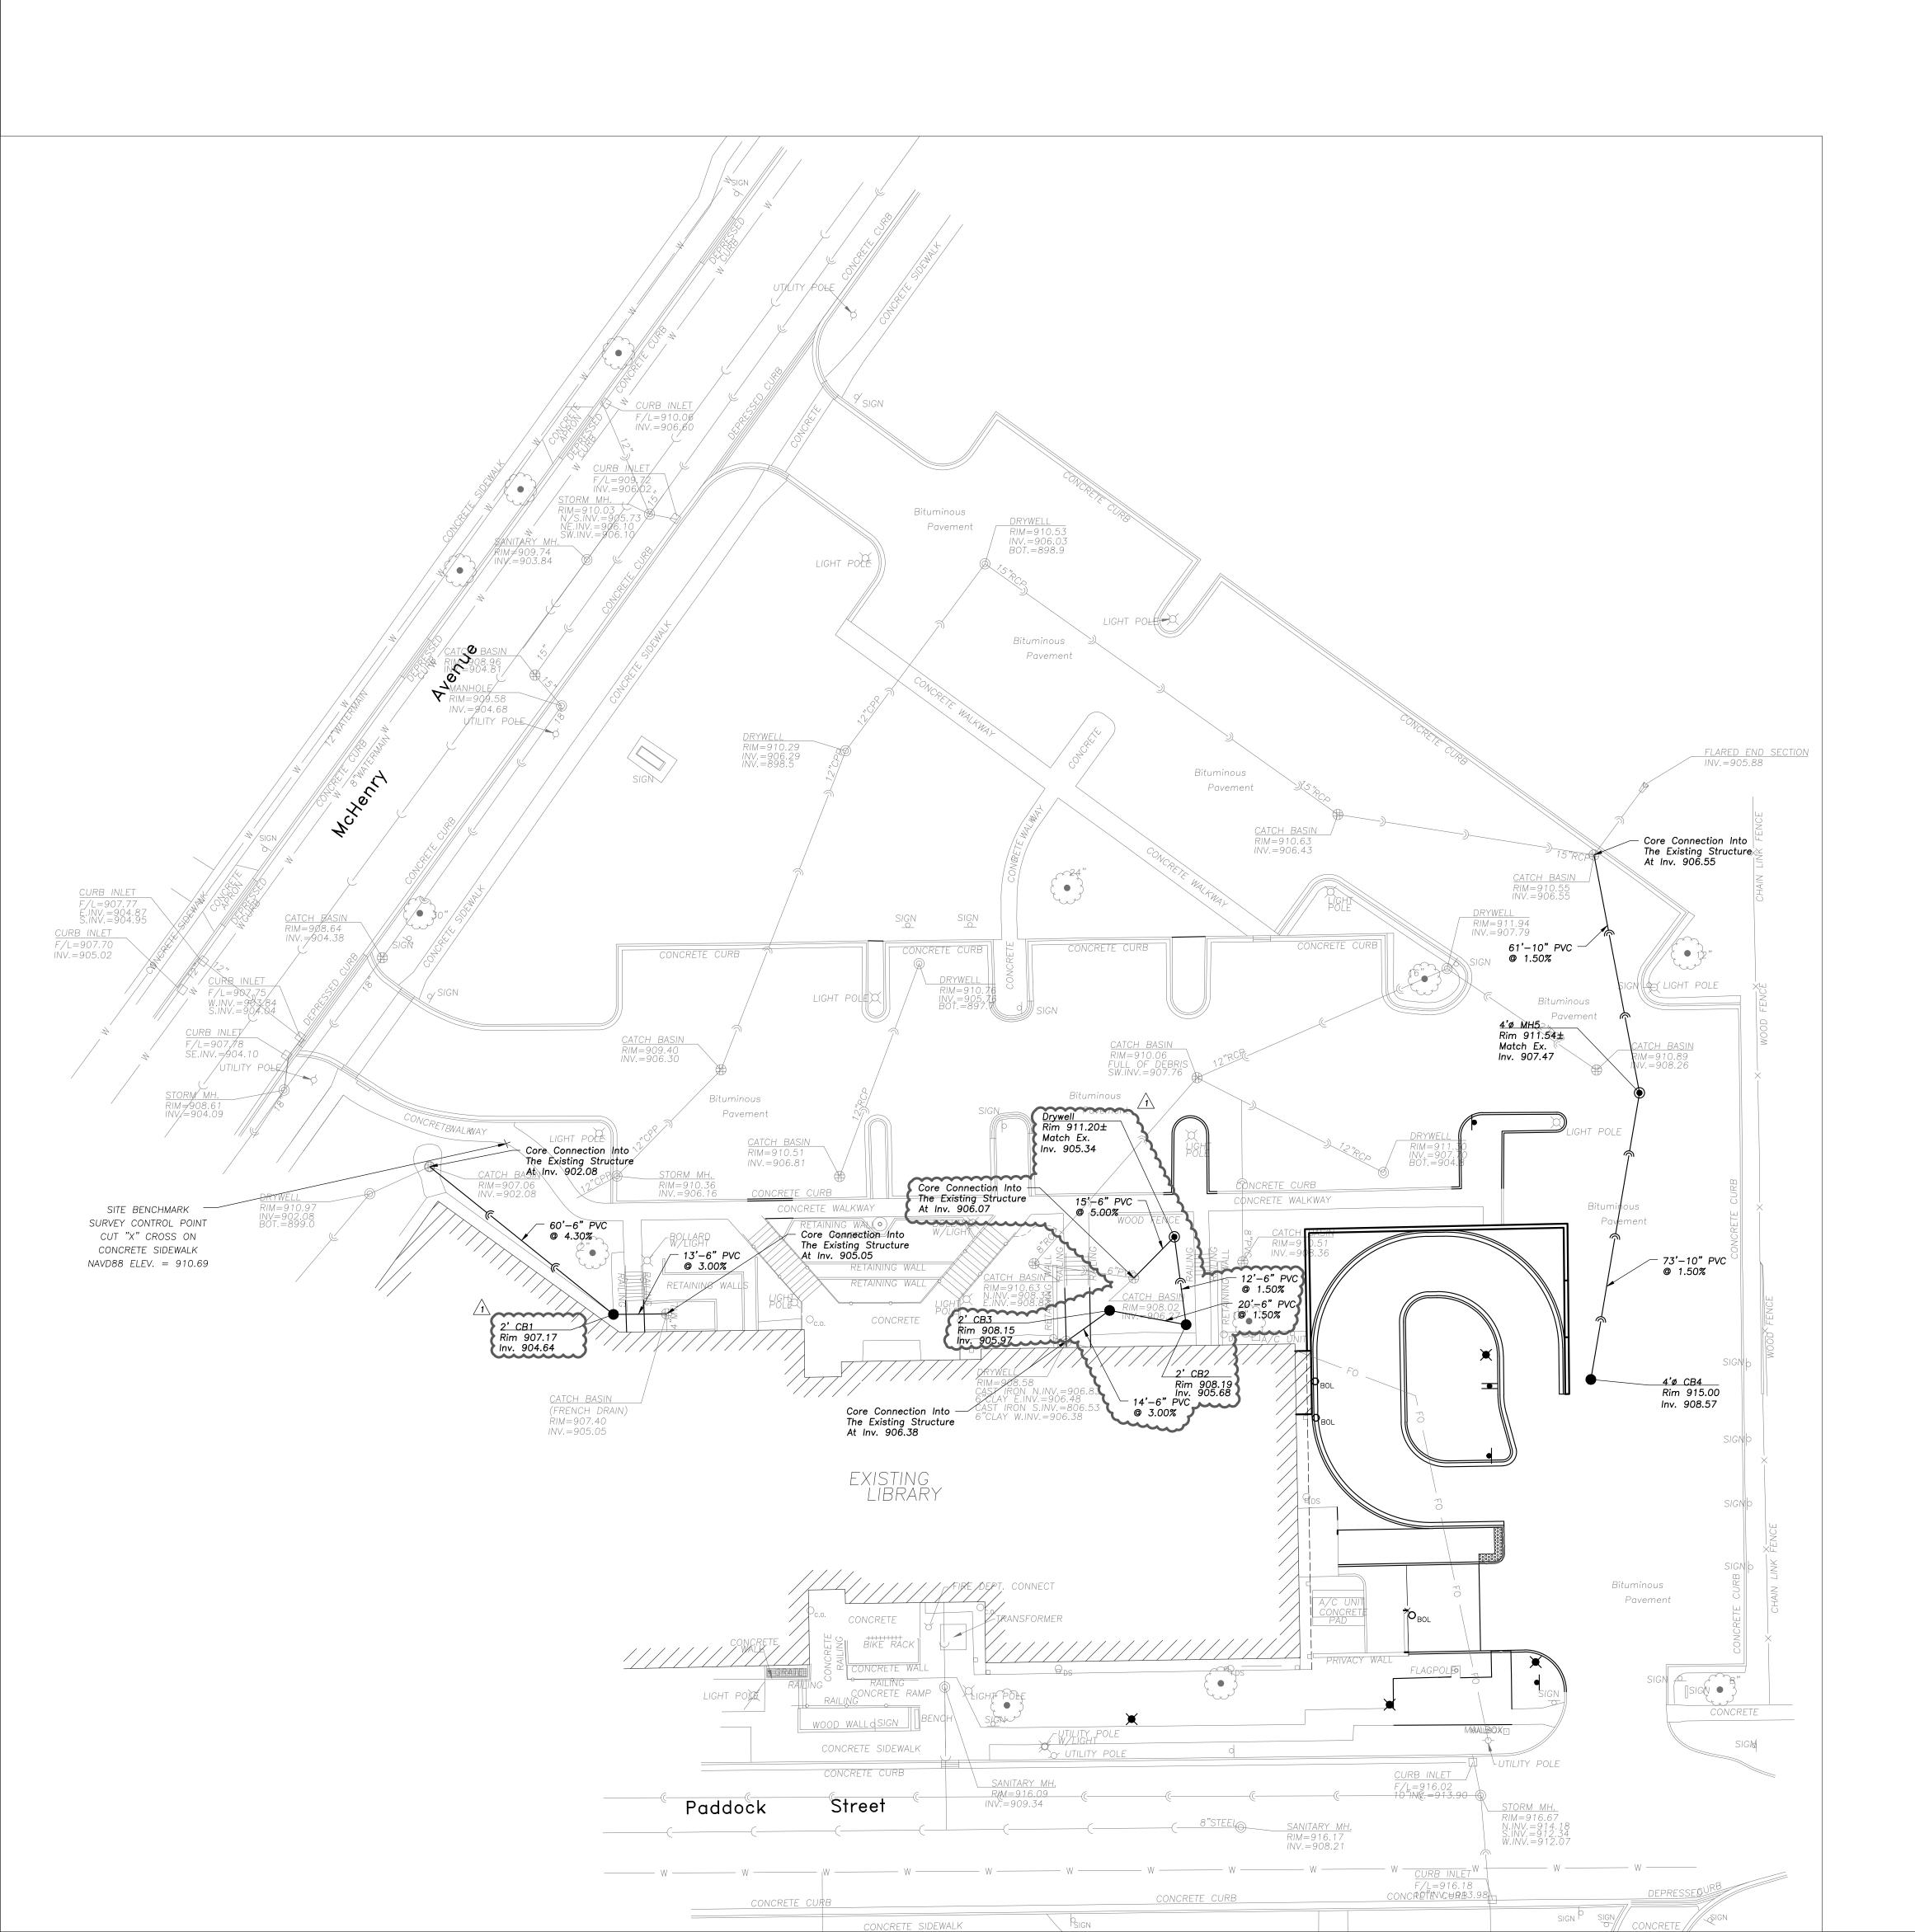



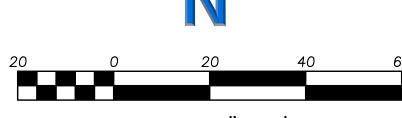

LEGEND

Manhole

Catch Basin

Flared End Section

Storm Sewer

Gas Line

Sanitary Sewer Combined Sewer

Overhead Wires

Electrical Cable

Telephone Line

Fire Hydrant

Valve Vault

Buffalo Box

Bollard

Gas Valve Gas Meter

Electric Meter ComEd Manhole

Hand Hole Light Pole

Utility Pole

Curb & Gutter

Curb Elevation

Gutter Elevation

Ground Elevation

Coniferous Tree

Tree Protection Fencing at Drip Line

Brushline

Pavement Elevation Sidewalk Elevation

Telephone Pedestal Telephone Manhole

PROPOSED

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——-G——

——ОН——

——Е——

<u>—т</u>—

x-----x

P 783.25

_x 784.0

••• _____781____

Scale: 1"=20'

EXISTING

——E——

x C 782.50

x G 782.00

x P 783.25

× T/W 785.20

x 784.0

UTILITY NOTES

- 1. Utility Service Lines as Shown Hereon are Approximate. Coordinate The Exact Locations With The Plumbing Drawings. Coordinate The Locations With The Plumbing Contractor and/or the Owner's Construction Representative Prior to Installation of Any New Utilities.
- 2. Field Verify Invert & Locations of Existing Utility Mains
 Prior to Installing Any On—Site Utilities or Structures. All Elevations and Inverts Referencing Said Utility Shall Be Field Verified Prior To Installation Of Any New Structures Or Utilities, and Adjustments Shall Be Made as Necessary. Contact Engineer Prior to Installation if Discrepancy Exists With These Drawings.
- 3. Coordinate the Relocation Of Any Utilities Encountered And Replacement Of Any Utilities Damaged Within Influence Zone Of New Construction. Contact Engineer If The Existing Utilities Vary Appreciably From The Plans.
- Section 370.350 of the Illinois Recommended Standards for Sewage Works or Section 41-2.01 of the Standard Specifications for Water and Sewer Main Construction in Illinois, latest edition.

4. Protection of water supplies shall be as described in

- 5. Clean Out All Existing and Proposed Storm Inlets and Catch Basins at the Completion of Construction.
- 6. The "Standard Specifications for Water and Sewer Main Construction in Illinois", Current Edition Shall Govern Work Where Applicable.

STRUCTURE NOTES

1. All Catch Basins to Be Installed in Paved Areas Shall Have

	Neenah R2504—D Frame & Grate or Approved Equal.
2.	All Manholes Shall Have Neenah R1713—B Frame & Closed Lid or Approved Equal, with "Storm" or "Sanitary" Imprinted as Appropriate.

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1 ADDENDUM #2

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DRAWN BY	МС
CHECKED BY	MR

UTILITY PLAN

SURVEY PROVIDED BY:

Plat of Survey and Topography Provided By RE Allen And Associates, Ltd. For Eriksson Engineering Associates, Ltd. on July 24th, 2020. File Number 86—20.

PROJECT BENCHMARKS

<u>Site Benchmark</u> Description: Cut "X" Cross On Concrete Sidewalk. Elevation: 910.69 (NAVD88)


J.U.L.I.E.

Note: The exact location of all utilities shall be verified by the contractor prior to construction activities. For utility locations call: J.U.L.I.E. 1 (800) 892-0123

C300





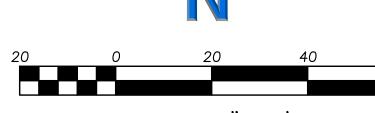

Scale: 1"=20'

LEGEND **GRADING NOTES EXISTING** PROPOSED The Grading and Construction of Proposed Improvements Shall Be Done In A Manner Which Will Allow For Positive Manhole Drainage, and Not Cause Ponding of Stormwater on the Catch Basin Surface of Proposed Improvements. 2. All Landscaped Areas Disturbed By Construction Shall Be Area Drain Respread With 6 Inches (Min.) to 12 Inches (Max.) Topsoil and **Hydroseeded** Unless Noted Otherwise On The Landscape Drawings. Flared End Section 3. Accessible Parking Spaces and Loading Spaces Shall Be ——**)**—— Sloped at Maximum 2.0% in Any Direction. Maximum Sanitary Sewer Sidewalk Cross Slopes Shall be 2.0%. Maximum Longitudinal Sidewalk Slope Shall Be 4.9%. Contact Engineer if Conflicts Exist. **——** ____w___ ——-G—— SOIL EROSION & ——ОН—— Overhead Wires ——Е—— SEDIMENTATION CONTROL NOTES <u>—т</u>— Telephone Line Fire Hydrant 1. Illinois Urban Manual Shall Govern All Soil Erosion and Sediment Control, and Related Work. Buffalo Box 2. Soil Disturbance Shall Be Conducted in Such a Manner as To Minimize Erosion. Soil Stabilization Measures Shall Consider the Time of Year, Site Conditions, and the Use Bollard of Temporary or Permanent Measures. Gas Valve 3. Soil Erosion and Sediment Control Features Shall Be Gas Meter Constructed Prior to the Commencement of Upland Electric Meter 4. All Storm Sewer Structures That Are, Or Will Be, ComEd Manhole Functioning During Construction Shall Be Protected, Filtered, Or Otherwise Treated To Remove Sediment. The Hand Hole General Contractor Shall Use "Catch-All" Inlet Protectors Light Pole (or equal) and Filter Wattles Around The Grate In Landscaped Areas And "Catch-All" Inlet Protectors (or equal) In Paved Areas To Prevent Siltation. Utility Pole

5. Install And Maintain Silt Fence At The Perimeter Of The Construction Zone And Wetland Areas And As Shown On

6. The Erosion Control Measures Indicated On The Drawings Are The Minimum Requirements. Additional Measures May

7. Unless Otherwise Indicated on the Drawings, Stabilize All

9. All Concrete Washout Shall Conform To The "Temporary Concrete Washout Facility" Standards (Code 954) of the

 Dewatering of Excavations Shall be Performed in a Manner Such as Through the use of Filter Bags or Polymer Treated Dewatering Swales, so as to Not Discharge Sediment Laden Water Into Storm Sewers Tributary to

8. Report Releases of Reportable Quantities of Oil or

Control Blanket, or Approved Equal.

Illinois Urban Manual, Latest Edition.

NPDES Requirements.

Open Water.

The Plans. Maintain Silt Fence Throughout Construction And Until Vegetation Has Been Fully Established.

Be Required As Directed By The Qualified Soil and Erosion Sediment and Control Inspector Or Governing Agency.

Disturbed Ground Areas Where Slopes Exceed 6:1 or Within

Swales with North American Green BioNet SC150BN Erosion

Hazardous Materials If They Occur In Accordance with IEPA

PAVING & SURFACE

Asphalt Pavement Section

Concrete Sidewalk Section

5" Portland Cement Concrete

Asphalt Pavement Seal Coat

Concrete Driveway Section

8" Portland Cement Concrete

Coal Tar)

Prime Coat (0.25 gal/sq yd)

LEGEND

1 1/2" Hot Mix Asphalt, Mix D, IL-9.5, N50

2" Aggregate Base Course, Type B, Crushed

Re-Stripe Lot - Refer To C200 For Striping

6" Aggregate Base Course, Type B, Crushed

8" Aggregate Base Course, Type B, Crushed, CA-6

Seal Coat & Crackfill (Asphalt Emulsion Based, No

2 1/2" Hot Mix Asphalt, IL-19.0, N50

Non-Woven Geotextile Fabric, 5 oz/sy

6"x6" W1.4xW1.4 Welded Wire Fabric

Crack Fill To Utilize Compressed Air

6"x6" W2.9xW2.9 Welded Wire Fabric

LEGEND

Silt Fence

Catch-All, Pork Chop Sediguard (or

equal) Paved or Existing Stabilized

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BID PERMIT

1 ADDENDUM #2

REVISION FOR: DATE NO. DESCRIPTION

10-21-2020

11-02-2020

GENERAL NOTES

Coniferous Tree

Fencing at Drip Line

Brushline

Telephone Pedestal

Telephone Manhole

Accessible Parking Stall

Curb & Gutter

Curb Elevation

Gutter Elevation

Pavement Elevation

Sidewalk Elevation

x C 782.50

x G 782.00

x P 783.25

× T/W 785.20

Depressed Curb

x-----x

P 783.25

T/W 785.20

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DRAWN BY CHECKED BY

GRADING AND PAVING PLAN

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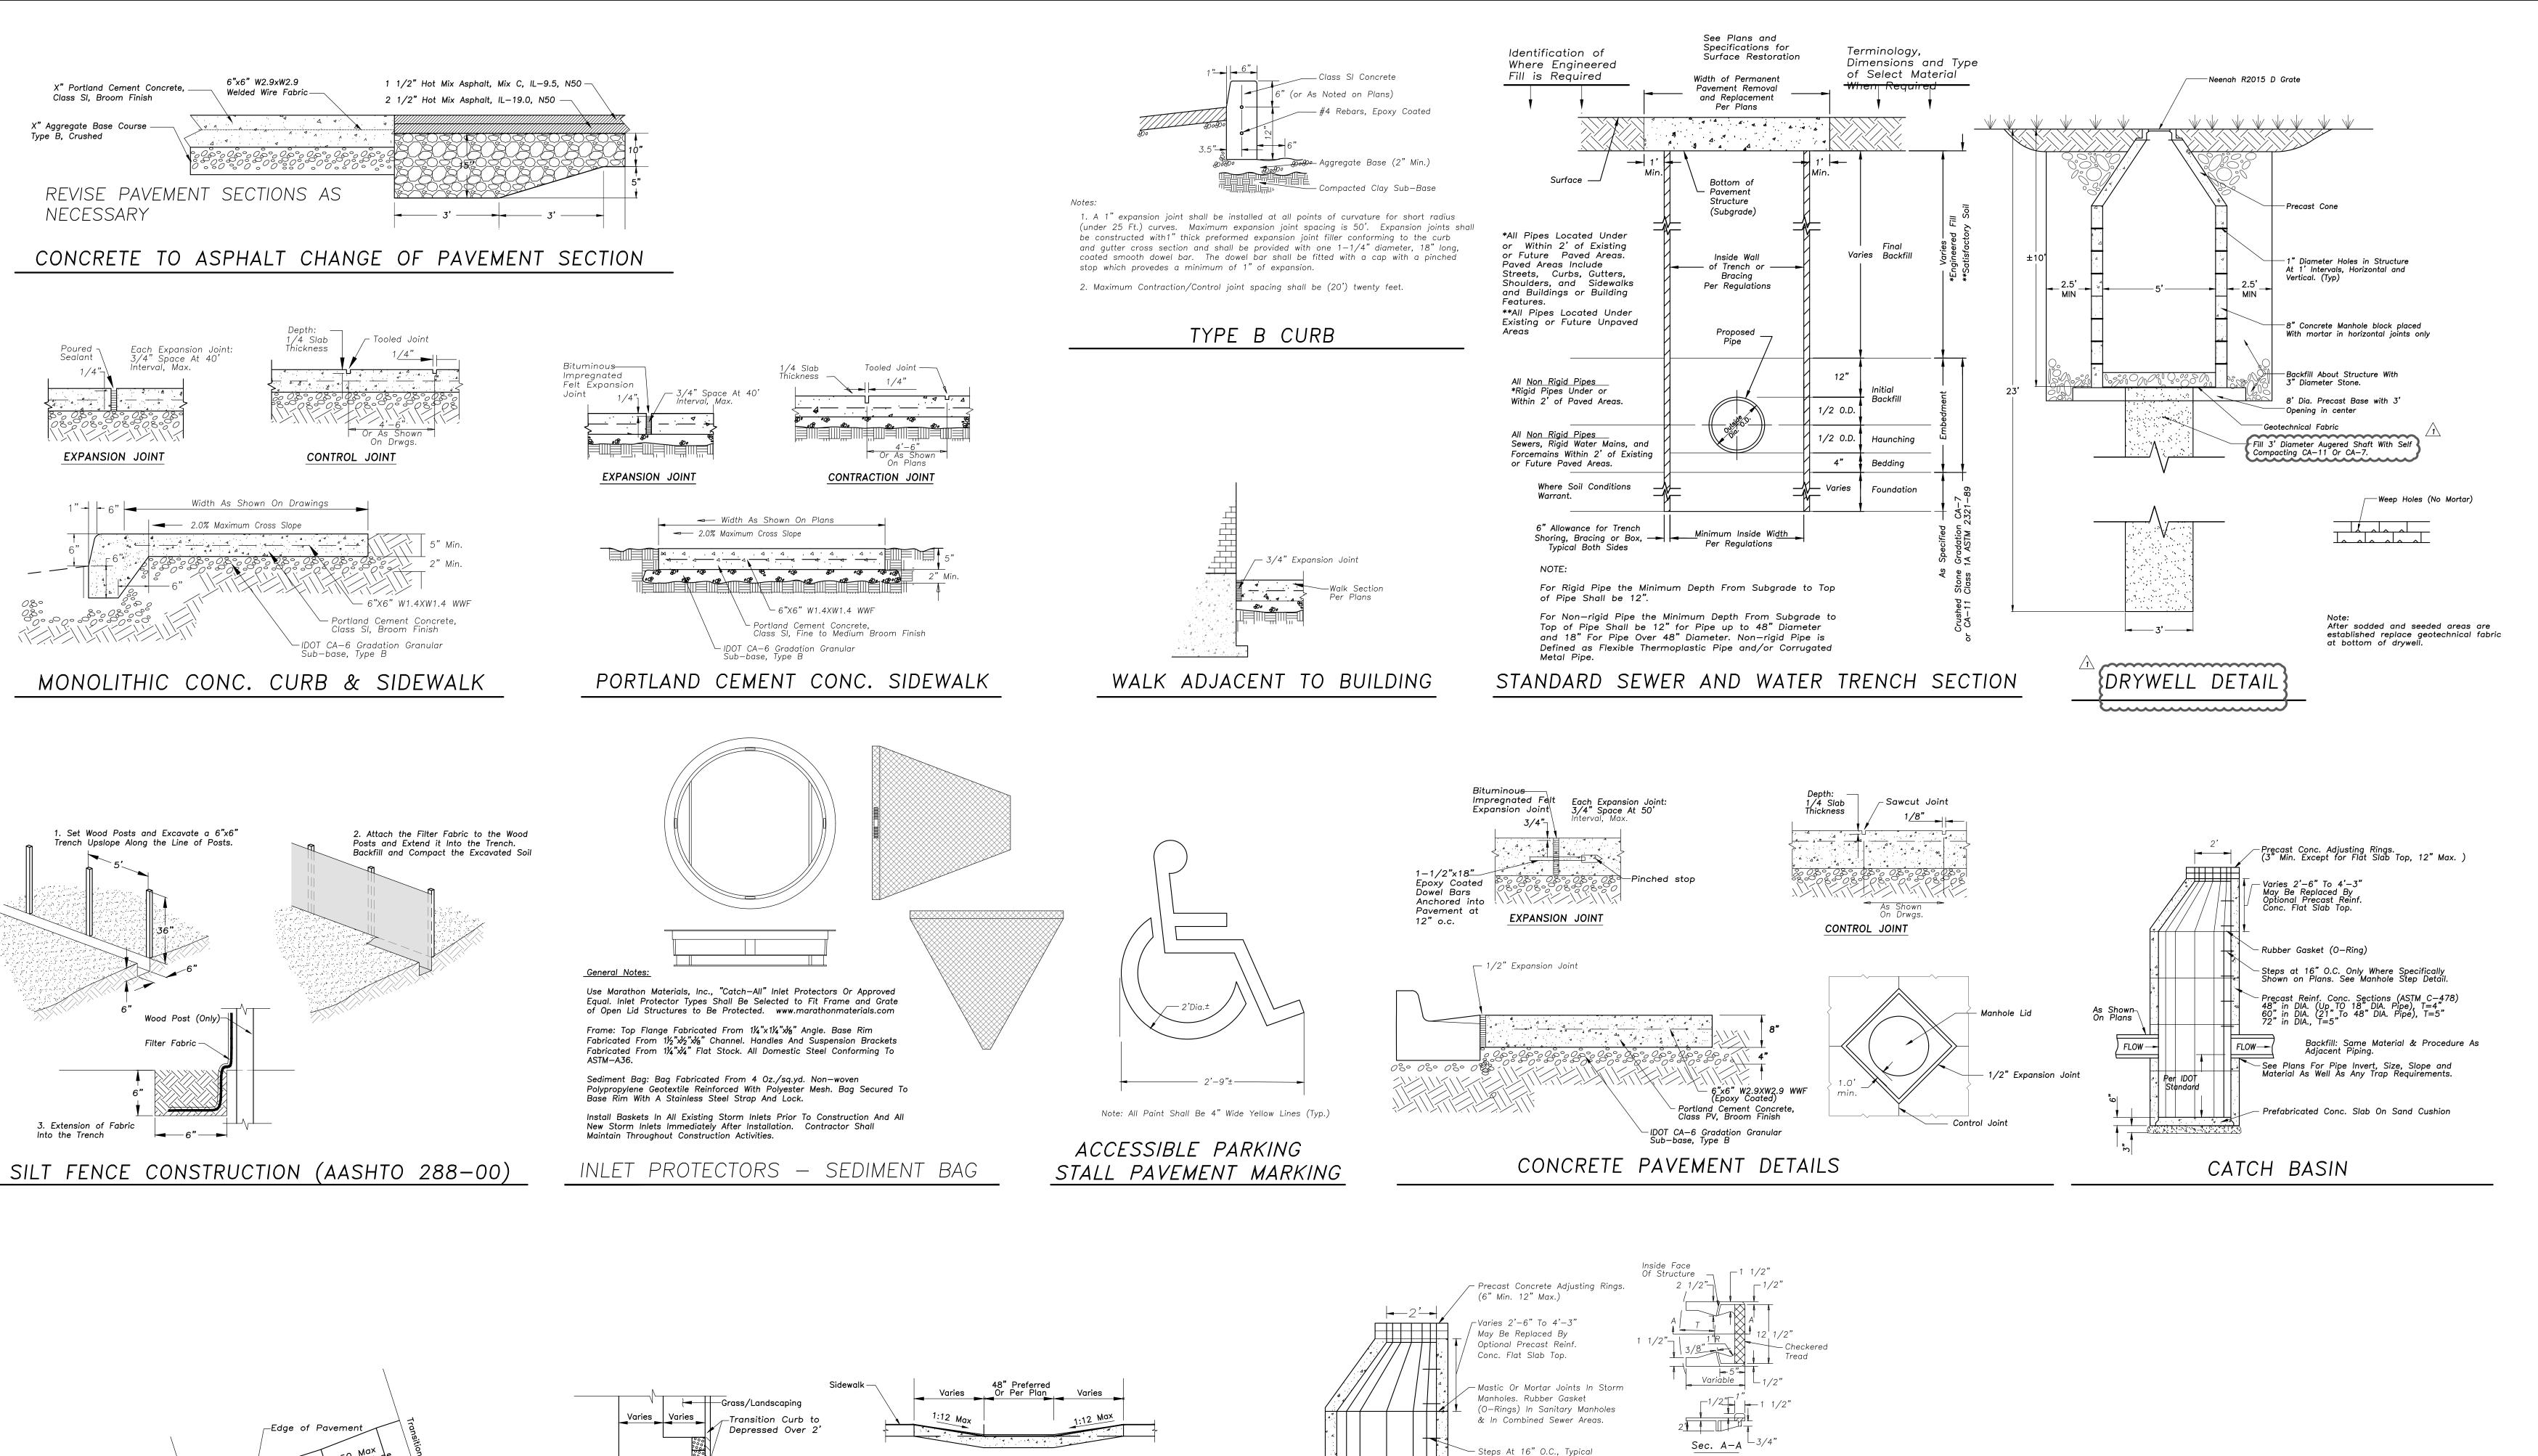
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C400



(3" Embedment, Min.)

Sand Cushion.

Adjacent Piping.

CATCH BASIN - 2' DIA.

MANHOLE - 48"-60" DIA.

Precast Conc. Adjusting Rings. (3" Min., 8" Max.)

— Precast Reinf. Conc. Sections

See Plans For Pipe Invert, Size, Slope, and Material.

15" Unless Otherwise

Noted on Plans.

(ASTM C-478)

✓ Precast Reinf. Conc. Sections (ASTM C−478)

— Install Resilient Connectors (ASTM C-923) In

Sanitary And Combined Sewer Area Manholes.

- Existing Sewer Or Sewer To Be Constructed. (Pipe Size, Material, And Slope Per Drawings)

- Class SI Concrete Bench (May Be Prefabricated)

Prefabricated Conc. Slab On Sand Cushion Or

Cast — in — Place, Class SI Concrete without

Backfill: Same Material & Procedure As

48" DIA. (Up TO 18" DIA. Pipe), T=4"

60" DIA. (21" To 48" DIA. Pipe), T=5"

CURB RAMP SECTION VIEW

<u>Description:</u>
This work shall consist of constructing sidewalk curb ramps with detectable warnings in compliance with

the Americans with Disabilities Act, Accessibility Guidelines (ADAAG).

The detectable warnings shall consist of an area of truncated domes that provide both visual and tactile

Ramps Shall Be Located As Shown On Plans In Alignment With Normal Sidewalk And/or Crosswalk And

2. Curb Ramps At Marked Crossings Shall Be Wholly Contained Within The Markings Excluding Flared Sides.

Flexible Filler In Accordance With The Illinois Department Of Transportation (IDOT) Standard Specifications.

comply with the detectable warnings on walking surfaces section of the Americans with Disabilities Act

Dimensions: Cast In Place Detectable/Tactile Warning Surface Tiles shall be held within the following

(Title III Regulations, 28 CFR Part 36 ADA STANDARDS FOR ACCESSIBLE DESIGN, Appendix A, Section 4.29.2

Length and Width in One of the Following as Necessary for the Dimensions of the Surface In Which the Detectable Warning is Proposed: 12x12 24x24 24x36 24x48 24x60 36x48 36x60 nominal. No Cutting of

Verify With the Local Authorities Having Jurisdiction that Detectable/Tactile Warning Surface Tiles are an

Verify With the Local Authorities Having Jurisdiction that the Manufacturer's Products are Acceptable for the

<u>Equipment:</u> Equipment for the detectable warning area of the curb ramps shall meet the requirements of

The detectable warnings shall present a contrast in color from the adjacent sidewalk.

Conc. Curb
 3. In No Case Shall Expansion Joints That Are Constructed In Curbs And Gutters At Or Near Corner
 Line With Radiuses Be Located Within The Accessible Ramp Areas.

Installation of Detectable/Tactile Warning Surface Tiles Per Manufacturer's Instructions.

Provide Surface Applied Detectable/Tactile Warning Surface Tiles which

Acceptable Method of Providing for the Detectable Warning Surface.

Shall Have Sufficient Curb Length At Corner Radius To Prevent Vehicular Encroachment.

Joint Filler 4. Where Preformed Joint Filler (p.j.f) Is Installed Against A Curved Surface, The Contractor Shall Use A

DEPRESSED CURB AND GUTTER AT CURB RAMP

Face of Curb

Pavement Section

-3/4" Expansion Joint Flush to Concrete

Surface

-Grass/Landscaping

GENERAL NOTES

cues to pedestrians who are about to enter into traffic.

DETECTABLE WARNING SURFACE TILES

dimensions and tolerances:

Detectable Warning Surface.

,—See Curb Ramp

48" Preferred

CURB RAMP IN PAVEMENT

PERPENDICULAR CURB RAMP GEOMETRY

Detectable Warning Tile

Expansion

In Pavement

Detail

TRUNCATED DOME DETAIL

(REQUIRED FOR TYPE A & B RAMPS)

SQUARE PATTERN (PARALLEL ALIGNMENT)

DETECTABLE WARNINGS DETAIL

PARALLEL CURB RAMP DETAIL

_1:12 Flares

Paved Area,

1:50 Max Cross

ACCESSIBLE RAMPS FOR SIDEWALKS

Slope, Typ.<

Dummy Joint All

Around

When In

N.T.S

Detectable__

|Warning Tile


Depressed (and Gutter

Transition Curb to—/

in Landscape Area

CURB RAMP AT RADIUS SKEWED INTERFACE DETAIL

Depressed over 2'

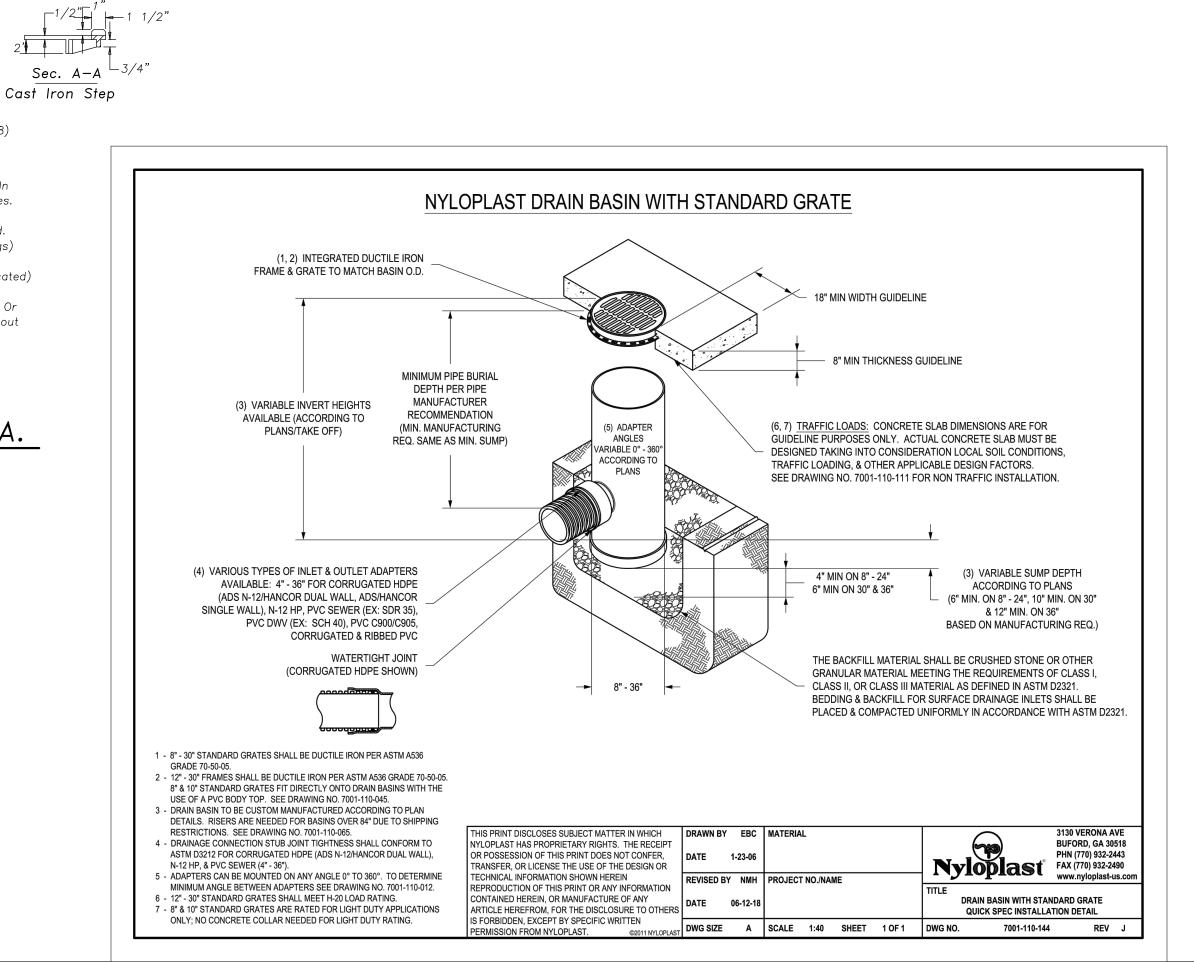

DRAWN BY **CHECKED BY** SITE DETAILS

ARCHITECTS

10-21-2020

DATE

11-02-2020

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