

#2020-165 WK Building and Development Inc. Project Review for Planning and Zoning Commission

Meeting Date: June 16, 2021

Request: 1. Final Planned Unit Development Amendment to

construct two duplex units.

2. Final Plat of Resubdivision creating a two-lot

subdivision for Lot 110

Location: 700, 704, 708, 712, and 716 Oak Hollow Road

Acreage: Approximately 0.58 acres

Existing Zoning: R-3B PUD Multi-Family Residential

Surrounding Properties: North: R-2 Single Family Residential

South: R-3B PUD Multi-Family Residential East: R-3B PUD Multi-Family Residential West: R-3B PUD Multi-Family Residential

Staff Contact: Elizabeth Maxwell (815.356.3615)

Background:

- On January 19, 2021, the petitioner requested a Text Amendment modifying the language of the Unified Development Ordinance for Residential Planned Unit Developments from the requirement to have 100% of the individual owners sign off on an application. That amendment was approved allowing only 90% of the owners in the same category of dwelling in the PUD and 75% of any other category of dwelling type in the PUD. The petitioner has obtained these approval sign offs.
- The PUD originally contemplated that this would be a 5-unit townhome building. The current market is not supportive of interior units. The petitioner is requesting to amend the Final PUD this allow two duplex units so there would be a total of 4 end units which are much more marketable.

Development Analysis:


Land Use/Zoning

• The site is zoned R-3B PUD Multi-Family Residential. This is the most appropriate zoning district for the residential units.

• The land use map shows the area as High Density Residential. This is an appropriate land use designation for residential development.

Building Elevations:

- The petitioner matched much of the same styling as the 5-unit buildings to blend within the neighborhood. The window trim, roof style, garage, trim above the garage, exterior materials and design all duplicate the original townhouse architecture.
- Adding the chimney on either end and doors on the ends facing forward are the two main changes.
- The first image below is the proposed architecture. The second image below is the approved original PUD architecture.

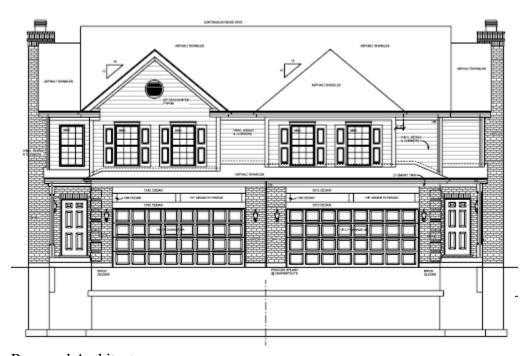

Proposed Architecture



Originally Approved Architecture

Subdivision:

- Lot 110 was originally a lot for a 5-unit townhome building.
- The lot is being resubdivided into two new lots, each lot would have a duplex unit on it.
- The two new individual lots meet the R-3B zoning district standards.

Findings of fact:

FINAL PLANNED UNIT DEVELOPMENT AMENDMENT

The petitioner is requesting approval of a Final Planned Unit Development Amendment to allow the changes to the approved unit type from a 5-unit townhome to two 2-unit duplexes. The purpose of Planned Unit Developments is to encourage and allow more creative and imaginative design of land developments than is possible under district zoning regulations. Planned Unit Developments are, therefore, intended to allow substantial flexibility in planning and designing a proposal. The proposed amendment enhances the character of the center and allows for a new and unique design for these tenants.

This flexibility is often in the form of relief from compliance with conventional zoning ordinance site and design requirements which may otherwise require individual requests and applications for zoning variations.

Ideally, this flexibility results in a development that is better planned, contains more amenities, and is ultimately more desirable than one that would have been produced through compliance with typical zoning ordinance and subdivision controls.

Therefore more lenient site requirements may be granted where the Planned Unit Development contains features not normally required of traditional developments. Although a formal variation request is not required to be made in conjunction with a Planned Unit Development, Staff identifies those aspects of the Planned Unit Development which effectively result in variations from UDO requirements. If the evidence is not found to justify these variations from the UDO that fact shall be reported to the City Council with a recommendation that the variations from the UDO which are proposed as part of the Planned Development be lessened or denied.

FINAL PLAT OF RESUBDIVISION

The petitioner is requesting Final Plat of Subdivision approval for a minor subdivision to amend Lot 110 to two lots allowing for the two duplex units. Final Plats are required to meet the following requirements:

a)	Promote the health, safety, morals, convenience, order, prosperity and welfare of the present and future inhabitants of the City by providing for the orderly growth and development of the City;
	☐ Meets ☐ Does not meet
b)	Coordinating streets and roads within proposed subdivisions with the City's planned street system, and with other public facilities;

Ashton Pointe June 16, 2021

Final Planned Unit Development Amendment and Subdivision

c)	Providing right-of-wa	y easements for streets and utilities;
	☐ Meets	Does not meet
d)	Avoiding congestion in relation to existing Meets	and overcrowding, and encouraging the proper arrangement of streets or planned streets; Does not meet
e)	Ensuring there is adec	quate open space and recreation facilities to serve development; Does not meet
f)	Ensuring there is prop Meets	per recordation of landownership records; Does not meet
g)	Installation of any pul parkway trees, and sid	blic improvements including water, sewer, storm sewer or detention, dewalks;
	☐ Meets	Does not meet
h)	Burial of overhead uti	ality lines and all new lines and services in appropriate easements; and Does not meet
i)	order to protect the ge	n of such other matters as the City Council may deem necessary in eneral health, safety, and welfare of the City
mp:	<i>Meets</i> rehensive Land Use F	Does not meet Plan 2030 Summary Review:

Co

The Comprehensive Plan designates the subject property as High Density Residential, which allows for existing and future multi-family homes. The following goals are applicable to this request:

Land Use - Residential

Goal: Encourage a diversity of high-quality housing in appropriate locations throughout the City that supports a variety of lifestyles and invigorates community character.

This can be accomplished with the following supporting action:

Supporting Action: Provide for a reasonable rate of residential growth especially infill growth and mixed-use development which take advantage of existing city services.

Success Indicator: Approval of minor subdivisions to increase infill lot potential.

Recommended Conditions:

If a motion to recommend approval of the petitioner's request is made, the following conditions are recommended:

1. Approved plans, reflecting staff and advisory board recommendations, as approved by the City Council:

- A. Application (WK Building and Development Inc., received 03/23/21)
- B. Elevations (James Byrnes, Architect, dated 08/06/20, received 08/16/20)
- C. Plat of Subdivision (Haeger Engineering, dated 05/20/21, received 05/20/21)

2. Plat of Subdivision document

- A. Insert the school districts certification block on the plat.
- B. Correct the Planning and Zoning Commission signature block.
- C. Provide the amended CCRs reflecting this change for City review and approval before recording.
- D. The sidewalk must be extended to the terminus of Oak Hollow Road with this development.
- E. Provide a parkway tree(s) if feasible, with the two duplexes.
- F. Correct the plat document to include all the required notations (easements, roadway dedication status, etc.), as detailed in Section 5-200G3b Subdivisions of the UDO.
- 3. The petitioner must address all of the review comments and requirements of the Community Development Department.

PIQ Map 700-716 Oak Hollow Road





The following information is related to a development application. As the owner of the property in question, I (we) acknowledge that the information provided in the submittal was reviewed and approved.

Owner Information
Name: WK BUILDING AND DEVELOPMENT INC.
Address: 525 W WISE RD UNIT F
SCHAUMBURG IL 60193
Phone: 847-352-0100
E-mail: WALLY@WKHOMEBUILDERS .COM
Project Name & Description: ASHTON POINT DUPLEXS
CONSTRUCTION OF 4 UNITS IN TWO BUILDINGS
te.
Project Address/Location: 716,712,704,700 OAK HOLLOW RD.
Signature & Son
Owner: Print and Sign name KENNETH S. STRuck Date 3-23-21
NOTE: If the appearance is hold in a trust, the trust officer must sign this potition as owner. In addition, the trust officer

NOTE: If the property is held in a trust, the trust officer must sign this petition as owner. In addition, the trust officer must provide a letter that names all beneficiaries of the trust.

PUBLIC NOTICE BEFORE THE PLANNING AND ZONING COMMISSION OF THE CITY OF CRYSTAL LAKE, MCHENRY COUNTY, ILLINOIS

IN THE MATTER OF THE PETITION OF Ashton Pointe LLC and WK Bldgs Develop Inc.


LEGAL NOTICE Notice is hereby given in compliance with the Unified Development Ordinance of the City of Crystal Lake, Illinois that a public hearing will be held before the Planning and Zoning Commission upon the application by Wally Krawczyk representing WK Bldgs Develop Inc. on behalf of Ashton Pointe LLC for a Final Planned Unit Development Amendment, relating to the property at 704, 708, 712, and 716 Oak Hollow Road in Crystal Lake, Illinois 60014. PINs: 19-04-276-041 and 19-04-276-048.

This application is filed for the purpose of seeking an amendment to an approved Final Planned Unit Development to allow the construction of 2 two-unit townhomes a deviation from the approved 5-unit townhome along with a Preliminary and Final Plat of Subdivision for a two-lot subdivision pursuant to Article 3, Article 4, Article 5 and Article 9. Plans for this project can be viewed at the Crystal Lake Community Development Department at City Hall.

A public hearing before the Planning and Zoning Commission for this request will be held at 7:00 p.m. on Wednesday June 16, 2021, at the Crystal Lake City Hall, 100 West Woodstock Street, at which time and place any person determining to be heard may be present. Jeff Greenman, Chairperson Planning and Zoning Commission City of Crystal Lake

(Published in the Northwest Herald on May 28, 2021) 1889447



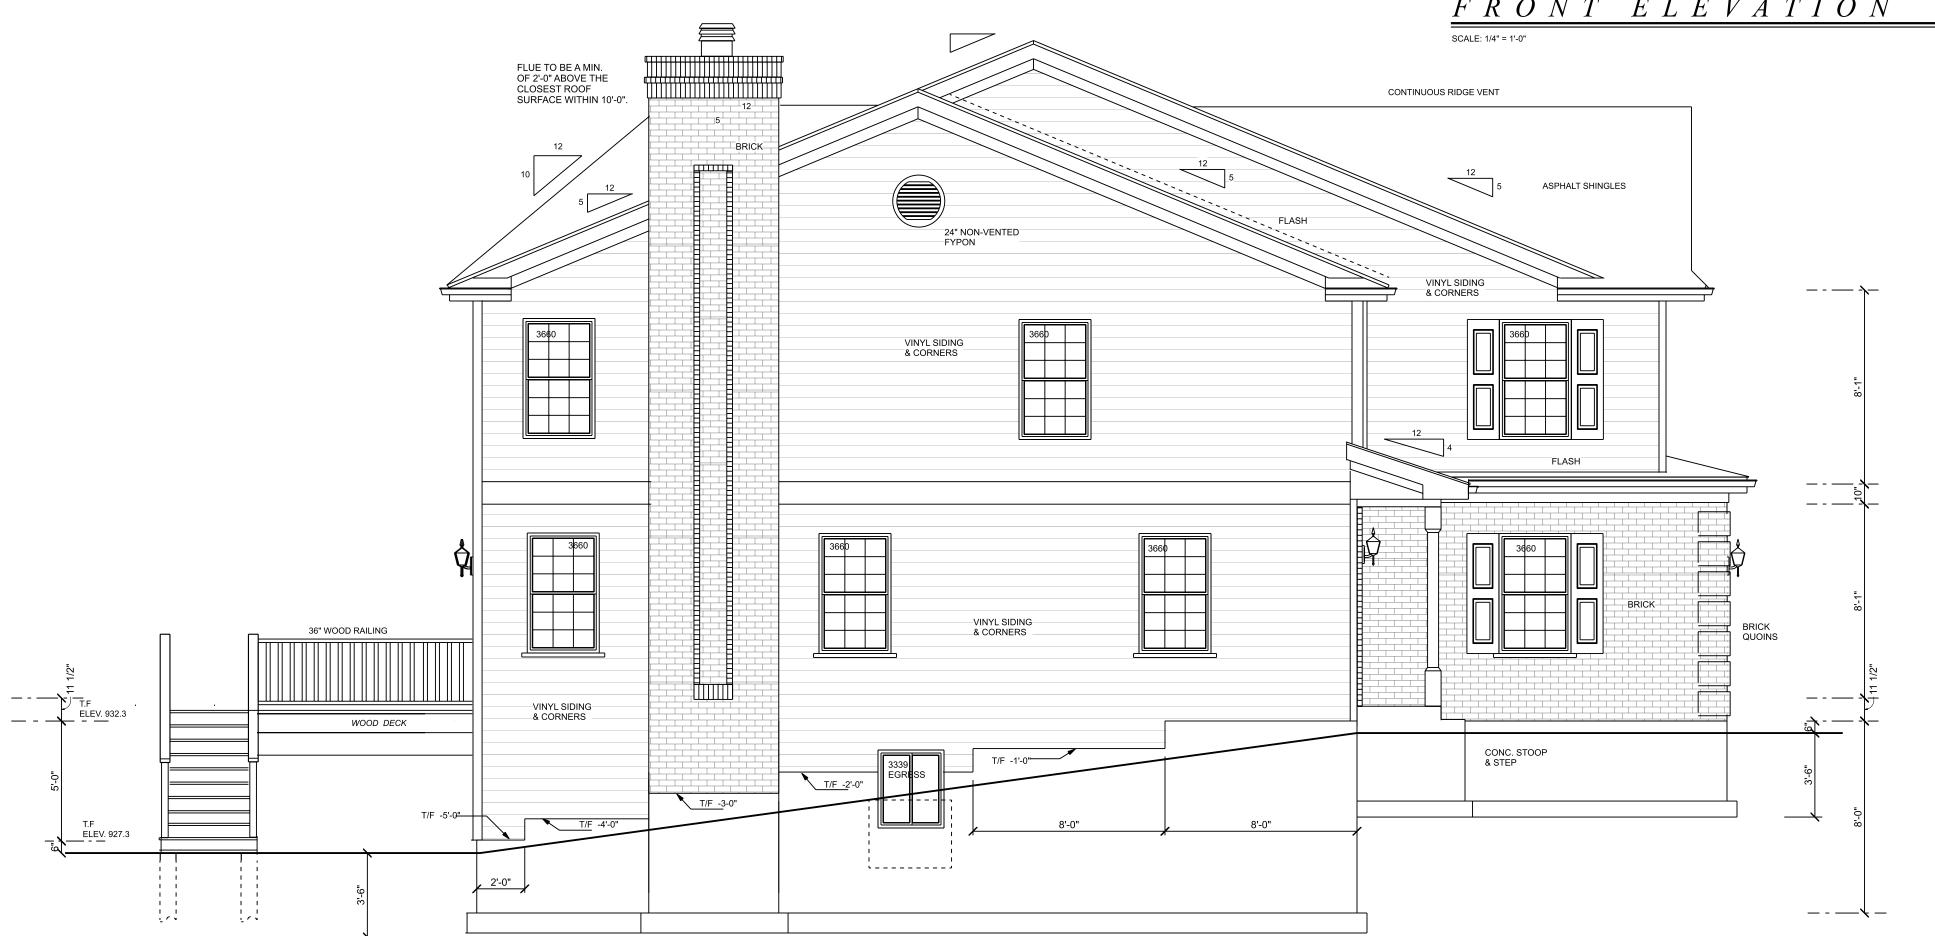

LEFT ELEVATION

SCALE: 1/4" = 1'-0"

City of Crystal Lake, IL. SHEET SCHEDULE **Codes and Ordinances SHEET CONTENTS** NO. FRONT ELEVATION LEFT SIDE ELEVATION 2006 Edition of the International Residential Code 2006 Edition of the International Fire Code


REAR ELEVATION RIGHT SIDE ELEVATIONS 2006 Edition of the International Mechanical Code 2006 Edition of the International Fuel Gas Code FIRST FLOOR PLAN 2006 Edition of the International Property Maintenance Code 2014 Edition of the Illinois Plumbing Code SECOND FLOOR PLAN 2005 Edition of the National Electric Code SEPARATION WALL 2015 Edition of the International Energy Conservation Code FOUNDATION PLAN 1997 Illinois Accessibility Code TYPICAL WALL SECTION 2000 Edition of the NFPA Life Safety Code 6 ELECTRICAL PLANS



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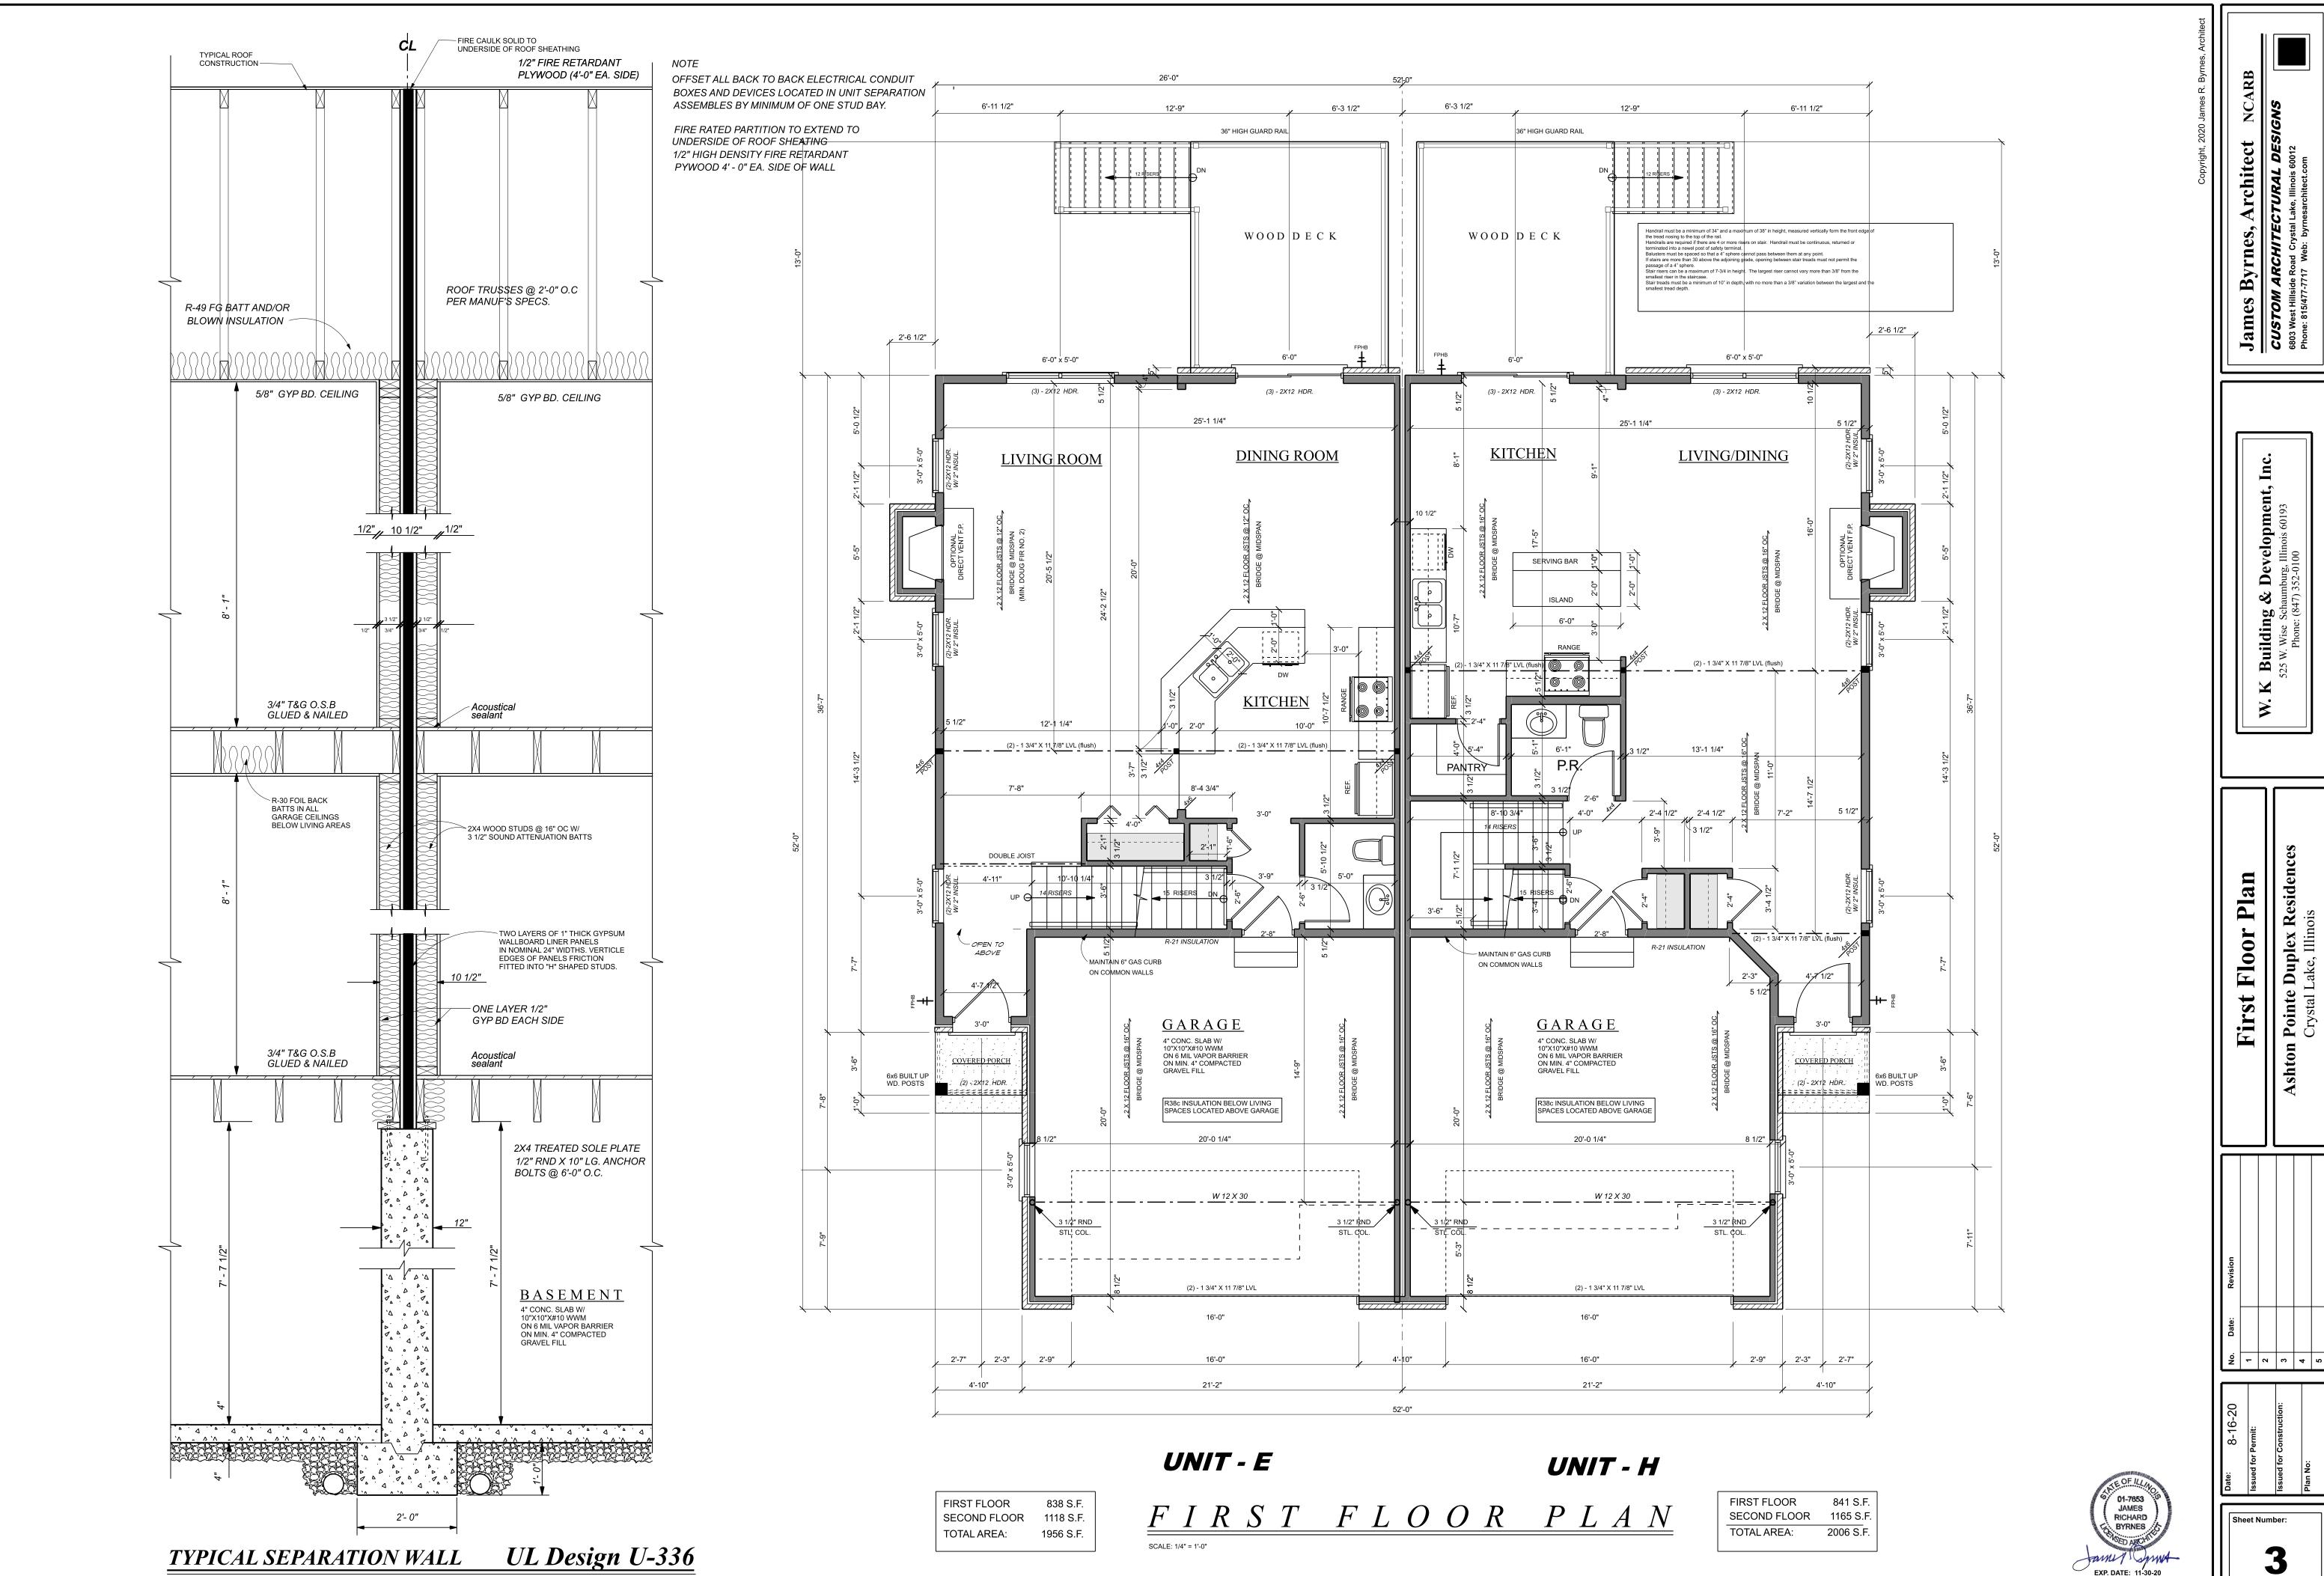
Ashton Pointe Duplex Residences
Crystal Lake, Illinois

Front & Left Elevations

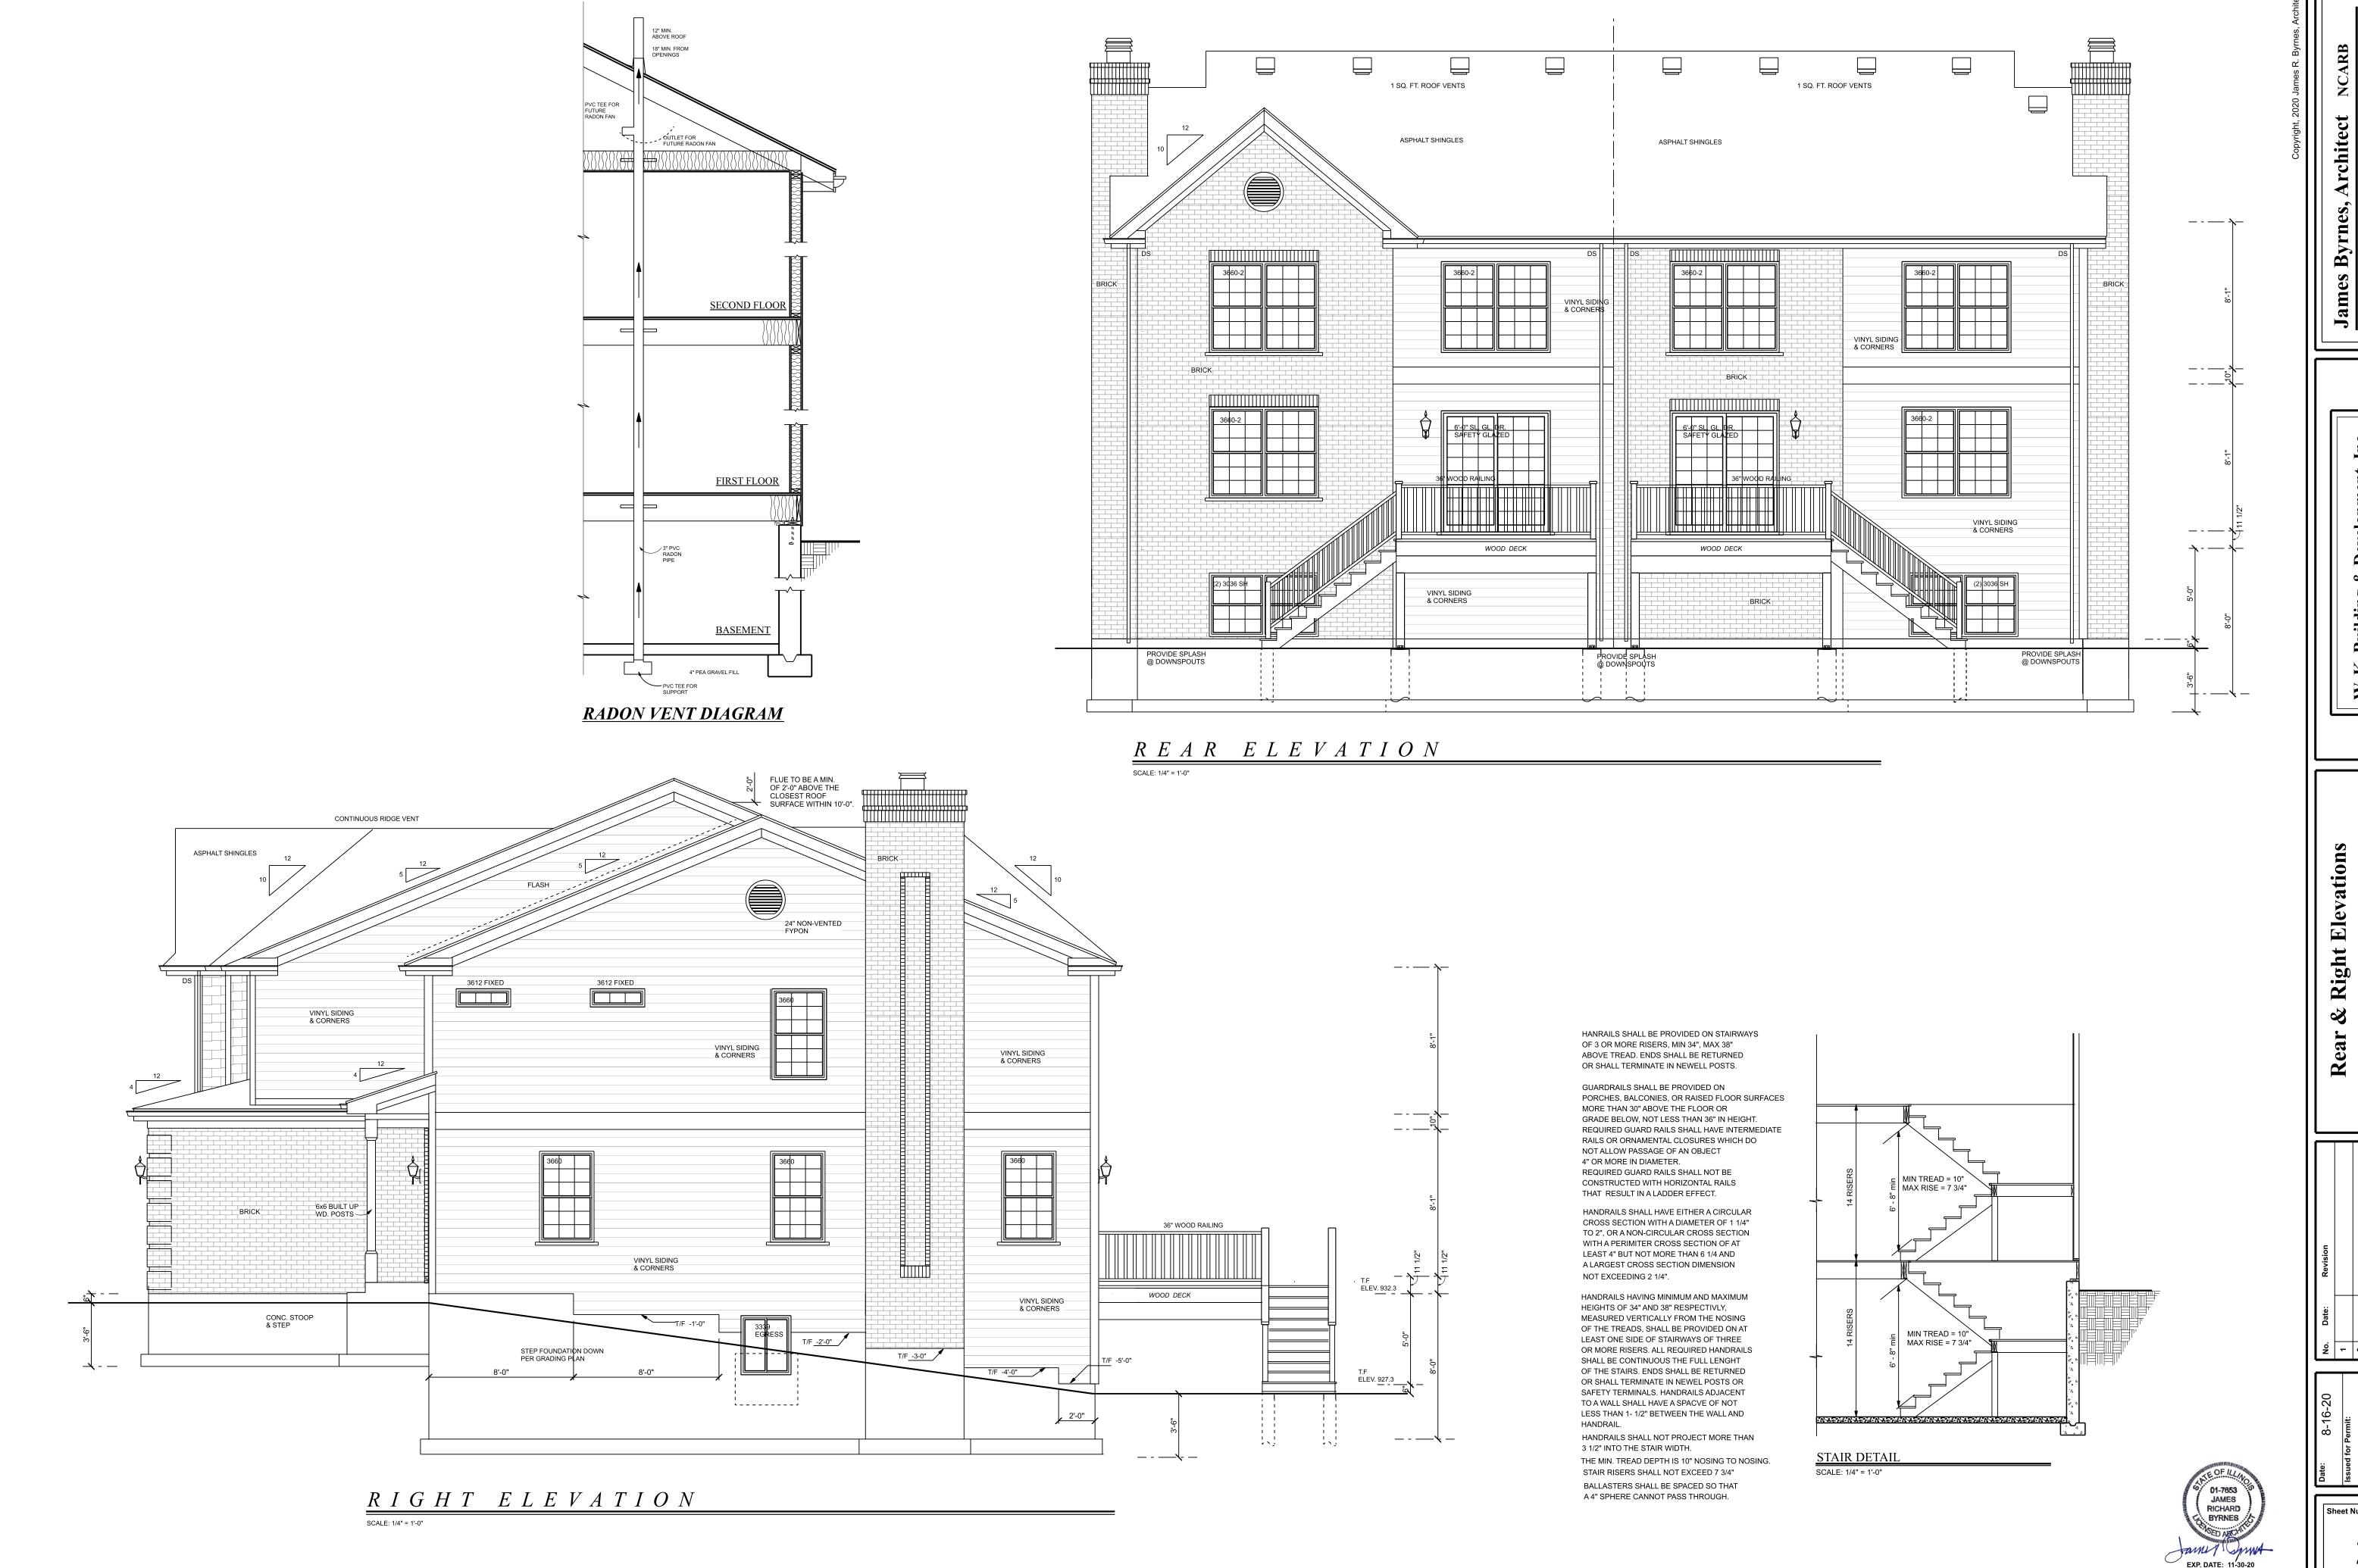

Building 525 W. Wise Sch

Sheet Number:



SCALE: 3/8" = 1'-0"

PLUMBING NOTES:

ALL SUPPLY PIPING TO BE "L COPPER ABOVE GROUND. "K" COOPER BELOW GROUND ALL WASTE & VENT PIPING TO BE P.V.C. SCHEDULE 40 MIN.

PRESURE @ ALL FIXTURES TO BE 40 TO 50 PSI

FLOW RATES FOR ALL FIXTURES TO BE 3.0/GPM MAXIMUM EXEPT WATER CLOSETS TO BE 35/GPM MAXIMUM.

PROVIDE 12" AIR CHAMBERS AND SHUT-OFFS @ ALL FIXTURES

PROVIDE VACUM BREAKER PROTECTION @ ALL FROST PROOF HOSE BIBS

PROVIDE CLEAN-OUTS @ ALL CHANGE OF DIRECTION GREATER THAN 45 @ WASTE PIPING PROVIDE 1/2" DIA. CONDUIT TO STREET-SIDE OF REMOTE WTR METER READER VERIFY LOCATION W/ PUBLIC WORKS.

ALL PLUMBING TO CONFORM TO THE ILLINOIS STATE PLUMBING CODE LATEST EDITION

ALL SUPPLY PIPING TO THE SECOND FLOOR TO HAVE 24" AIR CHAMBER. ALL WATER HEATER TO HAVE TEMPETURE AND PRESSURE RELIEF VALVES.

4" FLOOR DRAIN IN BASEMENT AND EJECTOR PUMPS TO BE VENTED SEPARATELY.

ALL STORM SUMP PIT PUMPS TO BE INSTALLED W/ TOP EDGE MIN 2" ABOVE THE TOP SLAB.

ALL SUMP PIT PUMPS TO HAVE GATE VALVE INSTALLED ON 2" DISCHAGE WASTELINE.

RUBBER CHECK VALVES ARE NOT PERMITED ON SUMP DISCHARGE LINES TEES AND CROSSES NOT PERMITED @ WASTE LINE

HUBLESS PIPE & FITTING NOT PERMITED.

CLEANOUT REQUIRE ON SANITARY SEWER 5' OUTSIDE OF BUILDING.

TYPE "L" COPPER W/ NO LEAD SOLDER REQUIRED ON ABOVE GROUND DOMESTIC WATER.

TYPE "K" REQUIRED ON UNDERGROUND DOMESTIC WATER. PURPLE PRIMER OR STACK TEST IS REQUIRED ON ALL P.V.C. PLUMBING.

25 LB TEST REQUIRED ON GAS PIPING AT TIME OF ROUGH INSPECTION.

75 LB AIR TEST OR WTR. PRESSURE REQD. ON WTR. PIPING AT TIME OF ROUGH INSPECT. MINIMUM SIZE UNDERGROUND SANITARY TO BE 4" IN DIAMETER

ALL WASTE AND WATER PIPING IN OUTSIDE WALLS TO BE PROTECTED FROM FREEZING BASEMENT FLOOR DRAIN TO BE VENTED.

WATER SERVICE FROM MAIN TO BUILDING TO BE INSTALLED BY A LICENSED PLUMBER.


WATER SERVICE AND WATER METER SHALL HAVE 2 SHUT-OFF VALVES: 1 ON HOUSE SIDE OF WATER METER AND 1 ON STREET SIDE


THERE SHALL BE NO MORE THAN 2 WATER CLOSETS ON 3" WASTE LINE.

FLOOR DRAIN CONNECTED TO EJECTOR PUMP IN BASEMENT IS TO BE VENTED

SEPARATELY, 2" MIN VENT REQUIRED.

ALL PLUMBING MUST MEET ILLINOIS STATE CODE & LOCAL VILLAGE ORDINANCES.

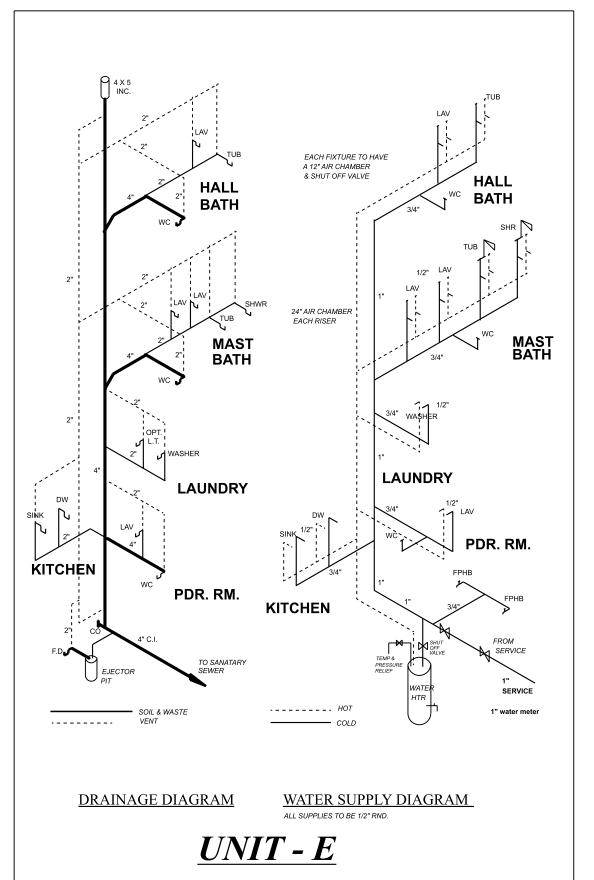

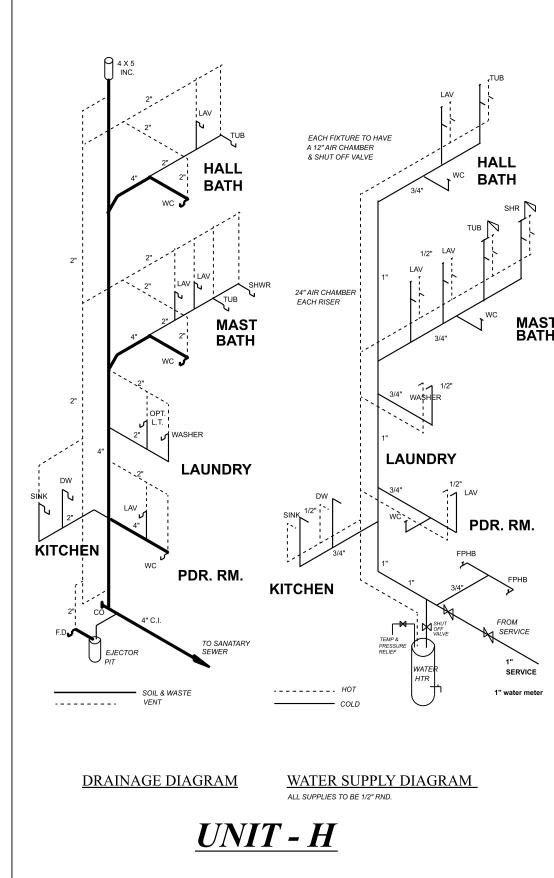


UNIT - E

LIGHT AND VENT SCHEDULE								
ROOM		AREA	LIC	GHT	VE	ENT		
			REQ'D	ACT.	REQ'D	ACT		
LIVING RM		349.5	27.9	69	14	34		
KITCHEN DINING RM		193.5	15.48	46	7.74	20		
MASTER BR		182.3	14.58	30	7.29	15		
BEDROOM #2		150.5	12.04	30	6.02	15		
STUDY		161	12.88	30	6.44	15		
MAST BATH	*	50	NA	NA	NA	75 CFM		
HALL BATH	*	50	NA	NA	NA	75 CFM		
PDR RM.	*	30	NA	NA	NA	50 CFM		
BASEMENT	**	761	27.8	36	13.9	36		
ROOF	***	1420	NA	NA	7.3 SF	7.3 SF		

UNIT - H

ROOM	AREA	LI	GHT	VE	ENT
		REQ'D	ACT.	REQ'D	ACT
LIVING RM DINING RM	427	34.2	54	17.1	27
KITCHEN	183	14.64	46	7.32	20
MASTER BR	217	17.38	30	8.69	15
BEDROOM #2	176.4	14.11	30	7.06	15
BEDROOM #3	181.3	14.5	30	7.06	15
MAST BATH	* 15	NA	NA	NA	75 CFM
HALL BATH	* 38	NA	NA	NA	75 CFM
PDR RM.	* 30	NA	NA	NA	50 CFM
BASEMENT *	* 764	27.8	36	13.9	36

* 5 AC/HR ** 2% *** 1/300

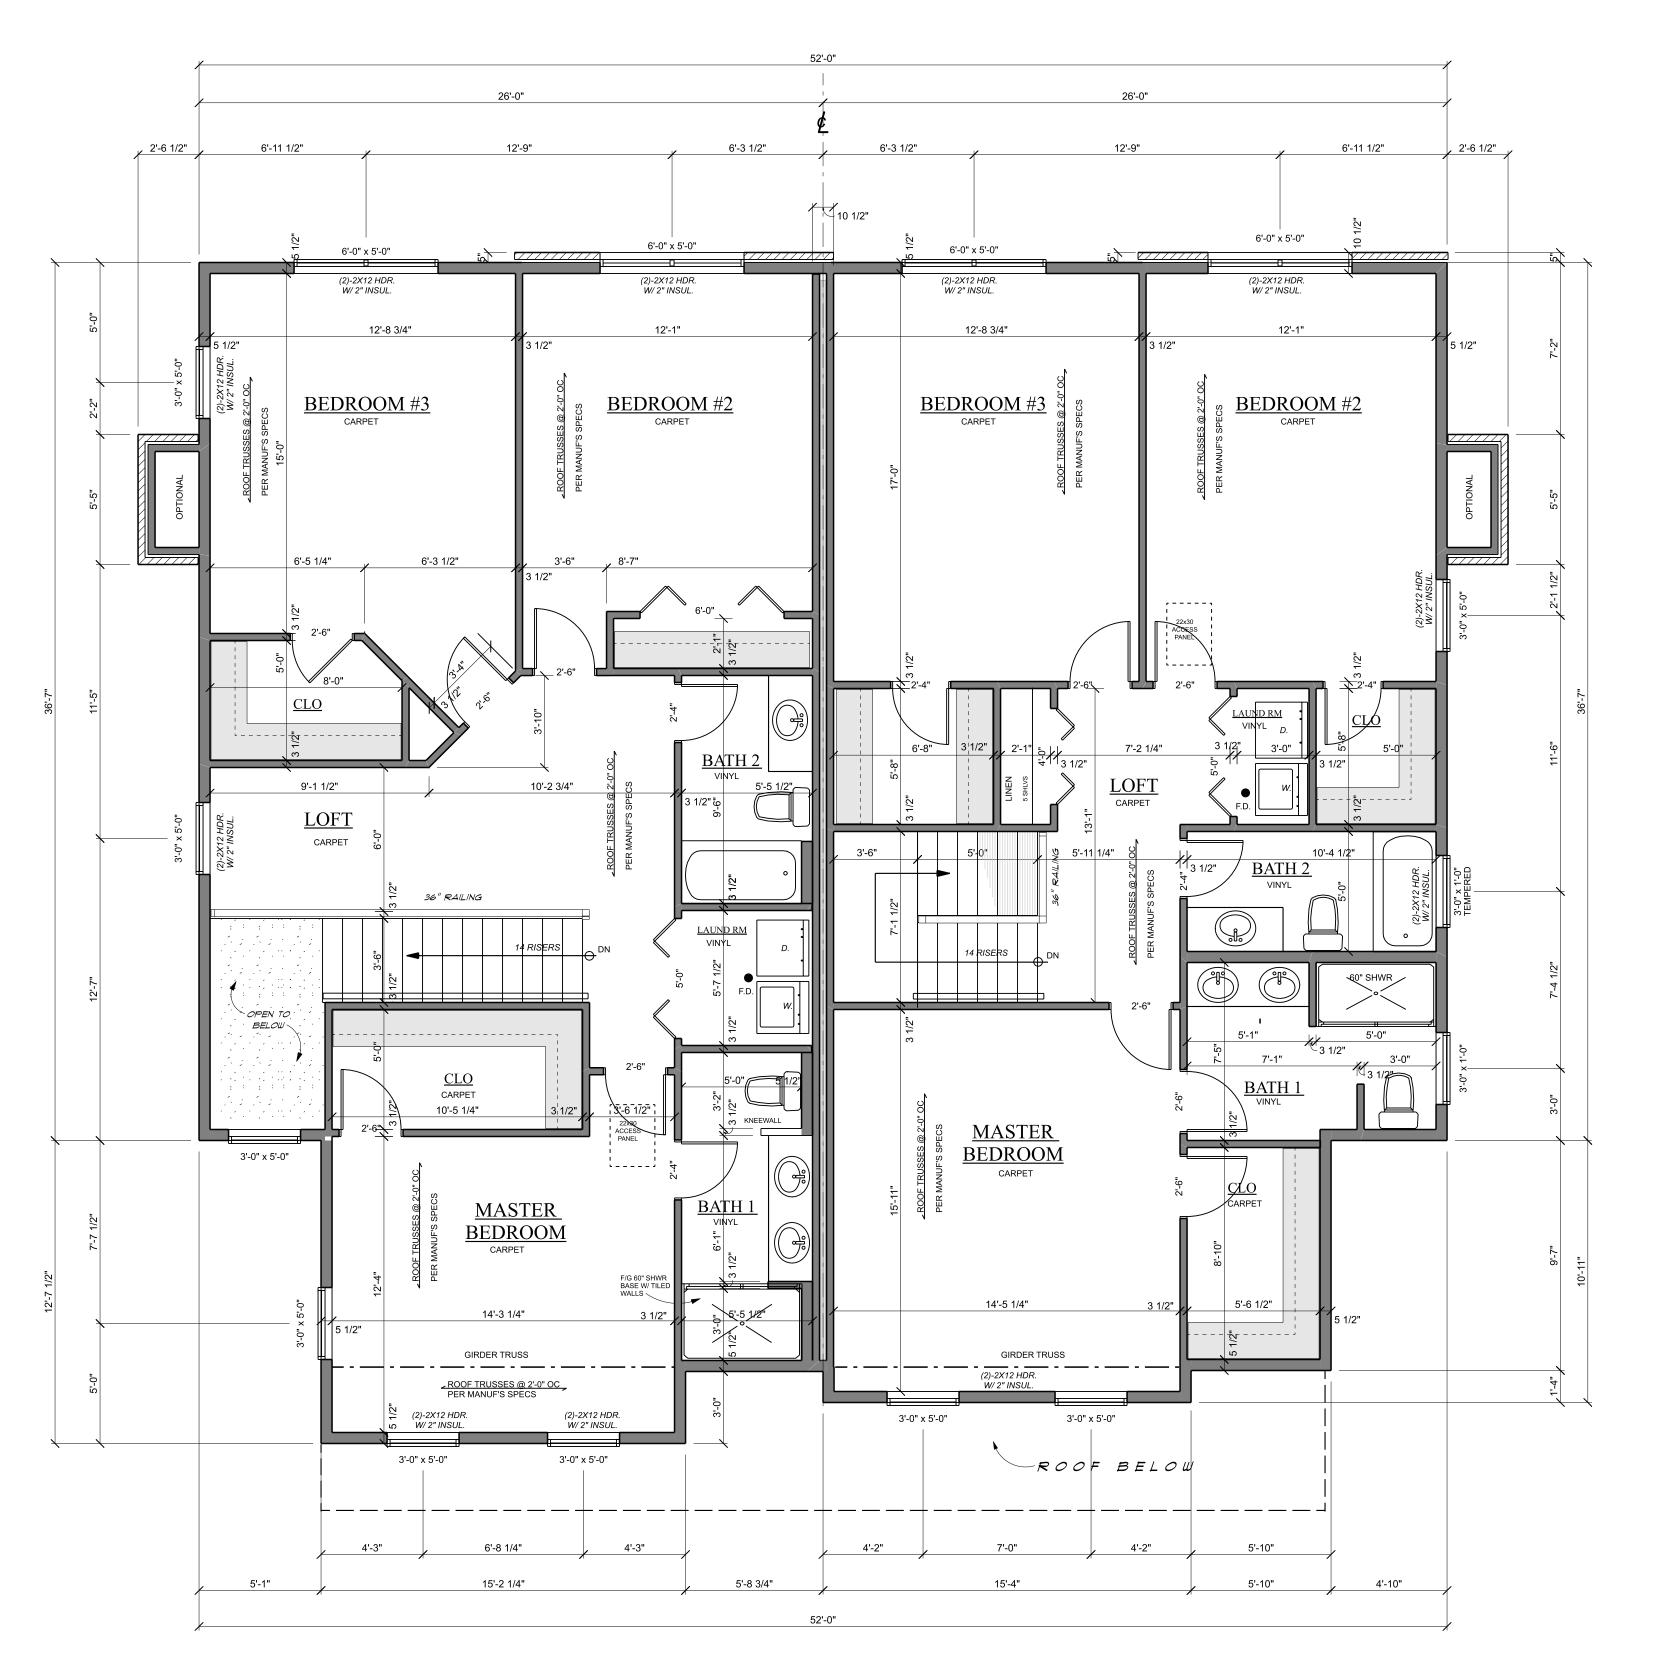

SECOND FLOOR PLAN

UNIT - E

UNIT - H

• Minimum width of opening: 20 in. • Minimum height of opening: 24 in. • Minimum net clear opening: 5.7 sq. ft. (5.0 sq. ft. for ground floor).


• Maximum sill height above floor: 44 in



Sheet Number:

Second Floor Plan


* 5 AC/HR ** 2% *** 1/300

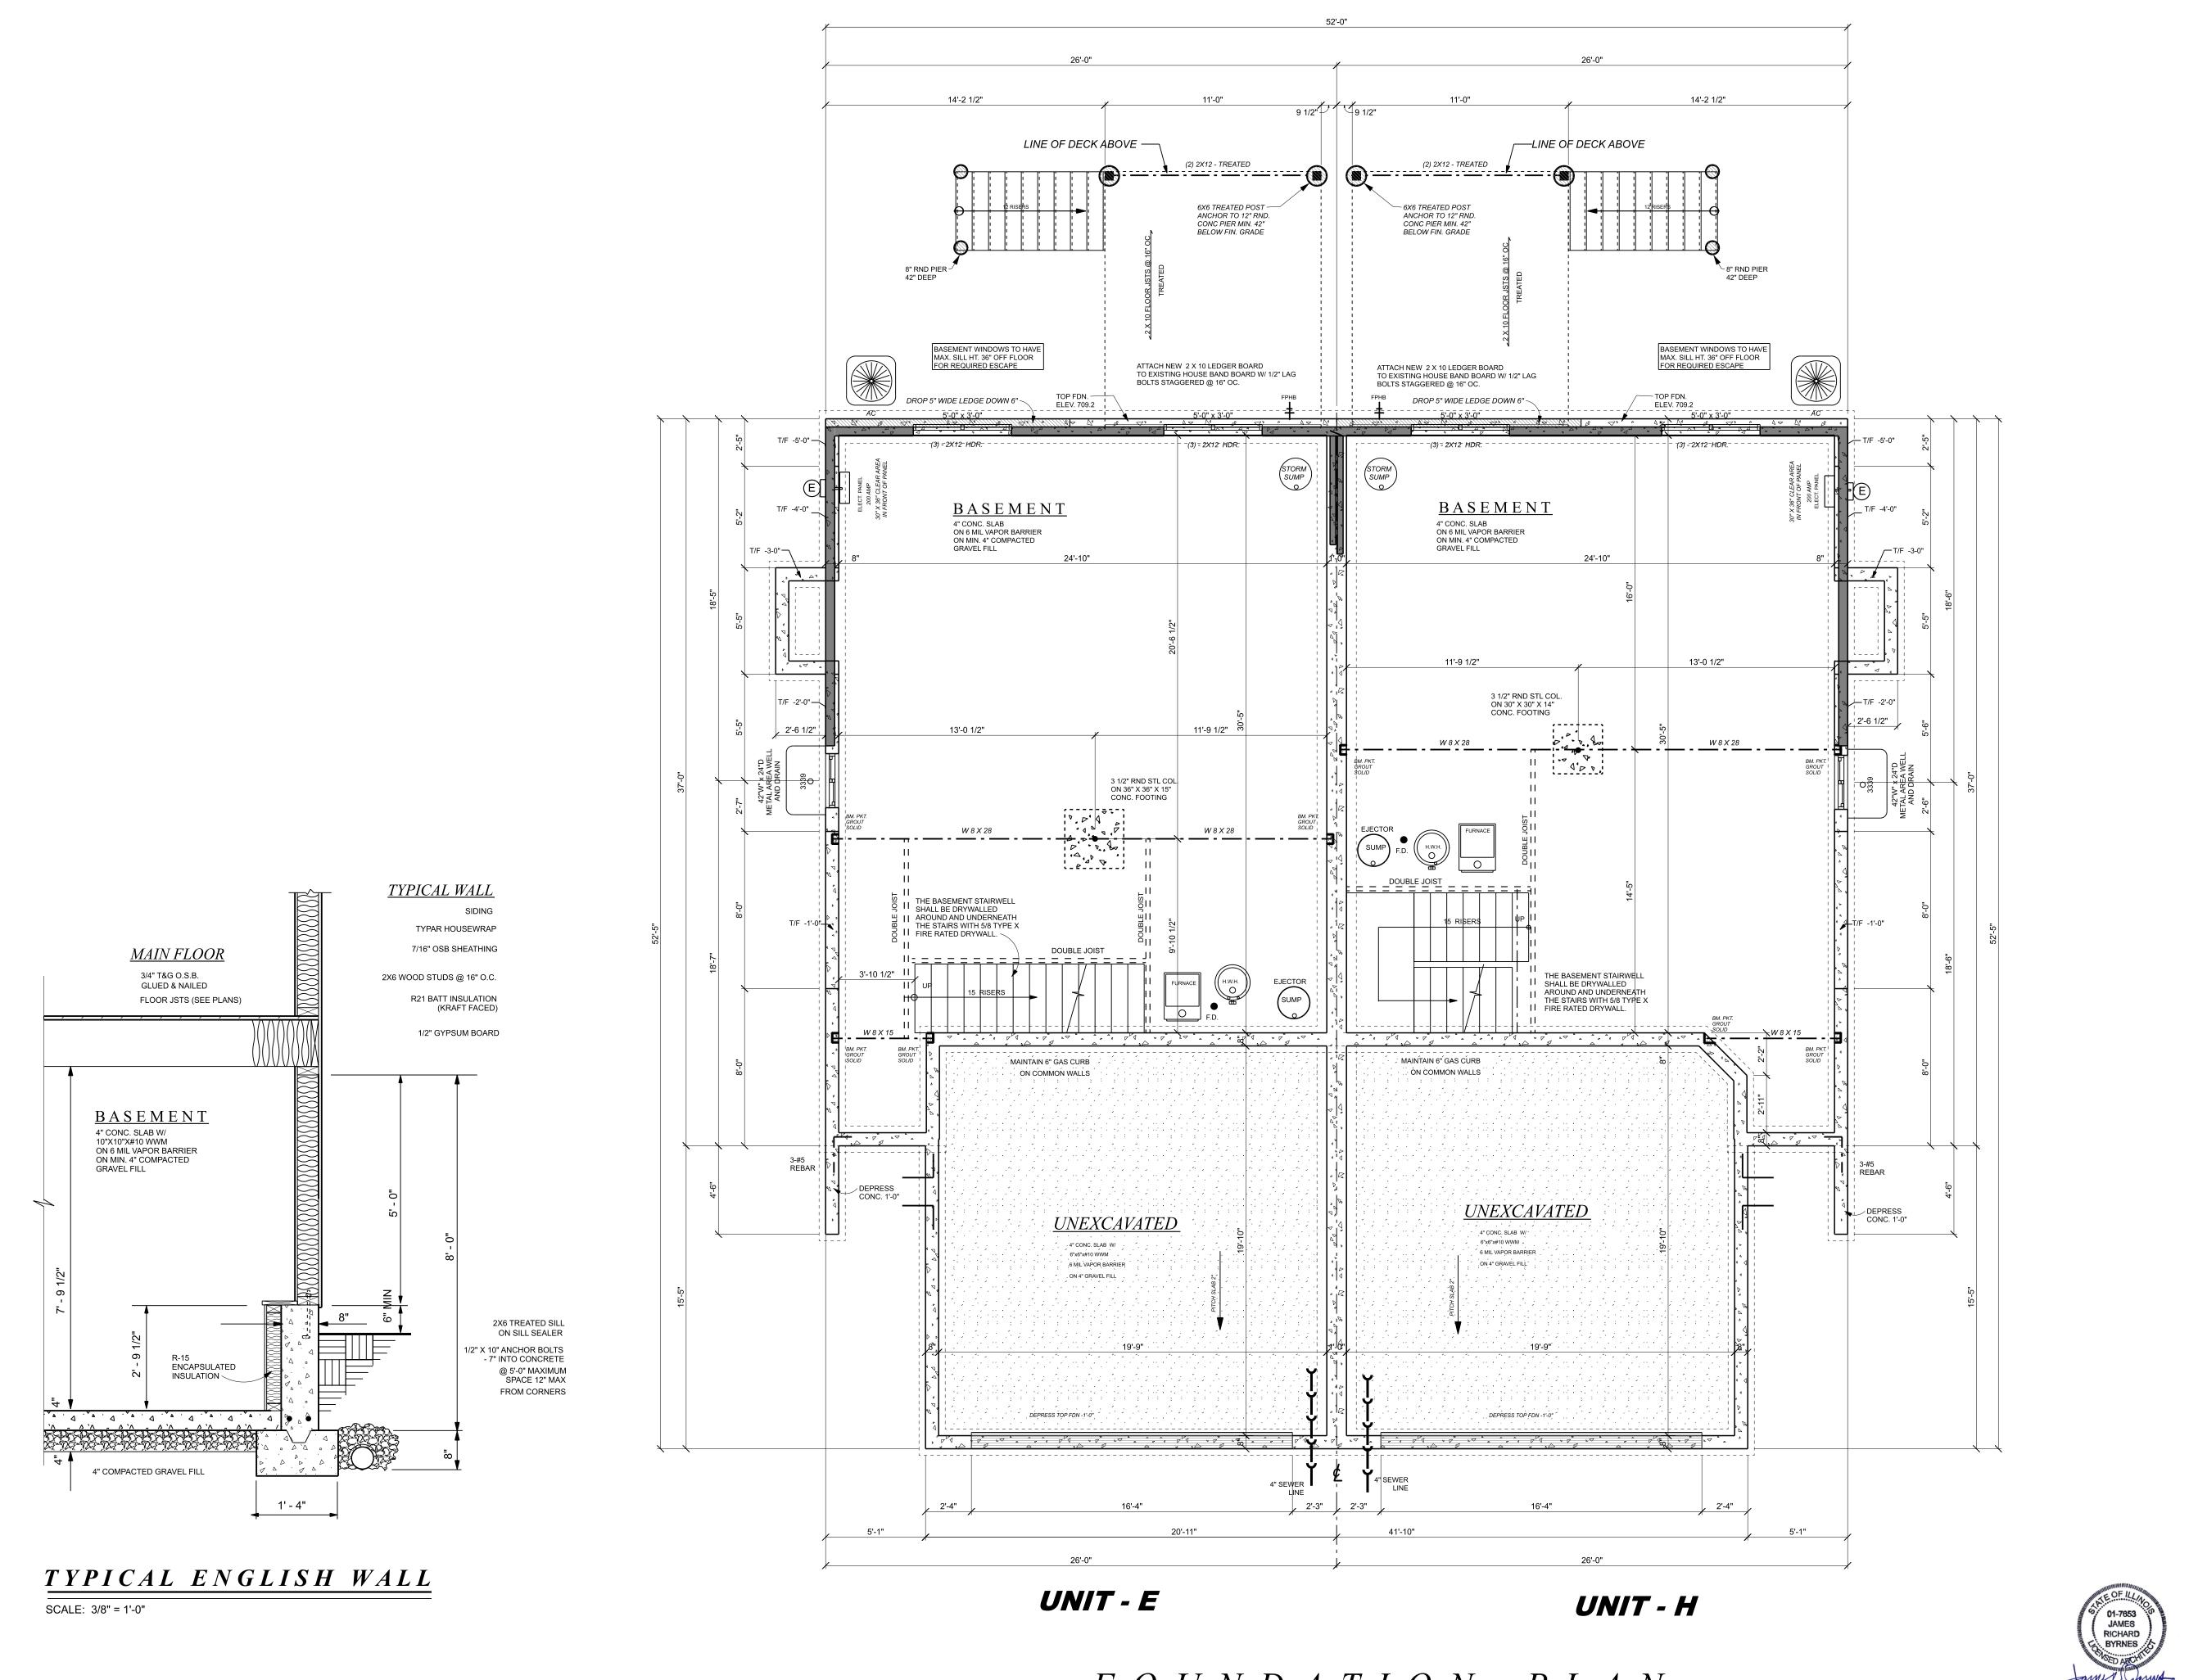

Foundation Plan

Sheet Number:

FOUNDATION PLAN

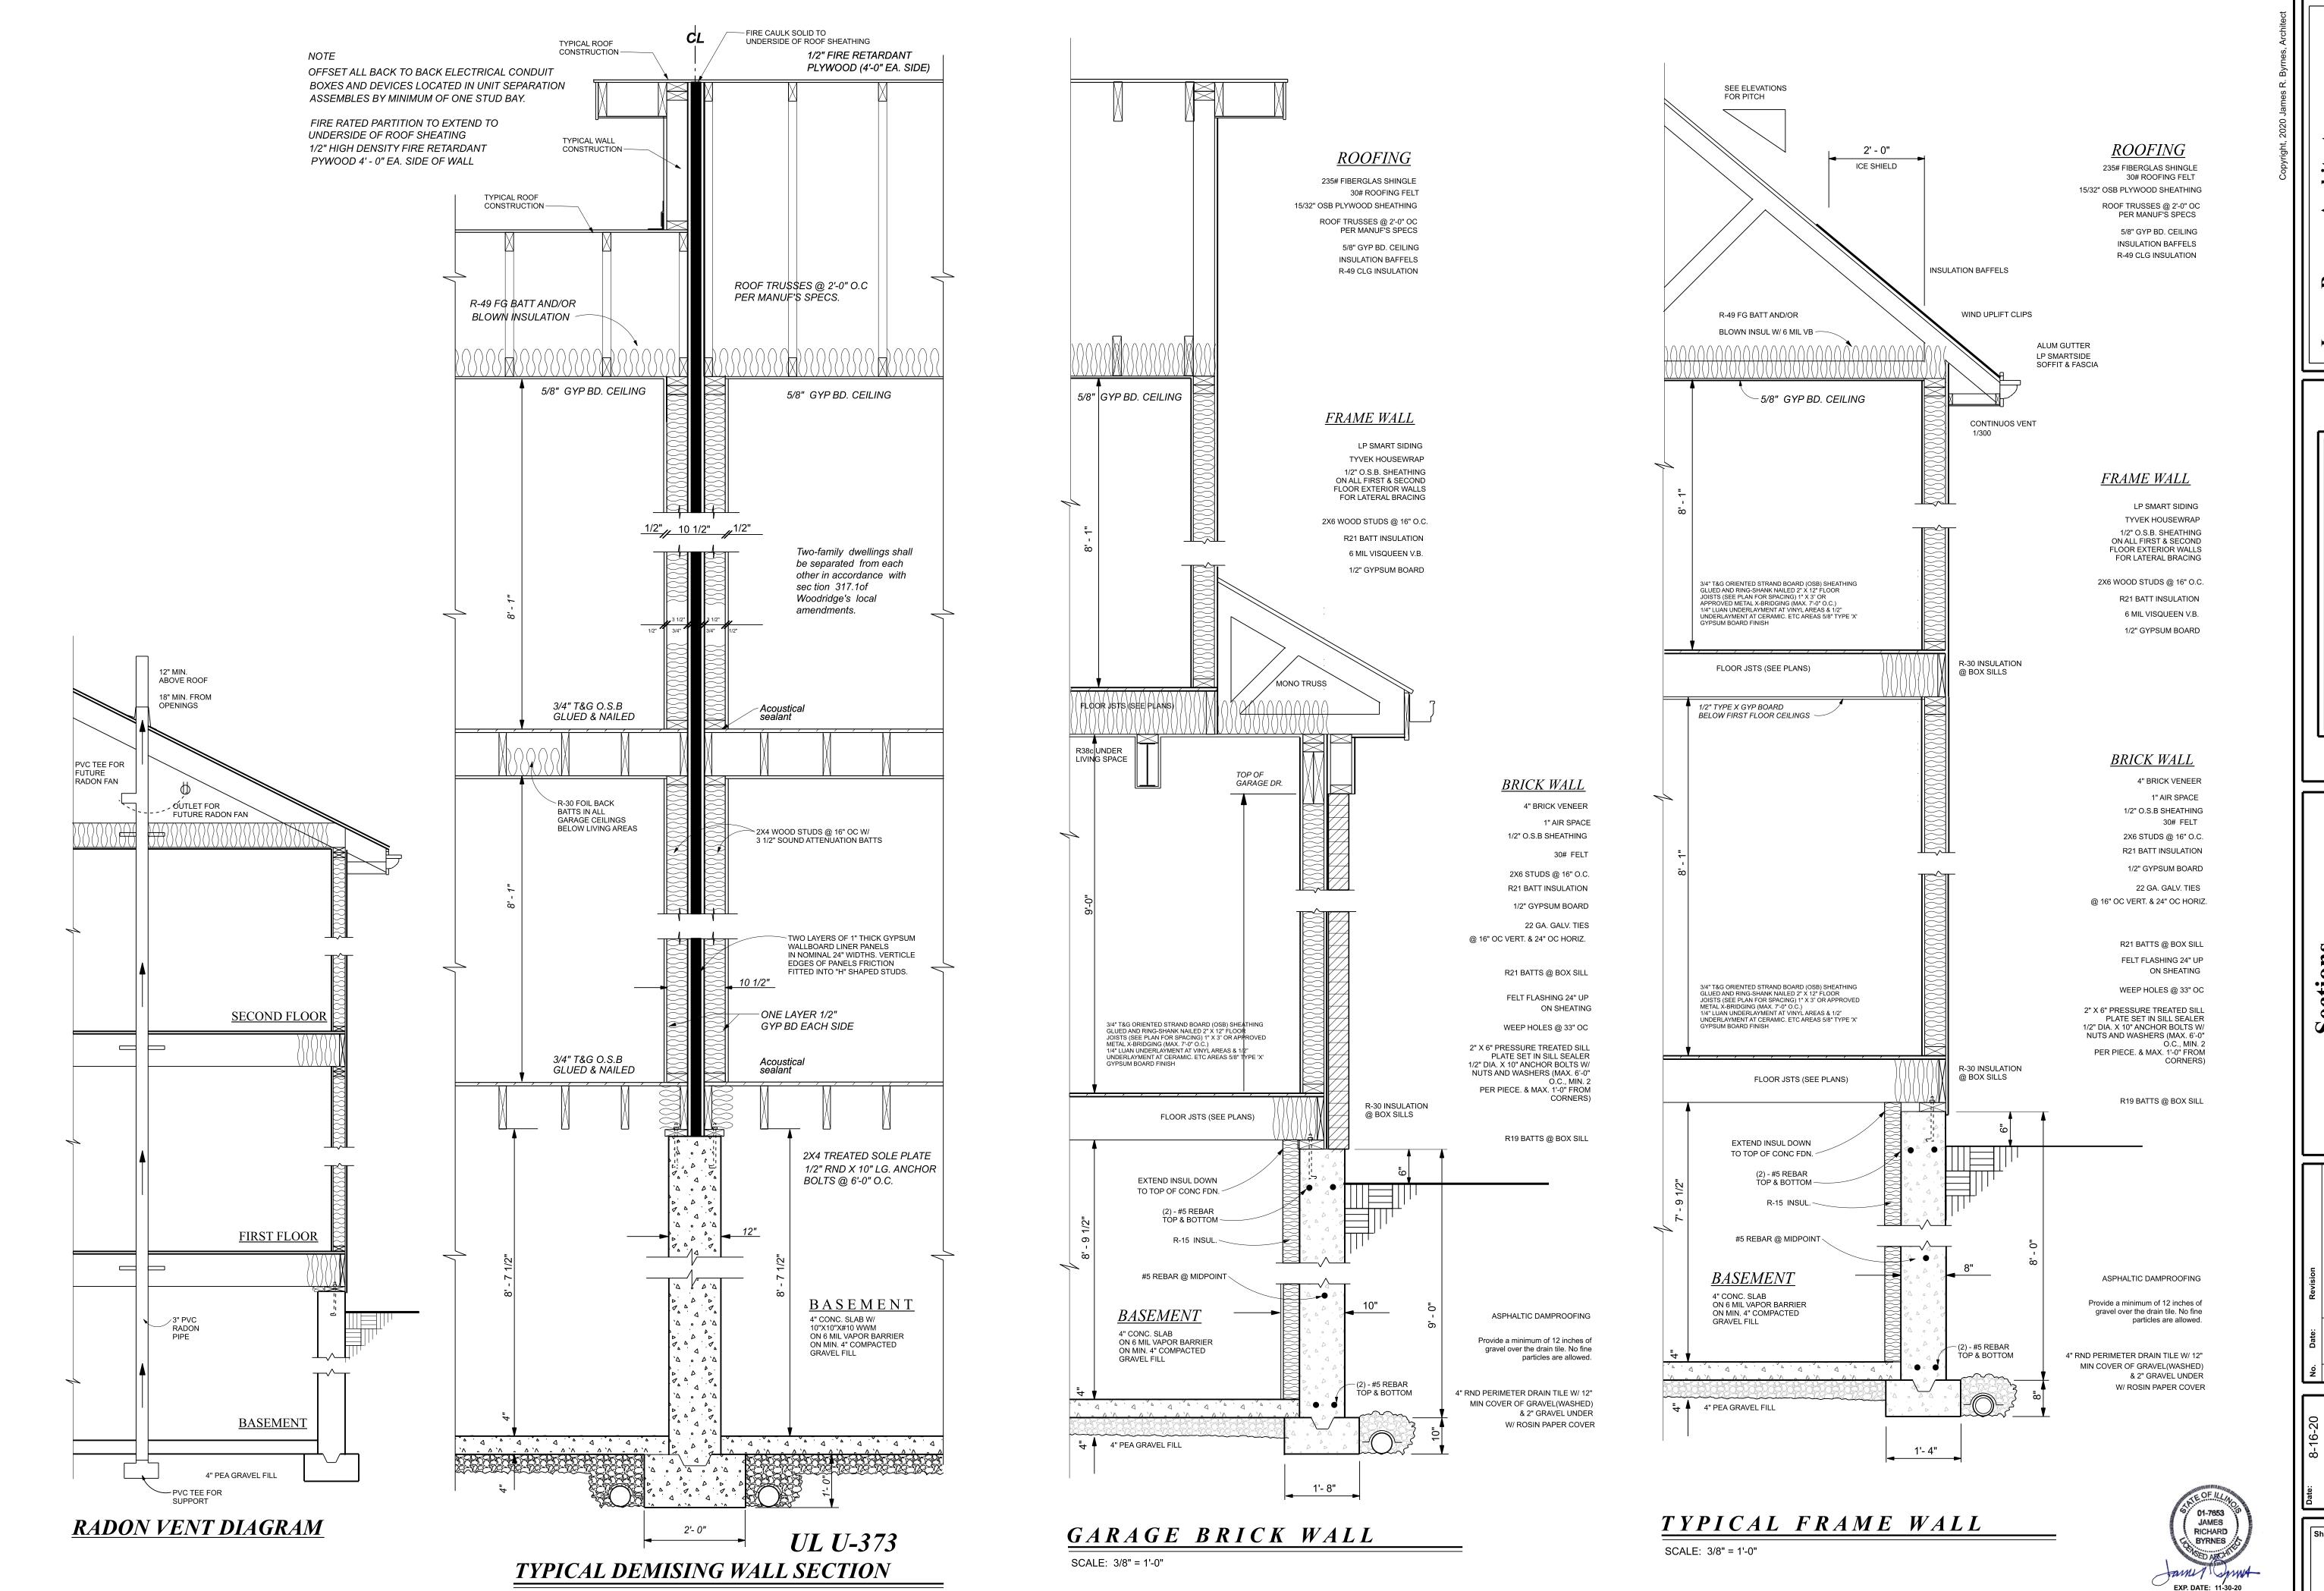

SCALE: 3/8" = 1'-0"

James Byrnes, Architect NCARB

CUSTOM ARCHITECTURAL DESIGNS
6803 West Hillside Road Crystal Lake, Illinois 60012
Phone: 815/477-7717 Web: byrnesarchitect.com

W. K Building & Development, Inc. 525 W. Wise Schaumburg, Illinois 60193
Phone: (847) 352-0100

Sections
Ashton Pointe Duplex Residences
Crystal Lake, Illinois

Date: 8-16-20 No.

Sheet Number:

ст	DEMARKS	LOAD				LOAD		NEW COLUMN CONTROL OF THE PROPERTY OF THE PROP	cc
io.	REMARKS	A	В	AMPS/ POLE	AMPS/ POLE	А	В	REMARKS	NO.
1	BEDROOM 2	1260		15	20 1	3840		A/C	2
3	BATH 1 GFI	n c	180	20 1	20 1		3840	A/C	4
5	BATH 2 GFI	180		20	15 1	1080	C = C = 0	LIVING ROOM	6
7	DISHWASHER		1200	20 1	15 1	ores 3	720	FRONT HALL/POWDER	8
9	DISPOSAL	300	0 8	20 1	15 1	1200		FURNACE	10
11	REFRIGERATOR		1200	15 1	15 1	50	1200	SUMP PUMPS	12
13	KITCHEN RECEPTACLES	1260		20 1	15 1	1200		EJECTOR PUMP	14
15	KITCHEN RECEPTACLES		1260	20 1	15 1		1440	BASEMENT LIGHTS	16
17	POWDER GFI	360	8	20 1	20 1	720		BREAKFAST	18
19	SMOKE/CO DETECTORS		1080	15 1	15 1	d annual	720	UPPER HALL/ATTIC	20
21	LAUNDRY	1200		20 1	20 1		0.0000	SPARE	22
23	GARAGE	as land	360	15 1	20 1				24
25	BEDROOM 1	1260		15 1	20 1	ii i			26
27	BEDROOM 3		1260	15 1	20 1	5			28
29	SPARE			20 1	20 1				30
	TOTAL WATTS & A	5790	, viens			8040		TOTAL WATTS & A	
	TOTAL WATTS & B		6480				7620	TOTAL WATTS & B	
	TOTAL WATTS & C	- 3		- 8		627735		TOTAL WATTS & C	
	SUB TOTAL WATTS			-56			901-0-	SUB TOTAL WATTS	
	TOTAL WATTS		28320	m		- 300	79	TOTAL AMPS	- 20 - 20 - 2


SEEPING AREAS	DESIGN LO	ADS:			
WALLS	FLOOR	= 40# LL 10#	DL	ALL AREAS	EXCEPT SLEEPING
CEILING	FLOOR	= 30# LL 10#	DL	SLEEPING /	AREAS
ROOF = 30# LL 10# DL ROOF SLOPES OVER 3 : 12 CATHEDRAL = 30# LL 15# DL ALL SLOPES ROOF TRUSSES - BOTTOM = 20# LL 10# DL TRUSS BOTTOM CHORD ROOF TRUSSES - TOP = 30# LL 10# DL TRUSS TOP CHORD ROOF SLOPES EXCEEDING 3 : 12 EXT. DECK = 40# LL 10# DL EXTERIOR EXT. DECK = 40# LL 10# DL EXTERIOR FRAMING LUMBER SPECIFICATIONS: FLOOR JOISTS, CEILING JOISTS, HEADERS AND RAFTERS IN-GRADE BASE VALUE AS DETERMINED NY WESTERN WOOD PRODUCTS ASSOCIATION (USE NO MULTIPLIERS AGAINST BASE VALUE). 2x2, 2x4, 2x6 SPRUCE PINE FIR #2 DOMESTIC BASE Fb = 750 2x8, 2x10, 2x12, 2x14, 2x16 LESS THAN 20' IN LENGTH 2x8, 2x10, 2x12, 2x14, 2x16, 2x18 DOUG-FIR #2 DOMESTIC BASE Fb = 875 EXTERIOR LOAD BEARING WALLS E = 1,400,000 FC = 805 EXTERIOR LOAD BEARING WALLS E = 1,200,000 FC = 805 EXTERIOR LOAD BEARING WALLS E = 1,000,000 FC = 600 EXTERIOR LOAD BEARING WALLS E = 1,000,000 FC = 600 EXTERIOR DECK LUMBER SPECIFICATIONS: ALL EXTERIOR DECK FRAMING LUMBER #2 DOMESTIC BASE Fb = 1380 EXTERIOR DECK FRAMING LUMBER #2 DOMESTIC BASE Fb = 1380 EXTERIOR DECK FRAMING LUMBER #2 DOMESTIC BASE Fb = 1380 EXTERIOR DECK FRAMING LUMBER #2 DOMESTIC BASE Fb = 1380 EXTERIOR DECK FRAMING LUMBER #2 DOMESTIC BASE Fb = 1380 EXTERIOR DECK FRAMING LUMBER #2 DOMESTIC BASE Fb = 1210 EXTERIOR DECK FRAMING LUMBER #2 DOMESTIC BASE Fb = 1210 EXTERIOR DECK FRAMING LUMBER #2 DOMESTIC BASE Fb = 1210 EXTERIOR DECK FRAMING LUMBER #2 DOMESTIC BASE Fb = 1210 EXTERIOR DECK FRAMING LUMBER #2 DOMESTIC BASE Fb = 1210 EXTERIOR DECK FRAMING LUMBER #2 DOMESTIC BASE Fb = 1210 EXTERIOR DECK FRAMING LUMBER #2 DOMESTIC BASE Fb = 1210 EXTERIOR DECK FRAMING LUMBER #2 DOMESTIC BASE Fb = 1210 EXTERIOR DECK FRAMING LUMBER #2 DOMESTIC BASE Fb = 1210 EXTERIOR DECK FRAMING LUMBER #2 DOMESTIC BASE Fb = 1210 EXTERIOR DECK FRAMING LUMBER #2 DOMESTIC BASE Fb = 1210	WALLS	= 60 PLF OR AC	TUAL LOAD		
CATHEDRAL	CEILING	= 20# LL 10#	DL	STICK BUIL	T ROOF CONST.
ROOF TRUSSES - BOTTOM = 20# LL 10# DL TRUSS BOTTOM CHORD ROOF TRUSSES - TOP = 30# LL 10# DL TRUSS TOP CHORD ROOF TRUSSES - TOP = 30# LL 10# DL EXT. DECK = 40# LL 10# DL BALCONY = 60# LL 10# DL EXTERIOR FRAMING LUMBER SPECIFICATIONS: FLOOR JOISTS, CEILING JOISTS, HEADERS AND RAFTERS IN-GRADE BASE VALUE AS DETERMINED NY WESTERN WOOD PRODUCTS ASSOCIATION (USE NO MULTIPLIERS AGAINST BASE VALUE). 222, 224, 226 SPRUCE PINE FIR #2 DOMESTIC BASE Fb = 750 228, 2x10, 2x12, 2x14 2x16 HEM-FIR #2 DOMESTIC BASE Fb = 850 LESS THAN 20' IN LENGTH EXEL 2x10, 2x12, 2x14, 2x16, 2x18 DOUG-FIR #2 DOMESTIC BASE Fb = 875 OVER THAN 20' IN LENGTH STUD WALLS - MINIMUM IN-GRADE BASE VALUES: FIRST FLOOR LOAD BEARING: EXTERIOR LOAD BEARING WALLS E = 1,400,000 FC = 805 SECOND FLOOR - LOAD BEARING: EXTERIOR LOAD BEARING WALLS E = 1,200,000 FC = 800 INTERIOR LOAD BEARING WALLS E = 1,000,000 FC = 600 ALL NON-LOAD BEARING WALLS E = 1,000,000 FC = 600 EXTERIOR DECK LUMBER SPECIFICATIONS: ALL EXTERIOR DECK FRAMING LUMBER #2 DOMESTIC BASE Fb = 1380 2 x 8 SYP #2 DOMESTIC BASE Fb = 1380 2 x 10 SYP #2 DOMESTIC BASE Fb = 1210 2 x 12 SYP #2 DOMESTIC BASE Fb = 1120 ENGINEERED WOOD BEAMS:	ROOF	= 30# LL 10#	DL	ROOF SLOP	PES OVER 3 : 12
ROOF TRUSSES - TOP = 30# LL 10# DL TRUSS TOP CHORD ROOF SLOPES EXCEEDING 3 : 12 EXT. DECK = 40# LL 10# DL EXTERIOR BALCONY = 60# LL 10# DL EXTERIOR FRAMING LUMBER SPECIFICATIONS: FLOOR JOISTS, CEILING JOISTS, HEADERS AND RAFTERS IN-GRADE BASE VALUE AS DETERMINED NY WESTERN WOOD PRODUCTS ASSOCIATION (USE NO MULTIPLIERS AGAINST BASE VALUE). 2x2, 2x4, 2x6 SPRUCE PINE FIR #2 DOMESTIC BASE Fb = 750 2x8, 2x10, 2x12, 2x14 2x16 HEM-FIR #2 DOMESTIC BASE Fb = 850 LESS THAN 20' IN LENGTH DOMESTIC BASE Fb = 875 OVER THAN 20' IN LENGTH STUD WALLS - MINIMUM IN-GRADE BASE VALUES: FIRST FLOOR LOAD BEARING: EXTERIOR LOAD BEARING WALLS E = 1,400,000 FC = 805 SECOND FLOOR - LOAD BEARING: EXTERIOR LOAD BEARING WALLS E = 1,200,000 FC = 600 ALL NON-LOAD BEARING WALLS E = 1,000,000 FC = 600 EXTERIOR DECK LUMBER SPECIFICATIONS: ALL EXTERIOR DECK FRAMING LUMBER #2 DOMESTIC BASE Fb = 1380 EXTERIOR DECK FRAMING LUMBER #2 DOMESTIC BASE Fb = 1380 2x8 SYP #2 DOMESTIC BASE Fb = 1380 2x10 SYP #2 DOMESTIC BASE Fb = 1120 ENGINEERED WOOD BEAMS:	CATHEDRAL	= 30# LL 15#	DL	ALL SLOPE	S
EXT. DECK	ROOF TRUSSES - BOTTOM	= 20# LL 10#	DL	TRUSS BOT	FTOM CHORD
### PRODUCTS ASSOCIATION = 60# LL 10# DL	ROOF TRUSSES - TOP	= 30# LL 10#	DL	1	
FRAMING LUMBER SPECIFICATIONS: FLOOR JOISTS, CEILING JOISTS, HEADERS AND RAFTERS IN-GRADE BASE VALUE AS DETERMINED NY WESTERN WOOD PRODUCTS ASSOCIATION (USE NO MULTIPLIERS AGAINST BASE VALUE). 2x2, 2x4, 2x6 SPRUCE PINE FIR #2 DOMESTIC BASE Fb = 750 2x8, 2x10, 2x12, 2x14 2x16 HEM-FIR #2 DOMESTIC BASE Fb = 850 LESS THAN 20' IN LENGTH 2x8, 2x10, 2x12, 2x14, 2x16, 2x18 DOUG-FIR #2 DOMESTIC BASE Fb = 875 OVER THAN 20' IN LENGTH STUD WALLS - MINIMUM IN-GRADE BASE VALUES: FIRST FLOOR LOAD BEARING: EXTERIOR LOAD BEARING WALLS E = 1,400,000 FC = 805 SECOND FLOOR - LOAD BEARING: EXTERIOR LOAD BEARING WALLS E = 1,200,000 FC = 800 INTERIOR LOAD BEARING WALLS E = 1,000,000 FC = 600 ALL NON-LOAD BEARING WALLS E = 1,000,000 FC = 600 EXTERIOR DECK LUMBER SPECIFICATIONS: ALL EXTERIOR DECK LUMBER SPECIFICATIONS: ALL EXTERIOR DECK FRAMING LUMBER #2 SOUTHERN YELLOW PINE (US ORIGIN) E = 1,600,000 2 x 8 SYP #2 DOMESTIC BASE Fb = 1380 2 x 10 SYP #2 DOMESTIC BASE Fb = 1210 2 x 12 SYP #2 DOMESTIC BASE Fb = 1120 ENGINEERED WOOD BEAMS:	EXT. DECK	= 40# LL 10#	DL		
FLOOR JOISTS, CEILING JOISTS, HEADERS AND RAFTERS IN-GRADE BASE VALUE AS DETERMINED NY WESTERN WOOD PRODUCTS ASSOCIATION (USE NO MULTIPLIERS AGAINST BASE VALUE). 2x2, 2x4, 2x6 SPRUCE PINE FIR #2 DOMESTIC BASE Fb = 750 2x8, 2x10, 2x12, 2x14 2x16 HEM-FIR #2 DOMESTIC BASE Fb = 850 LESS THAN 20' IN LENGTH 2x8, 2x10, 2x12, 2x14, 2x16, 2x18 DOUG-FIR #2 DOMESTIC BASE Fb = 875 OVER THAN 20' IN LENGTH STUD WALLS - MINIMUM IN-GRADE BASE VALUES: FIRST FLOOR LOAD BEARING: EXTERIOR LOAD BEARING WALLS E = 1,400,000 FC = 825 INTERIOR LOAD BEARING WALLS E = 1,200,000 FC = 805 SECOND FLOOR - LOAD BEARING: EXTERIOR LOAD BEARING WALLS E = 1,000,000 FC = 600 ALL NON-LOAD BEARING WALLS E = 1,000,000 FC = 600 EXTERIOR DECK LUMBER SPECIFICATIONS: ALL EXTERIOR DECK FRAMING LUMBER #2 SOUTHERN YELLOW PINE (US ORIGIN) E = 1,600,000 2 x 8 SYP #2 DOMESTIC BASE Fb = 1380 2 x 10 SYP #2 DOMESTIC BASE Fb = 1210 2 x 12 SYP #2 DOMESTIC BASE Fb = 1210 ENGINEERED WOOD BEAMS:	BALCONY	= 60# LL 10#	DL	EXTERIOR	
FLOOR JOISTS, CEILING JOISTS, HEADERS AND RAFTERS IN-GRADE BASE VALUE AS DETERMINED NY WESTERN WOOD PRODUCTS ASSOCIATION (USE NO MULTIPLIERS AGAINST BASE VALUE). 2x2, 2x4, 2x6 SPRUCE PINE FIR #2 DOMESTIC BASE Fb = 750 2x8, 2x10, 2x12, 2x14 2x16 HEM-FIR #2 DOMESTIC BASE Fb = 850 LESS THAN 20' IN LENGTH 2x8, 2x10, 2x12, 2x14, 2x16, 2x18 DOUG-FIR #2 DOMESTIC BASE Fb = 875 OVER THAN 20' IN LENGTH STUD WALLS - MINIMUM IN-GRADE BASE VALUES: FIRST FLOOR LOAD BEARING: EXTERIOR LOAD BEARING WALLS E = 1,400,000 FC = 825 INTERIOR LOAD BEARING WALLS E = 1,200,000 FC = 805 SECOND FLOOR - LOAD BEARING: EXTERIOR LOAD BEARING WALLS E = 1,000,000 FC = 600 ALL NON-LOAD BEARING WALLS E = 1,000,000 FC = 600 EXTERIOR DECK LUMBER SPECIFICATIONS: ALL EXTERIOR DECK FRAMING LUMBER #2 SOUTHERN YELLOW PINE (US ORIGIN) E = 1,600,000 2 x 8 SYP #2 DOMESTIC BASE Fb = 1380 2 x 10 SYP #2 DOMESTIC BASE Fb = 1210 ENGINEERED WOOD BEAMS:					
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LESS THAN 20' IN LENGTH 2x8, 2x10, 2x12, 2x14, 2x16, 2x18 DOUG-FIR #2 DOMESTIC BASE Fb = 875 OVER THAN 20' IN LENGTH STUD WALLS - MINIMUM IN-GRADE BASE VALUES: FIRST FLOOR LOAD BEARING: EXTERIOR LOAD BEARING WALLS E = 1,400,000 FC = 825 INTERIOR LOAD BEARING WALLS E = 1,200,000 FC = 805 SECOND FLOOR - LOAD BEARING: EXTERIOR LOAD BEARING WALLS E = 1,000,000 FC = 800 INTERIOR LOAD BEARING WALLS E = 1,000,000 FC = 600 ALL NON-LOAD BEARING WALLS E = 1,000,000 FC = 600 EXTERIOR DECK LUMBER SPECIFICATIONS: ALL EXTERIOR DECK FRAMING LUMBER #2 SOUTHERN YELLOW PINE (US ORIGIN) E = 1,600,000 2 x 8 SYP #2 DOMESTIC BASE Fb = 1380 2 x 10 SYP #2 DOMESTIC BASE Fb = 1210 ENGINEERED WOOD BEAMS:	2x2, 2x4, 2x6	SPRUCE P	INE FIR #2	DOMESTIC	BASE Fb = 750
STUD WALLS - MINIMUM IN-GRADE BASE VALUES: FIRST FLOOR LOAD BEARING: EXTERIOR LOAD BEARING WALLS		HEM-FIR	#2	DOMESTIC	BASE Fb = 850
FIRST FLOOR LOAD BEARING: EXTERIOR LOAD BEARING WALLS E = 1,400,000 FC = 825 INTERIOR LOAD BEARING WALLS E = 1,200,000 FC = 805 SECOND FLOOR - LOAD BEARING: EXTERIOR LOAD BEARING WALLS E = 1,200,000 FC = 800 INTERIOR LOAD BEARING WALLS E = 1,000,000 FC = 600 ALL NON-LOAD BEARING WALLS = 1,000,000 FC = 600 EXTERIOR DECK LUMBER SPECIFICATIONS: ALL EXTERIOR DECK FRAMING LUMBER #2 SOUTHERN YELLOW PINE (US ORIGIN) E = 1,600,000 2 x 8 SYP #2 DOMESTIC BASE Fb = 1380 2 x 10 SYP #2 DOMESTIC BASE Fb = 1210 2 x 12 SYP #2 DOMESTIC BASE Fb = 1120 ENGINEERED WOOD BEAMS:	OVER THAN 20' IN LENGTH				
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INTERIOR LOAD BEARING WALLS E = 1,200,000 FC = 805 SECOND FLOOR - LOAD BEARING: EXTERIOR LOAD BEARING WALLS E = 1,200,000 FC = 800 INTERIOR LOAD BEARING WALLS E = 1,000,000 FC = 600 ALL NON-LOAD BEARING WALLS = 1,000,000 FC = 600 EXTERIOR DECK LUMBER SPECIFICATIONS: ALL EXTERIOR DECK FRAMING LUMBER #2 SOUTHERN YELLOW PINE (US ORIGIN) E = 1,600,000 2 × 8 SYP #2 DOMESTIC BASE Fb = 1380 2 × 10 SYP #2 DOMESTIC BASE Fb = 1210 2 × 12 SYP #2 DOMESTIC BASE Fb = 1120 ENGINEERED WOOD BEAMS:	FIRST FLOOR LOAD BI	EARING:			
SECOND FLOOR - LOAD BEARING: EXTERIOR LOAD BEARING WALLS	EXTERIOR LOAD BEARING V	VALLS E =	1,400,000		FC = 825
EXTERIOR LOAD BEARING WALLS E = 1,200,000 FC = 800 INTERIOR LOAD BEARING WALLS E = 1,000,000 FC = 600 ALL NON-LOAD BEARING WALES = 1,000,000 FC = 600 EXTERIOR DECK LUMBER SPECIFICATIONS: ALL EXTERIOR DECK FRAMING LUMBER #2 SOUTHERN YELLOW PINE (US ORIGIN) E = 1,600,000 2 × 8 SYP #2 DOMESTIC BASE Fb = 1380 2 × 10 SYP #2 DOMESTIC BASE Fb = 1210 2 × 12 SYP #2 DOMESTIC BASE Fb = 1120 ENGINEERED WOOD BEAMS:	INTERIOR LOAD BEARING W	ALLS E =	1,200,000		FC = 805
INTERIOR LOAD BEARING WALLS E = 1,000,000 FC = 600 ALL NON-LOAD BEARING WALLS = 1,000,000 FC = 600 EXTERIOR DECK LUMBER SPECIFICATIONS: ALL EXTERIOR DECK FRAMING LUMBER #2 SOUTHERN YELLOW PINE (US ORIGIN) E = 1,600,000 2 × 8 SYP #2 DOMESTIC BASE Fb = 1380 2 × 10 SYP #2 DOMESTIC BASE Fb = 1210 2 × 12 SYP #2 DOMESTIC BASE Fb = 1120 ENGINEERED WOOD BEAMS:	SECOND FLOOR - LOA	D BEARING:			
ALL NON-LOAD BEARING WALES = 1,000,000 EXTERIOR DECK LUMBER SPECIFICATIONS: ALL EXTERIOR DECK FRAMING LUMBER #2 SOUTHERN YELLOW PINE (US ORIGIN) E = 1,600,000 2 x 8 SYP #2 DOMESTIC BASE Fb = 1380 2 x 10 SYP #2 DOMESTIC BASE Fb = 1210 2 x 12 SYP #2 DOMESTIC BASE Fb = 1120 ENGINEERED WOOD BEAMS:	EXTERIOR LOAD BEARING V	VALLS E =	1,200,000		FC = 800
EXTERIOR DECK LUMBER SPECIFICATIONS: ALL EXTERIOR DECK FRAMING LUMBER #2 SOUTHERN YELLOW PINE (US ORIGIN) E = 1,600,000 2 x 8 SYP #2 DOMESTIC BASE Fb = 1380 2 x 10 SYP #2 DOMESTIC BASE Fb = 1210 2 x 12 SYP #2 DOMESTIC BASE Fb = 1120 ENGINEERED WOOD BEAMS:	INTERIOR LOAD BEARING W	ALLS E =	1,000,000		FC = 600
ALL EXTERIOR DECK FRAMING LUMBER #2 SOUTHERN YELLOW PINE (US ORIGIN) E = 1,600,000 2 x 8 SYP #2 DOMESTIC BASE Fb = 1380 2 x 10 SYP #2 DOMESTIC BASE Fb = 1210 2 x 12 SYP #2 DOMESTIC BASE Fb = 1120 ENGINEERED WOOD BEAMS:	ALL NON-LOAD BEAR	ING WALIES =	1,000,000		FC = 600
#2 SOUTHERN YELLOW PINE (US ORIGIN) E = 1,600,000 2 x 8 SYP #2 DOMESTIC BASE Fb = 1380 2 x 10 SYP #2 DOMESTIC BASE Fb = 1210 2 x 12 SYP #2 DOMESTIC BASE Fb = 1120 ENGINEERED WOOD BEAMS:	EXTERIOR DEC	K LUMBE	R SPEC	CIFICAT	IONS:
2 x 10 SYP #2 DOMESTIC BASE Fb = 1210 2 x 12 SYP #2 DOMESTIC BASE Fb = 1120 ENGINEERED WOOD BEAMS:			E = 1,600,00	00	
2 x 12 SYP #2 DOMESTIC BASE Fb = 1120 ENGINEERED WOOD BEAMS:	2 x 8	SYP #2		DOMESTIC	BASE Fb = 1380
ENGINEERED WOOD BEAMS:	2 x 10	SYP #2		DOMESTIC	BASE Fb = 1210
	2 x 12	SYP #2		DOMESTIC	BASE Fb = 1120
MUNUFACTURER: TRUSS JOIST MCMILLAN	- X 1-				
		OOD BEA	MS:		
2.0 PARALLAM PSL Fb = 2900 psi E = 2,000,000 psi	ENGINEERED W			osi	E = 1,900,000 psi

Fb = 2250 psi E = 1,500,000 psi


1.5 TIMBERSTRAND LSL

TRUSS BEARING NOTE:


BUILDER SHALL SUPPLY ARCHITECT WITH ENGINEERED TRUSS LAYOUTS FOR VARIFICATION OF ACCEPTABLE BEARING POINTS AND BEAMS.

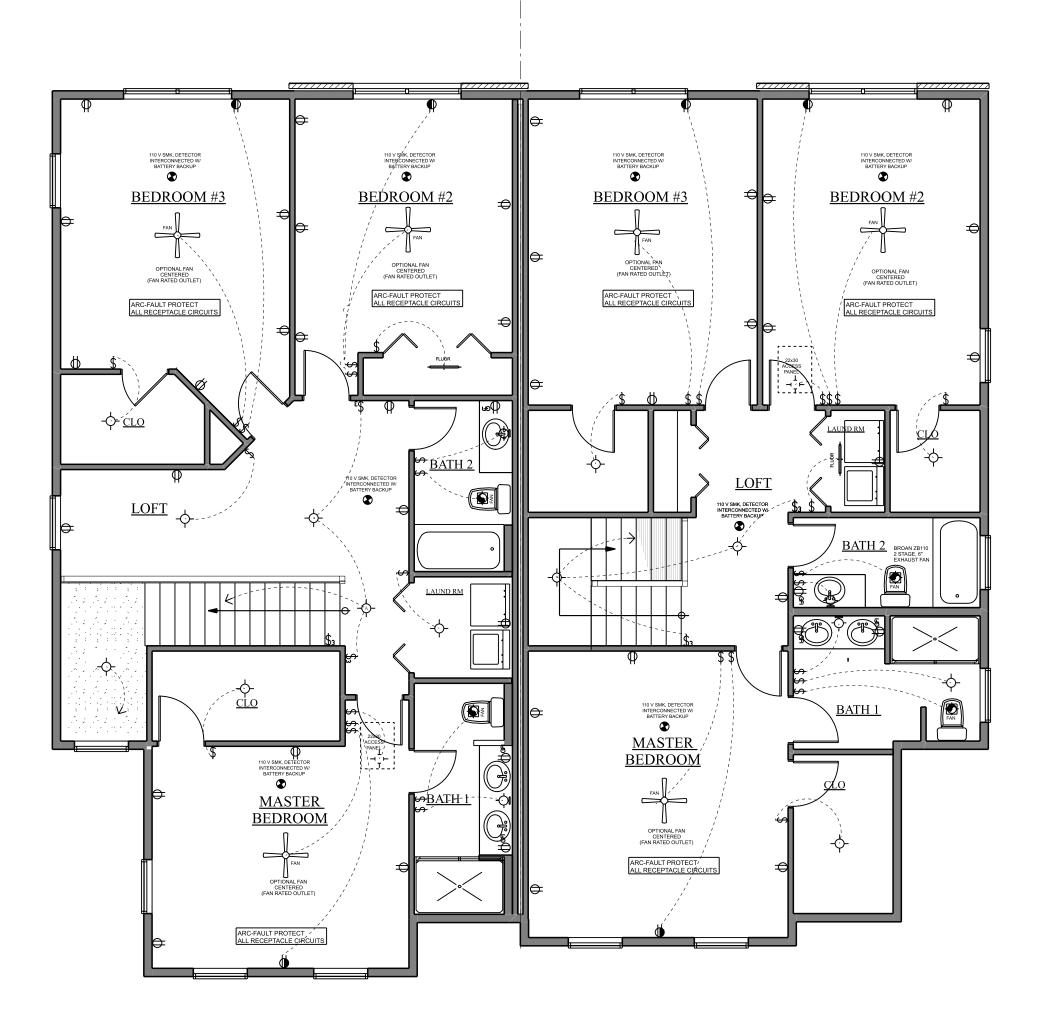



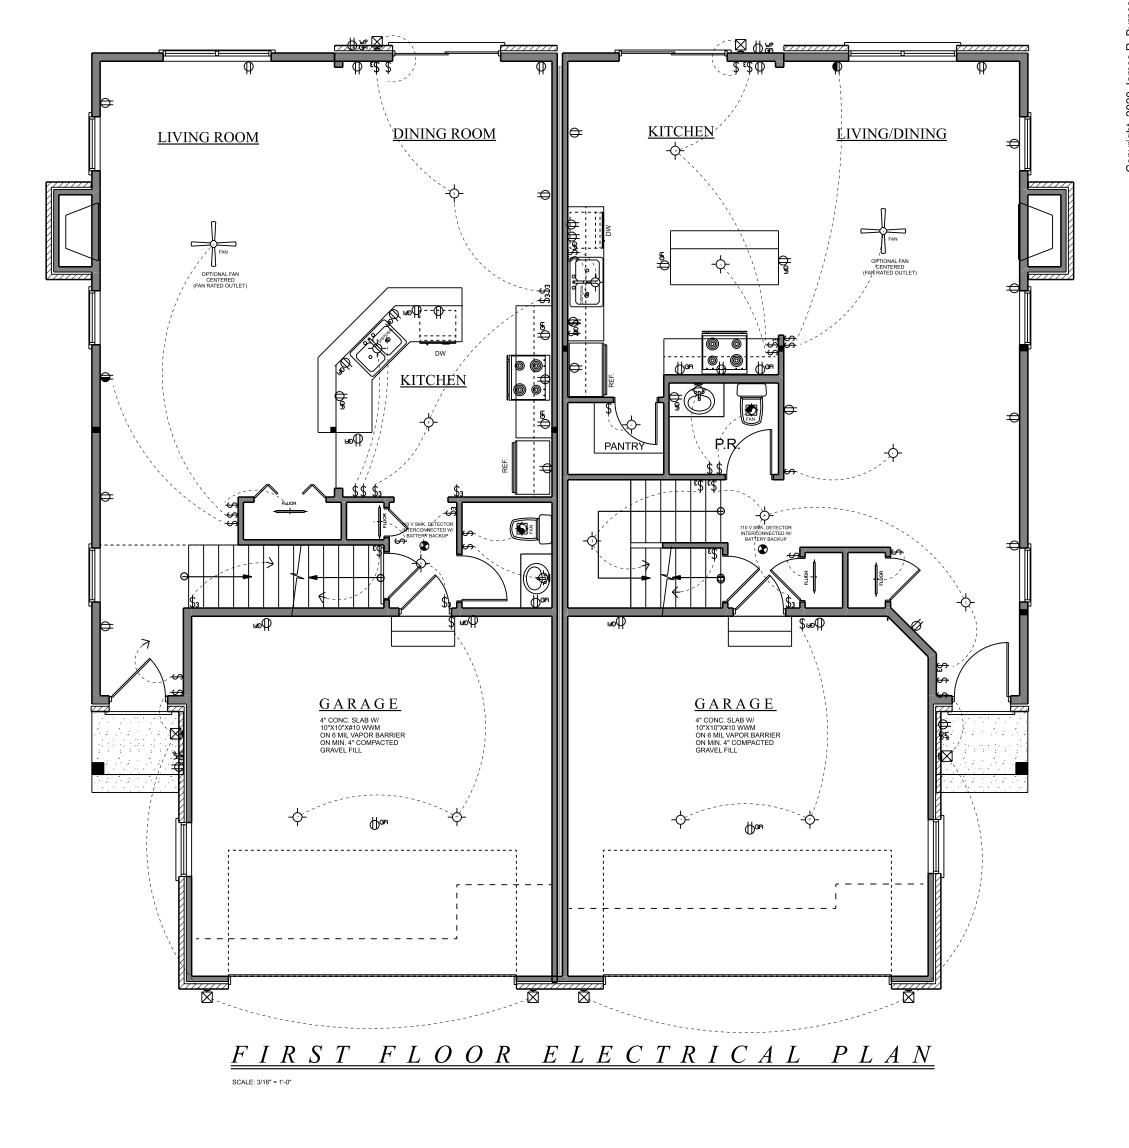


Sor Crements		STORM SUMP		STORM SUMP BASEMENT	BLEOT/PARFIEL 30' X 36' CLEAR AREA NO FRANCE 10' C C C C C C C C C C C C C C C C C C C
	\	*			
A2"W" x 24"D METAL AREA WELL AND DRAIN 3339 O	D. V. V.	110 V SMK, DETECTOR INTERCONNECTED W BATTERY BACKUP	⊰ ┼ ∜`I∷∕	EJECTOR SUMP DOUBLE JOIST 110 V SMK. DETECTOR INTERCONNECTED W BATTERY BACKUP	
		FURNACE SUMP	Z Z Z Z Z Z Z Z Z Z Z Z Z Z Z Z Z Z Z		D. B. C. D. C. B.

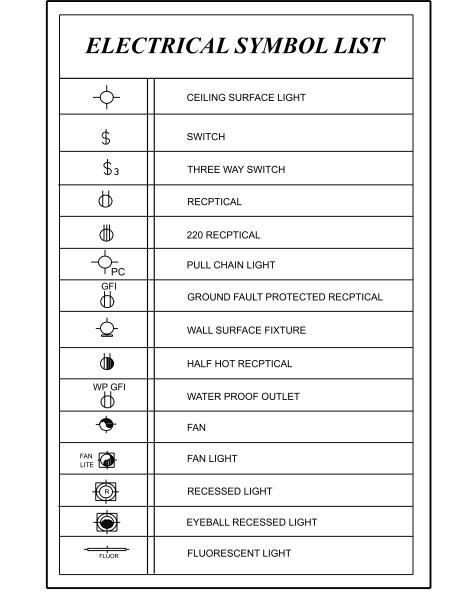

Date: 8-16-20 Issued for Permit: 2 Issued for Construction: 3 Plan No: 5		Date: R					
Date: 8-16-20 Issued for Permit: Plan No:		No.	-	7	ო	4	2
	01-7853		Issued for Permit:		Issued for Construction:	Plan No:	

<u>F O U N D A T I O N E L E C T R I C A L P L A N</u>

SCALE: 3/16" = 1'-0"

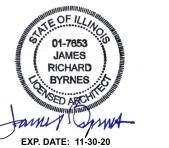

Sheet Number

Electrical Plans

P.I.N. No. 19-04-276-041 FINAL PLAT SHEET I OF I MAIL PLAT TO: **LEGEND** HAEGER ENGINEERING LLC CONSULTING ENGINEERS AND LAND SURVEYORS SET CONCRETE MONUMENT 100 EAST STATE PARKWAY ASHTON POINTE DUPLEX SUBDIVISION SCHAUMBURG, IL 60173 SET 1/2" PIPE UNLESS OTHERWISE NOTED PLAT PREPARED FOR: ROADWAY CENTER LINE WK BUILDING AND DEVELOPMENT **EASEMENT LINE** 525 W. WISE ROAD UNIT F SCHAUMBURG, IL 60193 **BUILDING SETBACK LINE** BEING A RESUBDIVISION OF LOT 110 AND PART OF OUTLOT 203 IN ASHTON POINTE, BEING A SUBDIVISION OF PART OF THE NORTHEAST QUARTER OF SEND NEW TAX BILL TO: UNDERLYING LOT LINES SECTION 4, TOWNSHIP 43 NORTH, RANGE 8, EAST OF THE THIRD PRINCIPAL WK BUILDING AND DEVELOPMENT MERIDIAN ACCORDING TO THE PLAT THEREOF RECORDED ON FEBRUARY 4 NEW LOT NO. 525 W. WISE ROAD UNIT F 2005 AS DOCUMENT NUMBER 2005R0009632, IN MCHENRY COUNTY, ILLINOIS. SCHAUMBURG, IL 60193 THIS PLAT SUBMITTED UNDERLYING PARCEL NO. FOR RECORDING BY: SCALE: I" = 20' ASHTON POINTE DOC. NO. 2005R0009632 RECORDED FEBRUARY 4, 2005 per Ashton Pointe Doc No. 2005R0009632 **OWNER'S CERTIFICATE** Recorded February 4, 2005 STATE OF ILLINOIS Ch Brg.= N 67° 42′ 48″ W COUNTY OF McHENRY / 25' Building Setback Line THIS IS TO CERTIFY THAT THE UNDERSIGNED IS THE OWNER OF THE PROFESSIONAL AUTHORIZATION per Ashton Pointe, PROPERTY DESCRIBED HEREON AND THAT IT HAS CAUSED SAID PROPERTY Doc No. 2005R0009632 STATE OF ILLINOIS TO BE SURVEYED AND SUBDIVIDED AS SHOWN HEREON FOR THE USES AND Recorded February 4, 2005 PURPOSES THEREIN SET FORTH AND DOES HEREBY ACKNOWLEDGE AND CHURCH SUBDIVISION COUNTY OF COOK ADOPT THE SAME UNDER THE STYLE AND TITLE HEREON SHOWN. DOC. NO. 2004R0085425 SEPTEMBER 22, 2004 I, JEFFREY W. GLUNT, A PROFESSIONAL LAND SURVEYOR OF THE STATE OF ILLINOIS IT FURTHER CERTIFIES TO THE BEST OF ITS KNOWLEDGE, THAT THE LAND LICENSE NUMBER 35-3695, DO HEREBY AUTHORIZE THE CITY OF CRYSTAL LAKE, INCLUDED HEREIN FALLS WITHIN CRYSTAL LAKE ELEMENTARY DISTRICT 47 MCHENRY COUNTY, ILLINOIS, ITS STAFF OR AUTHORIZED AGENT, TO PLACE THIS AND COMMUNITY HIGH SCHOOL DISTRICT 155. DOCUMENT OF RECORD IN THE COUNTY RECORDERS OFFICE IN MY NAME AND IN COMPLIANCE WITH THE ILLINOIS STATUTES CHAPTER 109 PARAGRAPH 2, AS _____, ILLINOIS, THIS _____ DAY OF _____ SCHAUMBURG, ILLINOIS MAY 19, 2021 Total Area = 12,920 S.F. JEFFREY W. GLUNT ILLINOIS PROFESSIONAL LAND SURVEYOR NO. 35-3695 Lot 2 MY LICENSE EXPIRES NOVEMBER 30, 2020 AND IS RENEWABLE Total Area = 10,855 S.F. = 0.2492 AC.**SURVEYORS CERTIFICATE** NOTARY CERTIFICATE STATE OF ILLINOIS) STATE OF ILLINOIS COUNTY OF COOK) COUNTY OF McHENRY I, JEFFREY W. GLUNT, AN ILLINOIS PROFESSIONAL LAND SURVEYOR, DO HEREBY I, THE UNDERSIGNED, A NOTARY PUBLIC IN AND FOR THE SAID COUNTY IN THE CERTIFY THAT I HAVE SURVEYED AND SUBDIVIDED THE FOLLOWING DESCRIBED STATE AFORESAID DOES HEREBY CERTIFY THAT PERSONALLY KNOWN TO ME OR PROVED TO ME ON THE BASIS OF LOT 110 AND PART OF OUTLOT 203 IN ASHTON POINTE, BEING A SUBDIVISION OF SATISFACTORY EVIDENCE TO BE THE SAME PERSON WHOSE NAME IS LOT 109 PART OF THE NORTHEAST QUARTER OF SECTION 4, TOWNSHIP 43 NORTH, RANGE 8, SUBSCRIBED TO THE FOREGOING INSTRUMENT, APPEARED BEFORE ME THIS ASHTON POINTE EAST OF THE THIRD PRINCIPAL MERIDIAN ACCORDING TO THE PLAT THEREOF DAY IN PERSON AND ACKNOWLEDGE THAT HE SIGNED AND DELIVERED SAID DOC. NO. 2005R0009632 RECORDED ON FEBRUARY 4, 2005 AS DOCUMENT NUMBER 2005R0009632, IN INSTRUMENT AS HIS OWN FREE AND VOLUNTARY ACT AND AS THE FREE AND RECORDED FEBRUARY 4, 2005 MCHENRY COUNTY, ILLINOIS. VOLUNTARY ACT OF SAID CORPORATION FOR THE USES AND PURPOSES THEREIN SET FORTH. THE LANDS SHOWN ON THE PLAT AND DESCRIBED IN THE ABOVE CAPTION, AND THAT THE SAID PLAT, DRAWN TO A SCALE OF 20 FEET PER 1 INCH ON SHEET ONE IS GIVEN UNDER MY HAND AND NOTARIAL SEAL THIS _____DAY OF_____ A TRUE AND CORRECT REPRESENTATION OF THE SAID SURVEY AND SUBDIVISION. DIMENSIONS ARE GIVEN IN FEET AND DECIMAL PARTS THEREOF AND ARE CORRECTED TO A TEMPERATURE OF 68 DEGREES FAHRENHEIT. I FURTHER CERTIFY THAT UPON COMPLETION OF CONSTRUCTION BUT NOT LONGER PRINT NAME THAN ONE YEAR FROM THE RECORDING OF THIS PLAT, CONCRETE MONUMENTS, AS SHOWN, AND IRON PIPES AT ALL LOT CORNERS AND POINTS OF CHANGE IN OUTLOT C ALIGNMENT WILL BE SET, AS REQUIRED BY THE PLAT ACT (765 ILCS 205/0.01 ET SEQ.). ASHTON POINTE OUTLOT 203 THIS IS TO FURTHER CERTIFY THAT THE LAND INCLUDED IN THE ANNEXED PLAT IS DOC. NO. 2005R0009632 ASHTON POINTE WITHIN THE CORPORATE LIMITS OF THE CITY OF CRYSTAL LAKE, MCHENRY COUNTY, RECORDED FEBRUARY 4, 2005 DOC. NO. 2005R0009632 NOTARY PUBLIC ILLINOIS, WHICH HAS AN OFFICIAL COMPREHENSIVE PLAN AND IS EXERCISING THE RECORDED FEBRUARY 4, 2005 SPECIAL POWERS AUTHORIZED BY THE STATE OF ILLINOIS ACCORDING TO 65 ILCS 5/11-12-6 AS HERETOFORE AND HEREAFTER AMENDED. **COMMISSION EXPIRES:** I DO HEREBY FURTHER CERTIFY THAT THE ABOVE DESCRIBED PROPERTY IS ENTIRELY WITHIN THE CORPORATE LIMITS OF THE CITY OF CRYSTAL LAKE, ILLINOIS, WHICH HAS ADOPTED A CITY PLAN AND IS EXERCISING THE SPECIAL POWERS **COUNTY CLERK CERTIFICATE** AUTHORIZED BY DIVISION 12 OF ARTICLE 11 OF THE ILLINOIS MUNICIPAL CODE AS STATE OF ILLINOIS THIS IS TO CERTIFY THAT THE PARCELS INCLUDED IN THIS RECORD OF DEED ARE SURFACE WATER DRAINAGE CERTIFICATE PLAN COMMISSION CERTIFICATE CITY COUNCIL CERTIFICATE COUNTY OF McHENRY NOT LOCATED IN THE SPECIAL FLOOD HAZARD AREA IDENTIFIED FOR MCHENRY COUNTY, ILLINOIS, BY THE FEDERAL EMERGENCY MANAGEMENT AGENCY ON THE STATE OF ILLINOIS STATE OF ILLINOIS STATE OF ILLINOIS FLOOD INSURANCE RATE MAP, PANEL NO. 17111C0335J DATED NOVEMBER 16, 2006. COUNTY CLERK OF McHENRY COUNTY COUNTY OF COOK THIS PROFESSIONAL SERVICE CONFORMS TO THE CURRENT ILLINOIS MINIMUM ILLINOIS, DO HEREBY CERTIFY THAT THERE ARE NO DELINQUENT GENERAL COUNTY OF McHENRY COUNTY OF McHENRY STANDARDS OF PRACTICE APPLICABLE TO BOUNDARY SURVEYS. TAXES, NO UNPAID FORFEITED TAXES AND NO REDEEMABLE TAX SALES TO THE BEST OF OUR KNOWLEDGE AND BELIEF, THE DRAINAGE OF SURFACE WATERS AGAINST ANY OF THE LAND IN THE ANNEXED PLAT. I FURTHER CERTIFY THAT I REVIEWED BY THE PLAN COMMISSION OF THE CITY OF CRYSTAL LAKE, THIS SUBDIVISION IS APPROVED BY THE CITY COUNCIL OF THE CITY OF WILL NOT BE CHANGED BY THE CONSTRUCTION OF SUCH SUBDIVISION OR ANY PART SCHAUMBURG, ILLINOIS MAY 19, 2021 THEREOF. OR THAT IF SUCH SURFACE WATER DRAINAGE WILL BE CHANGED, HAVE RECEIVED ALL STATUTORY FEES IN CONNECTION WITH THE ANNEXED McHENRY COUNTY, ILLINOIS. CRYSTAL LAKE, ILLINOIS, AT A MEETING HELD ADEQUATE PROVISION HAS BEEN MADE FOR COLLECTION, DIVERSION, AND DISCHARGE OF SUCH WATERS INTO PUBLIC AREAS OR DRAINS WHICH THE _, A.D. 20 ____ SUBDIVIDER HAS THE RIGHT TO USE AND THAT SUCH SURFACE WATERS WILL BE GIVEN UNDER MY HAND AND SEAL OF THE COUNTY CLERK, McHENRY COUNT PLANNED FOR IN ACCORDANCE WITH GENERALLY ACCEPTED ENGINEERING ILLINOIS PROFESSIONAL LAND SURVEYOR NO. 35-3695 PRACTICES SO AS TO REDUCE THE LIKELIHOOD OF SUBSTANTIVE DAMAGE TO THE . JEFFREY W MY LICENSE EXPIRES NOVEMBER 30, 2020 AND IS RENEWABLE ADJOINING PROPERTY BECAUSE OF THE CONSTRUCTION OF THE SUBDIVISION. GLUNT 035-3695 SCHAUMBURG, Originally Prepared: 05-19-21 Project No. 20-085 062-053214 LICENSED **COUNTY CLERK** PROFESSIONAL ILLINOIS PROFESSIONAL ENGINEER CITY CLERK ENGINEER ATTEST: SECRETARY EXPIRES 11-30-22 NO. 062-053214 100 East State Parkway, Schaumburg, IL 60173 Tel: 847.394.6600 Fax: 847.394.6608 EXPIRES 11-30-21 Illinois Professional Design Firm License No. 184-003152 www.haegerengineering.com