

#2021-226

GW Properties Wendy's and Guzman Y Gomez – Final Planned Unit Development Project Review for Planning and Zoning Commission

Meeting Date: January 19, 2022

Request: Final Planned Unit Development for two new limited service

restaurants.

Location: 5459 and 5501 Northwest Highway

Acreage: Approximately 2.06 acres

Existing Zoning: B-2 PUD General Commercial Planned Unit Development

Surrounding Properties: North: B-2 PUD General Commercial

South: M Manufacturing (Three Oaks Recreation Area)

East: B-2 PUD General Commercial West: B-2 PUD General Commercial

Staff Contact: Elizabeth Maxwell (815.356.3615)

Background:

- The site was the buildings and parking lot for the previous office building, then a used car
 lot for Pauley Toyota. The previous buildings have been demolished and the site is now
 vacant.
- The site sits along Route 14 and backs to the Three Oaks Recreation Area. It is part of the Three Oaks Recreation Area Planned Unit Development Overlay District. It is the intent of the Three Oaks PUD Overlay District to promote orderly and high-quality development that is compatible with the character and use of Three Oaks, consistent with and complementary of the area's recreational uses and amenities, and supportive of a strong and stable tax base.
- The Raising Canes was approved in 2020 and is currently in operation.
- This project received Preliminary PUD approval in June of 2021.
- The Final PUD is in substantial conformance with the approved Preliminary PUD.

Land Use Analysis:

ZONING

• The site is currently zoned B-2 PUD General Commercial. Limited Service Restaurant is a permitted use in the B-2 zoning district.

• The Comprehensive Land Use Plan designates this area as Commerce. The proposed restaurant uses fit in the Commerce land use designation.

SITE PLAN

- The site is along Northwest Highway east of the Three Oaks Recreation Area entrance. These two lots are between the existing Cassidy Tire and the Raising Cane's lot.
- The site backs to the north lake of the Three Oaks Recreation Area. A future boardwalk is planned behind these lots, which has been illustrated on these plans. Raising Canes has provided a 20-foot area reserved for the future boardwalk. To plan for the future amenity Wendy's is providing 20 feet and Guzman Y Gomez is providing 57 feet for easements.
- There are two access points into the site from Route 14, one on the Raising Cane's parcel and a shared access between the Wendy's parcel and Cassidy Tire. There is a shared cross access easement among all three properties.
- The traffic impact study suggests some minor changes and the addition of striping and signage to improve the site.

TRAFFIC STUDY

- A traffic study was completed by Gewalt Hamilton on behalf of Raising Cane's and contemplated another restaurant at this location.
- This traffic study has been updated and presented for review as part of the Final Planned Unit Development approval.

ELEVATIONS

- Wendy's elevations have been revised to include the knee wall along the side elevations under the window bays and to install a canopy over the side elevation entrance.
- Guzman Y Gomez elevations have been revised to:
 - o Install a yellow canopy over the entrance doors,
 - Break up the charcoal brick on the West and South elevations with some additional Alamo colored brick,
 - o Increased the width of the framing around the doors,
 - o Added horizontal framing members to the windows, and
 - o Installed soldier course brick of two rows along the tower element and one row under the remainder of the top cap giving the top a much thicker and finished look.

LANDSCAPE PLAN

• The landscape plan meets all the requirements.

SIGNAGE

- Both uses have wall signage that blends well with the architecture and the size and scale of the building.
- Guzman Y Gomez received a sign variation for wall signs and the mural up to 416.87 sf.

Findings of fact:

Final Planned Unit Development

The petitioner is requesting approval of a Final Planned Unit Development to allow the construction of two Limited Service Restaurant for a Wendy's and a Guzman Y Gomez. The Final PUD must be reviewed against the approved preliminary PUD conditions. The Final PUD is in substantial compliance with the approved preliminary PUD and the petitioners have provided revised plans to address the conditions of approval.

Comprehensive Land Use Plan 2030 Summary Review:

The Comprehensive Plan designates the subject property as Commercial, which allows for existing and future commercial and business uses. The following goal is applicable to this request:

<u>Land Use – Commercial</u>

Goal: Maintain a dynamic and sustainable base of commercial uses that provides a solid tax base, goods, services and jobs to the city as well as the surrounding region through coordination in the Unified Development Ordinance, Comprehensive Land Use Plan and Economic Development Strategic Plan.

This can be accomplished with the following supporting actions:

Supporting Action: Promote, retain and attract businesses that provide a diverse tax base.

Success Indicator: The number of new "chain store" occupancies.

Recommended Conditions:

If a motion to recommend approval of the petitioner's request is made it should be with the following conditions:

- 1. Approved plans, reflecting staff and advisory board recommendations, as approved by the City Council:
 - A. Application (GW Properties, received 01/13/22)
 - B. Site Plan (Design Studio 24, dated 07/28/21, received 12/21/21)
 - C. Landscape Plan (Kimley Horn, dated 05/18/21, received 12/21/21)
 - D. Wendy's Elevations (Wallin Gomez Architects, dated 06/21/21, received 12/21/21)
 - E. Wendy's Monument Sign (Custom Sign Center, dated 04/27/21, received 12/21/21)
 - F. Guzman Y Gomez Elevations (Interplan, dated 06/07/21, received 12/21/21)
 - G. Traffic Impact Study (Gewalt Hamilton, updated 6/30/21, received 12/21/21)
- 2. Conditions from Ordinance 7721 shall remain applicable unless modified by this request.

3. Elevations

A. Wendy's to install one or two rows of soldier course brick approximately 1/3 down from the top of the parapet on the rear portion where the building increases in height to help break up the expanse of brick.

- B. The Guzman Y Gomez brick color shall be Yankee Hill Matte Charcoal.
- C. On the Guzman Y Gomez building the soldier course brick under the top cap should project at least 1 inch beyond the main portion of the elevation and the top cap should project at least 1 inch beyond this brick.

4. Traffic Study

- A. Add stop bars and signage as recommended in the Traffic Study to promote a safer pedestrian and cycling experience.
- B. Improve the shared site access driveway, opposite Federal Drive:
 - i. Widen the driveway to the east to provide one inbound and two outbound lanes.
 - ii. Stripe the existing lanes as they should be marked as a separate left-turn lane and a shared through/right-turn lane.
 - iii. Install a stop sign at this driveway.
- C. The entrance to the Wendy's site should provide a raised "truck apron" to give the appearance of a narrower entrance drive to help limit speed of inbound vehicles while still accommodating the larger delivery vehicles needed.
- D. Install appropriate way-finding signage on site to direct traffic to various drive-throughs.
- 5. Wendy's and Guzman Y Gomez shall participate with the City during the construction of the boardwalk and related amenities like benches, gazebos, etc. along their property.
- 6. The Wendy's monument sign brick shall match the brick of the building.
- 7. The petitioner shall address all of the review comments and requirements of the Community Development, Fire Rescue, and Public Works Departments, as well as the City's Stormwater Consultant and the final approved Traffic Study.

PIQ Map







The following information is related to a development application. As the owner of the property in question, I (we) acknowledge that the information provided in the submittal was reviewed and approved.

Owner Information		
Name:		
Address:		
Phone:		
E-mail:		
Project Name & Description:		
Project Address/Location:		
Signature		
Mitch Loty 1	fitch Goltz	1/13/2022
Owner: Print and Sign name		Date

NOTE: If the property is held in a trust, the trust officer must sign this petition as owner. In addition, the trust officer must provide a letter that names all beneficiaries of the trust.

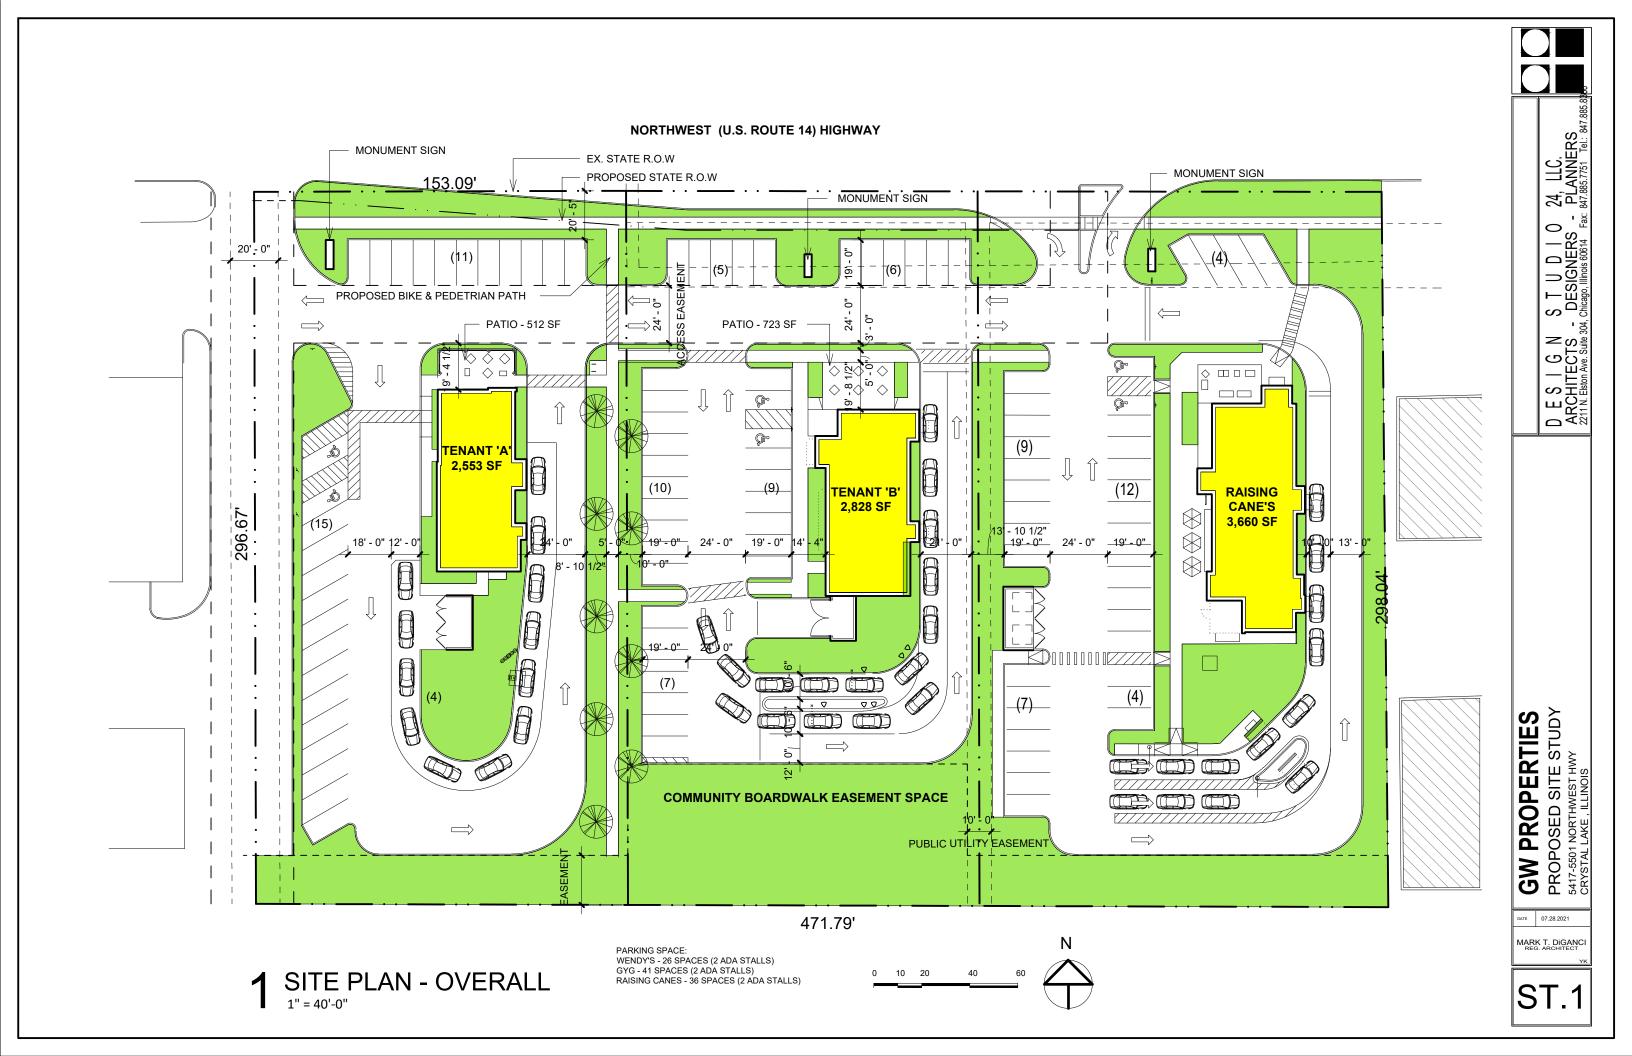


NORTHWEST (U.S. ROUTE 14) HIGHWAY

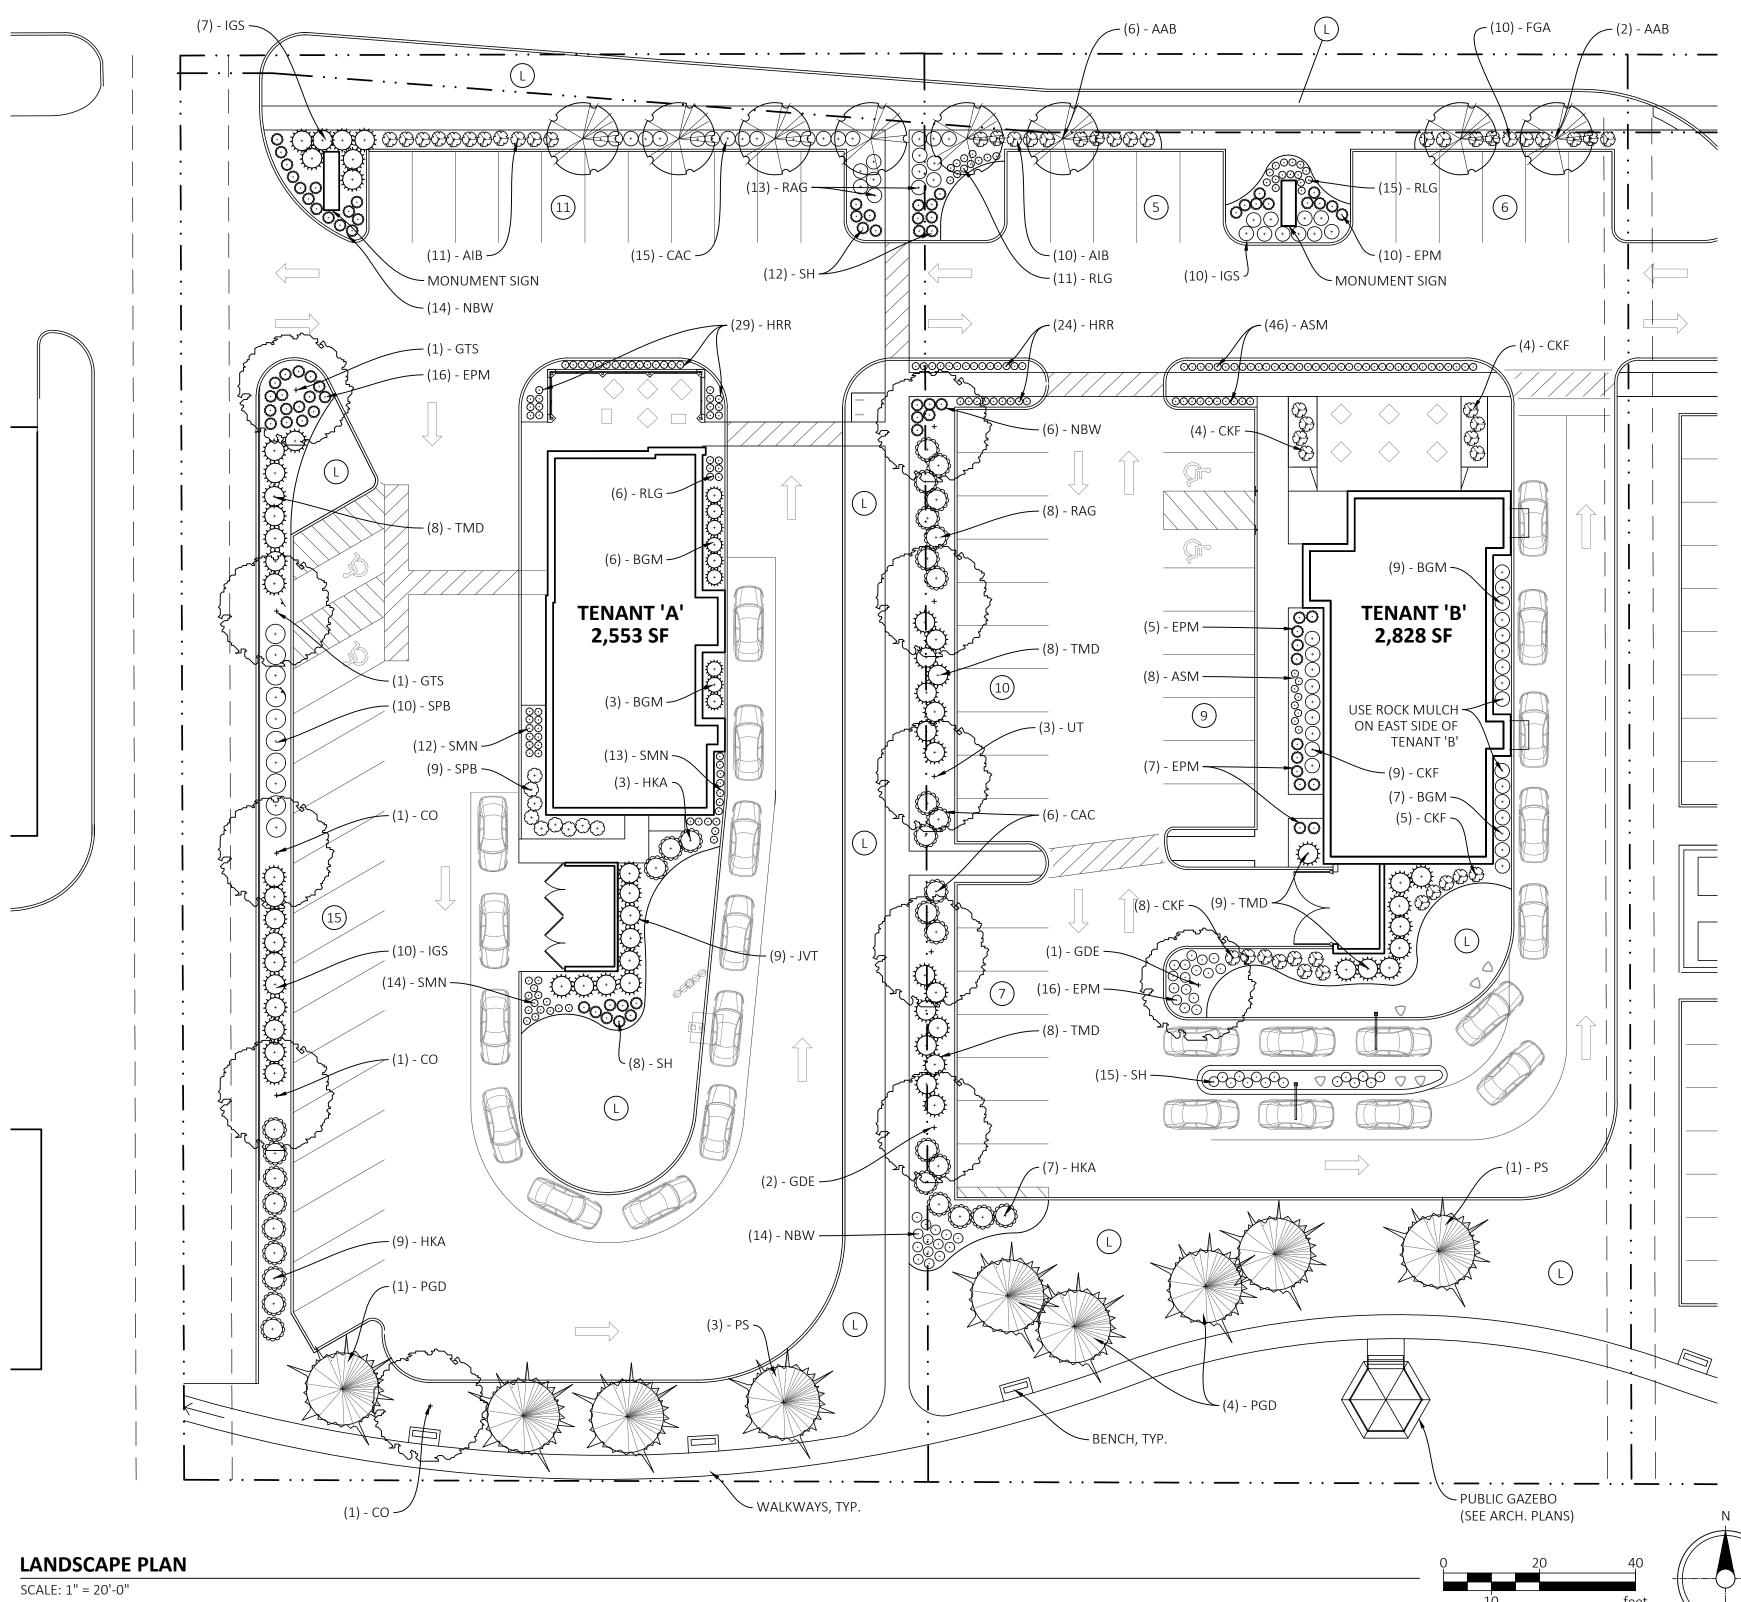

ANDSCAPE PL	.AN	

	LANDSCAPE ORDINANCE REVI	EW: CRYSTAL LAKE, ILLINOIS	
SPECIFIC ORDINANCE	CODE REQUIRES	CALCULATION	COMPLIANCE
SEC. 4-400.F.1.a.i	ONE (8) EIGHT-FOOT BY (19) NINETEEN-FOOT LANDSCAPE ISLAND, AS MEASURED BETWEEN BACK OF CURBS, CONTAINING ONE CANOPY OR ORNAMENTAL TREE AND FIVE SHRUBS, EVERY 10 PARKING SPACES AND AT	TENANT 'A': 26 PARKING SPACES TOTAL / 10 SPACES = 3 CANOPY TREES & 25 SHRUBS	5 TREES & 40 SHRUBS PROVIDED
	THE ENDS OF EVERY PARKING ROW.	TENANT 'B': 37 PARKING SPACES TOTAL / 10 SPACES = 4 CANOPY TREES & 20 SHRUBS	5 TREES & 40 SHRUBS PROVIDED
SEC. 4-400.F.1.b.i	CONTINUOUS VISUAL SCREEN 15 FEET IN WIDTH USING BOTH DECIDUOUS AND EVERGREEN SPECIES PLANTED IN UNDULATING BEDS FORMING AN INTERESTING PATTERN REQUIRING ONE CANOPY, ORNAMENTAL OR EVERGREEN TREE AND 10 SHRUBS, WITH SHRUBS PLANTED AT VARIOUS HEIGHTS, AVERAGING THREE FEET IN HEIGHT, ALONG EVERY 40 LINEAL FEET.	NORTHWEST HWY (300 LF) / 40 LF = 7.5 8 TREES & 75 SHRUBS REQUIRED	8 ORNAMENTAL TREES (OVERHEAD WIRES PRESENT) & 70 SHRUBS PROVIDED. DRIVEWAYS AND SIGHT TRIANGLES PREVENT ADDITIONAL SHRUBS.
SEC. 4-400.F.4.a	FIVE-FOOT-WIDE LANDSCAPE AREA AROUND ALL PERIMETERS OF BUILDINGS CONTAINING BOTH DECIDUOUS AND EVERGREEN SPECIES OF TREE AND SHRUBS PROVIDING AN INTERESTING VISUAL PATTERN AROUND THE BUILDING.	N/A	PROVIDED
SEC. 4-400.F.6.a	THE AMOUNT OF LANDSCAPE AREA REQUIRED SHALL BE ONE SQUARE FOOT OF LANDSCAPE AREA PER ONE SQUARE FOOT OF SIGN AREA. THE LANDSCAPING SHALL BE LOCATED IN AN AREA RADIATING FROM THE BASE OF THE SIGN.	SIGN AREA = 260 SF / 10 SF = 26 SF LANDSCAPE AREA (13 SF TREES OR SHRUBS)	PROVIDED

		1	PLANTING SCHEDUL	L	1	T
KEY	QTY.	BOTANICAL NAME	COMMON NAME	SIZE	SPACING	COMMENTS
DECIDU	IOUS TRE	ES				
СО	3	CELTIS OCCIDENTALIS	COMMON HACKBERRY	2.5" CAL.		B&B SPECIMEN; 7'-0" M BRANCHING HEIGHT
GDE	3	GYMNOCLADUS DIOCUS 'ESPRESSO'	ESPRESSO KENTUCKY COFFEETREE	2.5" CAL.		B&B SPECIMEN; 7'-0" M BRANCHING HEIGHT
GTS	2	GLEDITSIA TRIACANTHOS 'SKYLINE'	SKYLINE HONEYLOCUST	2.5" CAL.		B&B SPECIMEN; 7'-0" M BRANCHING HEIGHT
UT	3	ULMUS X TRIUMPH	TRIUMPH ELM	2.5" CAL.		B&B SPECIMEN; 7'-0" M BRANCHING HEIGHT
EVERG	REEN TRI	EES				
JVT	9	JUNIPERUS VIRGINIANA 'TAYLOR'	TAYLOR EASTERN REDCEDAR	6'-8' HT.	4' O.C.	B&B SPECIMEN
PGD	5	PICEA GLAUCA 'DENSATA'	BLACK HILLS SPRUCE	6'-8' HT.	15' O.C.	B&B SPECIMEN
PS	4	PINUS STROBUS	EASTERN WHITE PINE	6'-8' HT.	30' O.C.	B&B SPECIMEN
ORNAM	IENTAL T	REES				
AAB	8	AMELANCHIER 'AUTUMN BRILLIANCE'	AUTUMN BRILLIANCE SERVICEBERRY	8' HT.	15' O.C.	MULTI-STEM SPECIMEN
DECIDU	IOUS SHR	RUBS			_ I	
AIB	21	ARONIA MELANOCARPA 'MORTON'	IROQUOIS BEAUTY CHOKEBERRY	#3 CONT.	36" O.C.	INSTALL 30" HT., MINIM
CAC	21	CLETHRA ALNIFOLIA 'CALEB'	VANILLA SPICE SUMMERSWEET	#3 CONT.	48" O.C.	INSTALL 30" HT., MINIM
FGA	10	FOTHERGILLA GARDENII	DWARF FOTHERGILLA	#3 CONT.	36" O.C.	INSTALL 30" HT., MINIM
НКА	19	HYPERICUM KALMIANUM	KALM'S ST. JOHNSWORT	#3 CONT.	36" O.C.	INSTALL 30" HT., MINIM
RAG	21	RHUS AROMATICA 'GRO LOW'	GRO-LOW SUMAC	#3 CONT.	48" O.C.	
SPB	19	SYRINGA PENDA 'BLOOMERANG'	BLOOMERANG DWARF LILAC	#3 CONT.	36" O.C.	INSTALL 30" HT., MININ
EVERGI	REEN SHI	RUBS			•	
BGM	25	BUXUS 'GREEN MOUNTAIN'	GREEN MOUNTAIN BOXWOOD	#3 CONT.	36" O.C.	
IGS	27	ILEX GLABRA 'SHAMROCK'	SHAMROCK INKBERRY	#3 CONT.	36" O.C.	INSTALL 30" HT., MININ
TMD	33	TAXUS x MEDIA 'DENSIFORMIS'	DENSE YEW	#3 CONT.	48" O.C.	
PERENI	NIALS, GF	RASSES & GROUNDCOVERS			1	
ASM	54	ALLIUM 'MILLENIUM'	MILLENIUM ALLIUM	#1 CONT.	18" O.C.	
CKF	30	CALAMOGROSTIS X 'KARL FOERSTER'	KARL FOERSTER FEATHER REED GRASS	#3 CONT.	36" O.C.	
EPM	54	ECHINACEA 'CBG CONE2'	PIXIE MEADOWBRITE CONEFLOWER	#1 CONT.	24" O.C.	
HRR	53	HEMEROCALLIS 'ROSY RETURNS'	ROSY RETURNS DAYLILY	#1 CONT.	18" O.C.	
NBW	34	NEPETA 'BLUE WONDER'	BLUE WONDER CATMINT	#1 CONT.	24" O.C.	
RLG	32	RUDBECKIA 'LITTLE GOLDSTAR'	LITTLE GOLDSTAR BLACK-EYED SUSAN	#1 CONT.	18" O.C.	
SMN	37	SALVIA 'MAY NIGHT'	MAY NIGHT SALVIA	#1 CONT.	18" O.C.	
	1					1

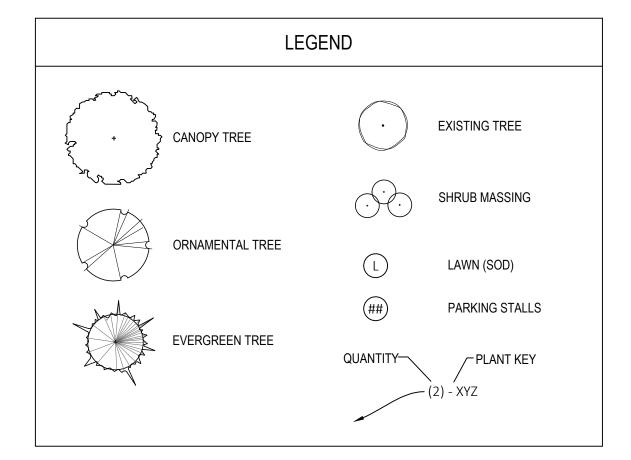



P.O. BOX 2256 CHESTERTON, IN 46304



(219) 299.3383 www.planviron.com



L101

ORIGINAL ISSUE:

5/18/2021 KHA PROJECT NO.

168726001

SHEET NUMBER

EXP: 8/31/2021


CRYSTAL


GW

LANDSCAPE PLAN


LANDSCAPE NOTES:

- 1. SEE SHEET L101 FOR LANDSCAPE ORDINANCE REVIEW DATA TABLE & PLANTING SCHEDULE.
- 2. THE LANDSCAPE CONTRACTOR SHALL OBTAIN AND PAY FOR ALL PERMITS AND FEES THAT MAY BE REQUIRED FOR HIS PORTION OF WORK.
- 3. IN CASE OF DISCREPANCIES BETWEEN THE PLAN AND THE PLANT LIST, THE GRAPHIC SYMBOLS SHOWN ON THE PLAN SHALL DICTATE.
- 4. NO SUBSTITUTIONS OF PLANT MATERIALS WILL BE ALLOWED. IF PLANTS ARE NOT AVAILABLE, THE CONTRACTOR SHALL NOTIFY LANDSCAPE ARCHITECT PRIOR TO BID IN WRITING. ALL PLANTS SHALL BE INSPECTED AND TAGGED WITH PROJECT I.D. AT NURSERY OR CONTRACTORS OPERATIONS PRIOR TO MOVING TO JOB SITE. PLANTS MAY BE INSPECTED AND APPROVED OR REJECTED ON THE JOB SITE BY LANDSCAPE ARCHITECT.
- 5. LANDSCAPE CONTRACTOR SHALL NOTIFY LANDSCAPE ARCHITECT IN WRITING PRIOR TO BID DATE OF ANY PLANTS HE/SHE FEELS MAY NOT SURVIVE IN LOCATIONS NOTED ON PLANS.
- 6. ALL PLANTS SHALL MEET OR EXCEED AMERICAN STANDARDS FOR NURSERY STOCK, 1986 EDITION, AS SET FORTH BY AMERICAN ASSOCIATION OF NURSERYMEN.
- 7. ALL PLANT MATERIAL AND SEED SHALL BE PROVIDED FROM A NURSERY (WITHIN 200 MILES) WITH A SIMILAR PLANT HARDINESS ZONE AS PROJECT LOCATION
- 8. PLANTS AND ALL OTHER MATERIALS TO BE STORED ON SITE WILL BE PLACED WHERE THEY WILL NOT CONFLICT W/ CONSTRUCTION OPERATIONS AND AS DIRECTED BY LANDSCAPE ARCHITECT.
- 9. FINAL PLACEMENT OF PLANT MATERIALS, ETC., SHALL BE APPROVED BY LANDSCAPE ARCHITECT BEFORE PLANTING OPERATIONS ARE TO PROCEED. ALL TREE LOCATIONS SHALL BE MARKED WITH A WOOD STAKE INDICATING VARIETY AND SIZE OF TREE. ALL GROUND COVER AND PLANTING BED LINES SHALL BE MARKED W/ HIGHLY VISIBLE PAINT LINES W/ OCCASIONAL WOOD STAKES FOR REFERENCE. ALL STAKES SHALL BE REMOVED FOLLOWING PLANTING OPERATIONS. LANDSCAPE ARCHITECT RESERVES THE RIGHT TO ADJUST PLANT LOCATIONS ON SITE.
- 10. IRRIGATION SYSTEM- PROVIDE AN ALTERNATIVE COST FOR A LANDSCAPE IRRIGATION SYSTEM. PROVIDE A BACKFLOW PREVENTER PER LOCAL CODE. PROVIDE A CONTROLLER. LAWN ZONES ARE TO BE COVERED BY SPRAY HEADS OR ROTARY HEADS. ALL SHRUBS BEDS ARE TO BE IRRIGATED WITH DRIP (NETAFIM).
- 11. CONTRACTOR SHALL EXCAVATE A MINIMUM OF 2'-0" BELOW THE PAVING SURFACE.
- 12. ALL SEED & SOD AREAS SHALL RECEIVE A MINIMUM OF 6" DEPTH OF TOPSOIL
- 13. ALL PLANTING BEDS SHALL RECEIVE 6" DEPTH OF PREPARED SOIL.
- 14. MULCH SHALL BE APPROVED BY LANDSCAPE ARCHITECT AND SHALL BE UNIFORM IN TEXTURE AND COLOR AND SHALL BE OBTAINED FROM SAWMILL OR LUMBERING OPERATION. NO UTILITY MULCH OR PROCESSED TREE TRIMMINGS WILL BE ALLOWED
- 14.1. ALL SHRUB PLANTING AREA SHALL BE COVERED WITH 3" LAYER OF SHREDDED HARDWOOD BARK
- 14.2. ALL GROUND COVER BEDS SHALL BE COVERED WITH 2" LAYER OF SHREDDED HARDWOOD BARK
- 15. ALL LANDSCAPE PLANTINGS TO BE MAINTAINED BY CONTRACTOR FOR 60 DAYS MIN. FOLLOWING COMPLETE INSTALLATION AND FINAL INSPECTION BY LANDSCAPE ARCHITECT. MAINTENANCE SHALL INCLUDE WATERING, WEEDING, CULTIVATING, MULCHING, MOWING, AND ALL OTHER NECESSARY OPERATIONS REQUIRED FOR PROPER ESTABLISHMENT OF LAWNS AND PLANTINGS. CONTRACTOR TO SUBMIT UNIT PRICES ON EVERY TYPE OF WORK AS REQUIRED BY LANDSCAPE ARCHITECT.
- 16. ALL LANDSCAPE PLANTINGS SHALL BE GUARANTEED FOR A PERIOD OF ONE YEAR FOLLOWING FINAL INSPECTION BY LANDSCAPE ARCHITECT. AT THE END OF THIS PERIOD, PLANT MATERIAL TERMED DEAD OR UNSATISFACTORY BY LANDSCAPE ARCHITECT SHALL BE REPLACED AT NO ADDITIONAL CHARGE BY THE LANDSCAPE CONTRACTOR. THE REPLACEMENTS SHALL ALSO BE GUARANTEED FOR 1 YEAR.
- 17. AN APPROVED PRE-EMERGENT HERBICIDE SHALL BE APPLIED IN ALL PLANTING BEDS AT A RATE SPECIFIED BY MANUFACTURER FOR EACH PLANT VARIETY.

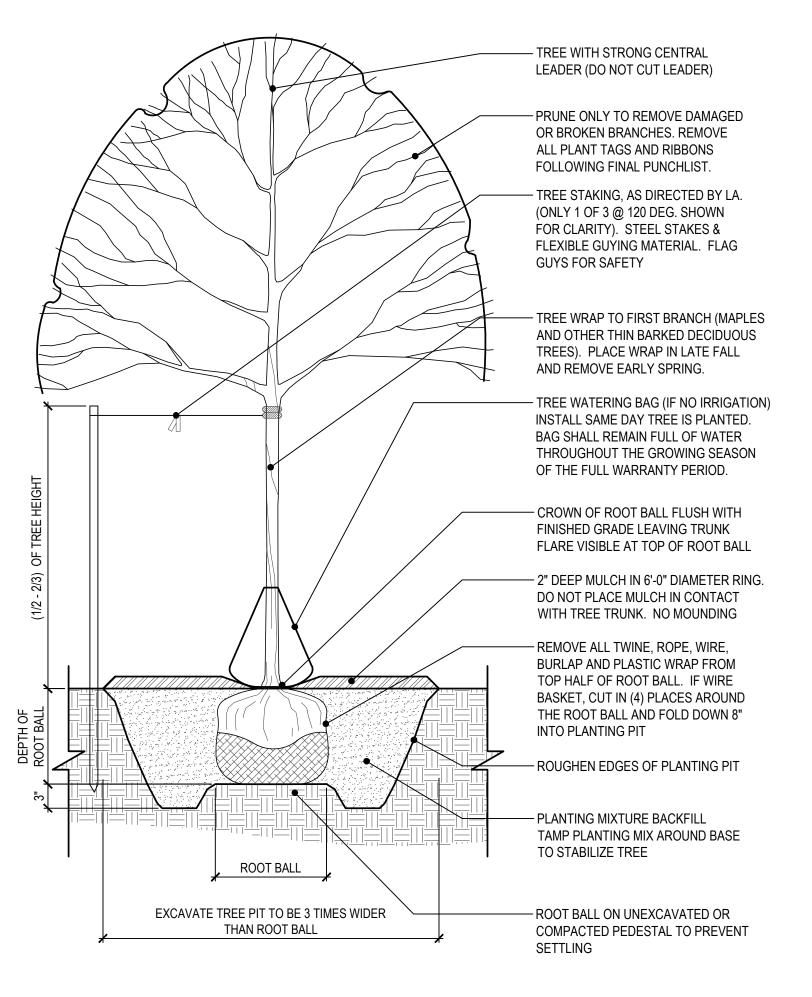

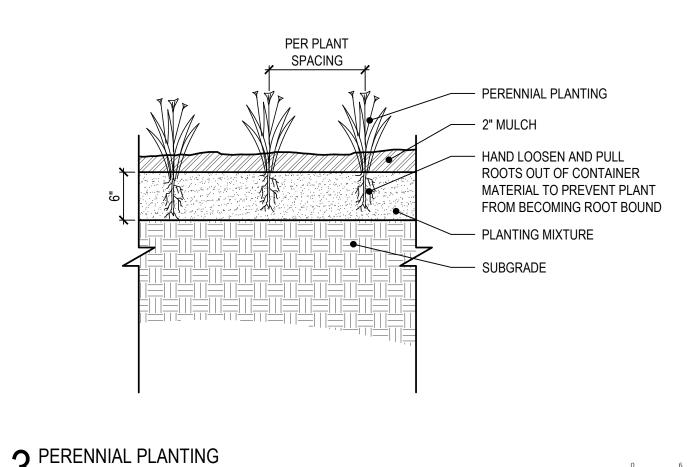


SCALE: 1" = 1'-0"

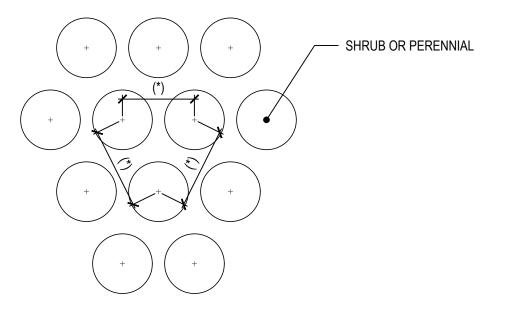


(*) = SPECIFIED PLANT SPACING IN PLANT SCHEDULE

TREE PLANTING

SCALE: 1/2" = 1'-0"

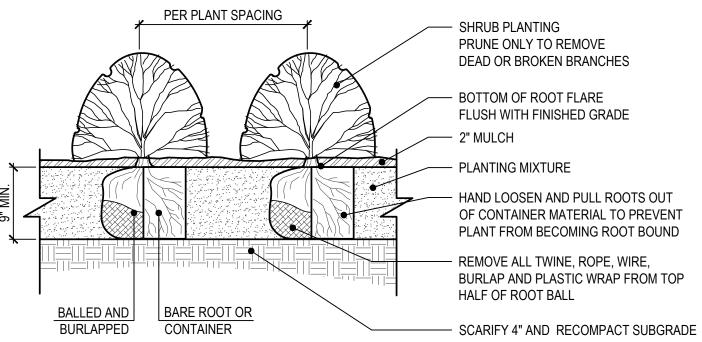

? SHRUB PLANTING SCALE: 1" = 1'-0"

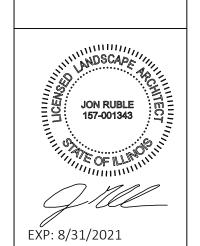

≫Horn

Kimley


LANDSCAPE **DETAILS**

AK CRY GW

ORIGINAL ISSUE: 5/18/2021 KHA PROJECT NO. 168726001 SHEET NUMBER

L201

PLANNED ENVIRONMENT ASSOCIATES P.O. BOX 2256 CHESTERTON, IN 46304

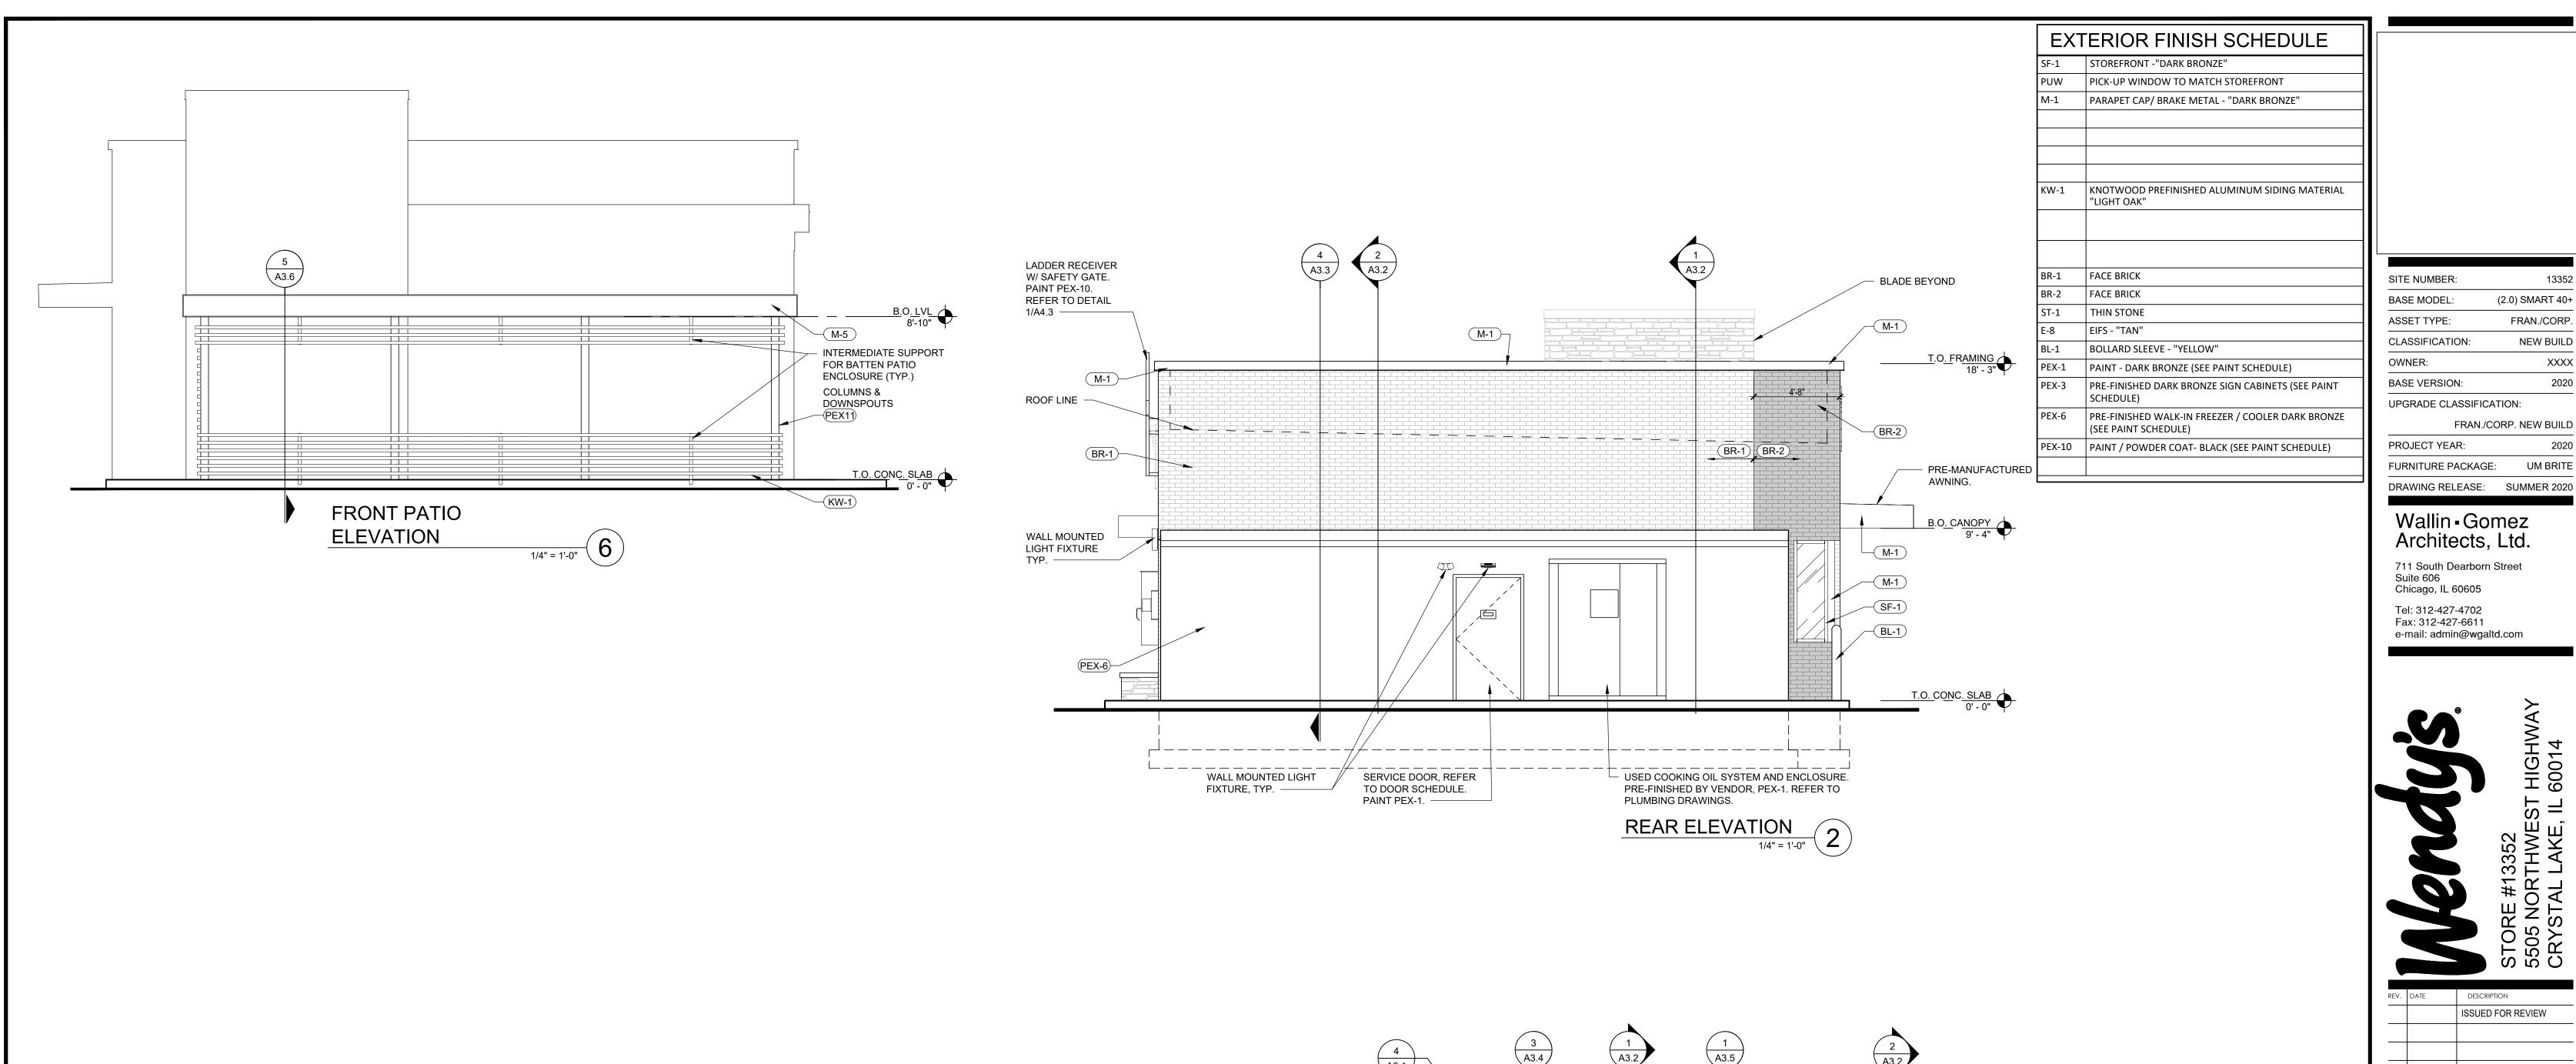

NOT USED

WIRING HOLE PLACEMENT DIAGRAM

13352

XXXX

2020

2020

UM BRITE

(2.0) SMART 40+

FRAN./CORP.

FRAN./CORP. NEW BUILD

NEW BUILD

ISSUED FOR REVIEW

PLOT DATE 6/21/2021 PROJECT NUMBER 20XXX DRAWN BY CL CHECKED BY DJW


GOMEZ ARCHITECTS, LTD.


PROPRIETARY INFORMATION. IT SHALL NOT BE USED OR REPRODUCED OR ITS CONTENTS DISCLOSED, IN WHOLE OR IN PART WITHOUT THE PRIOR WRITTEN CONSENT OF WALLIN /

THESE DRAWINGS HAVE BEEN PREPARED AT AND / OR UNDER MY SUPERVISION AND TO THE BEST OF MY KNOWLEDGE AND BELIEF CONFORM AND COMPLY WITH THE REQUIREMENTS OF THE DEPARTMENT OF BUILDING AND CODES HAVING JURISDICTION.

STATE OF ILLINOIS #001.010990 REGISTERED ARCHITECT DONALD J. WALLIN EXPIRATION DATE: 11/30/2022

EXTERIOR ELEVATIONS

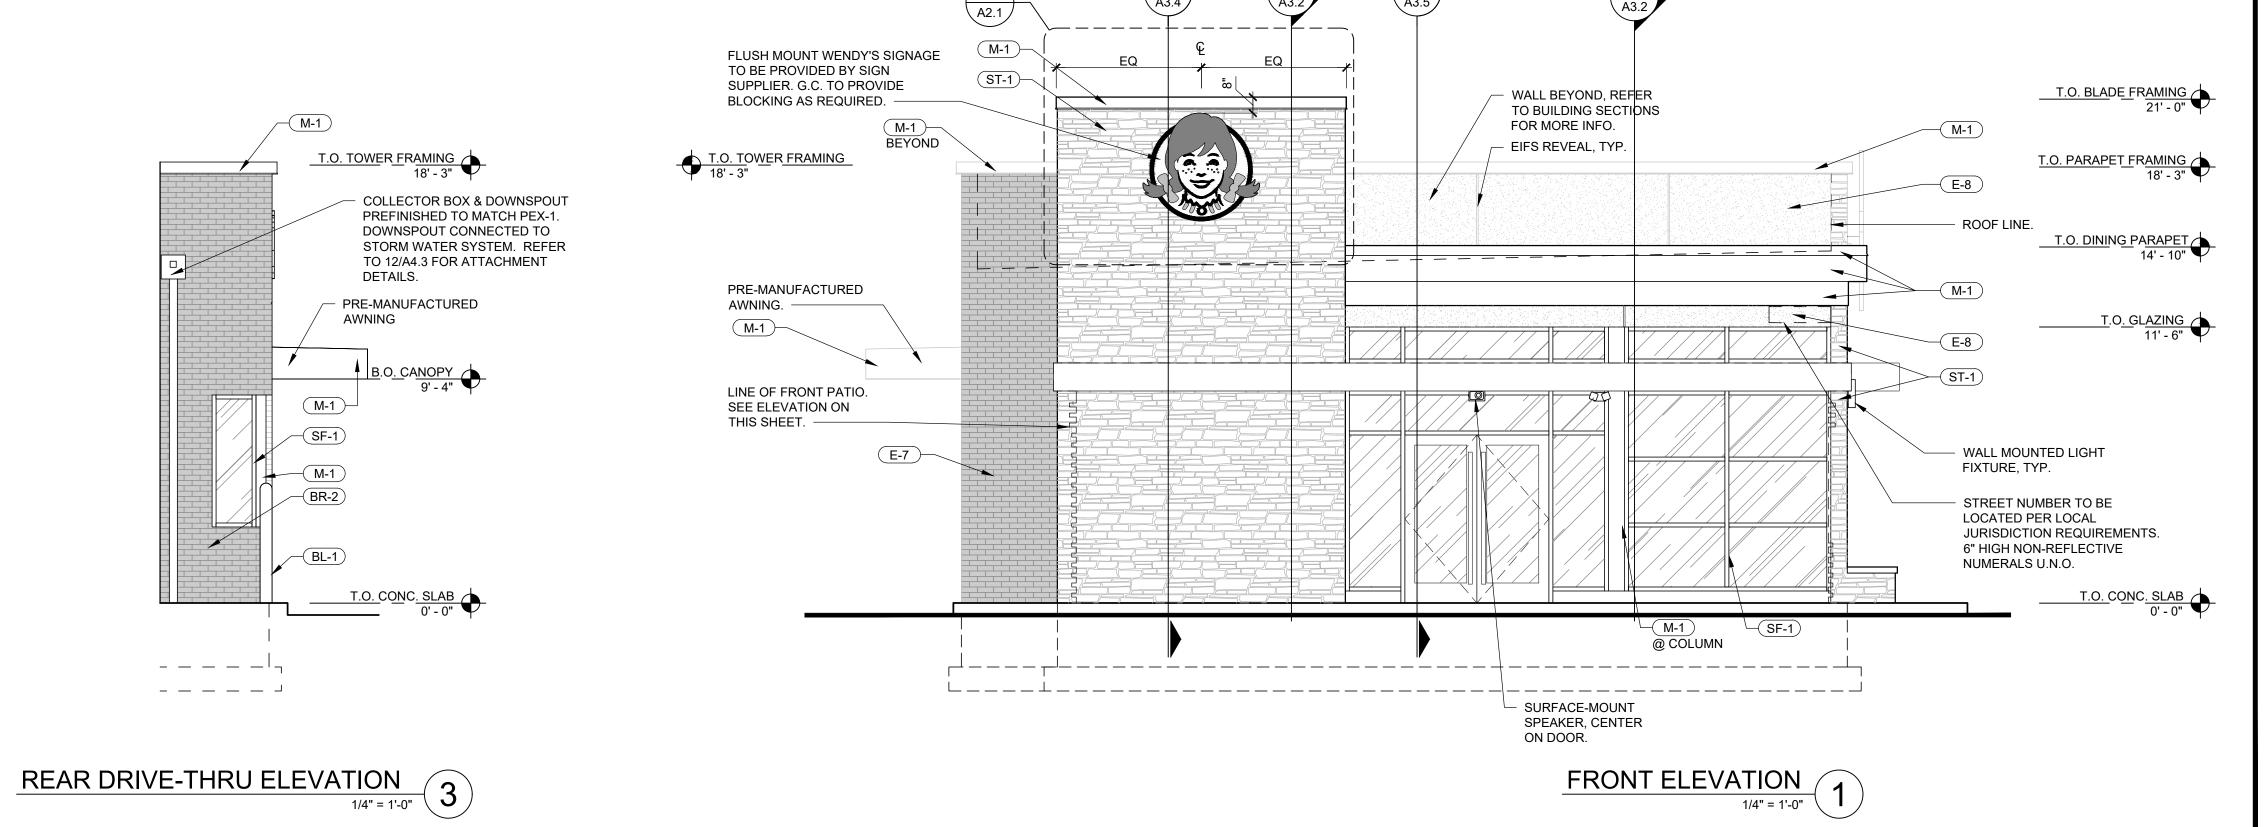

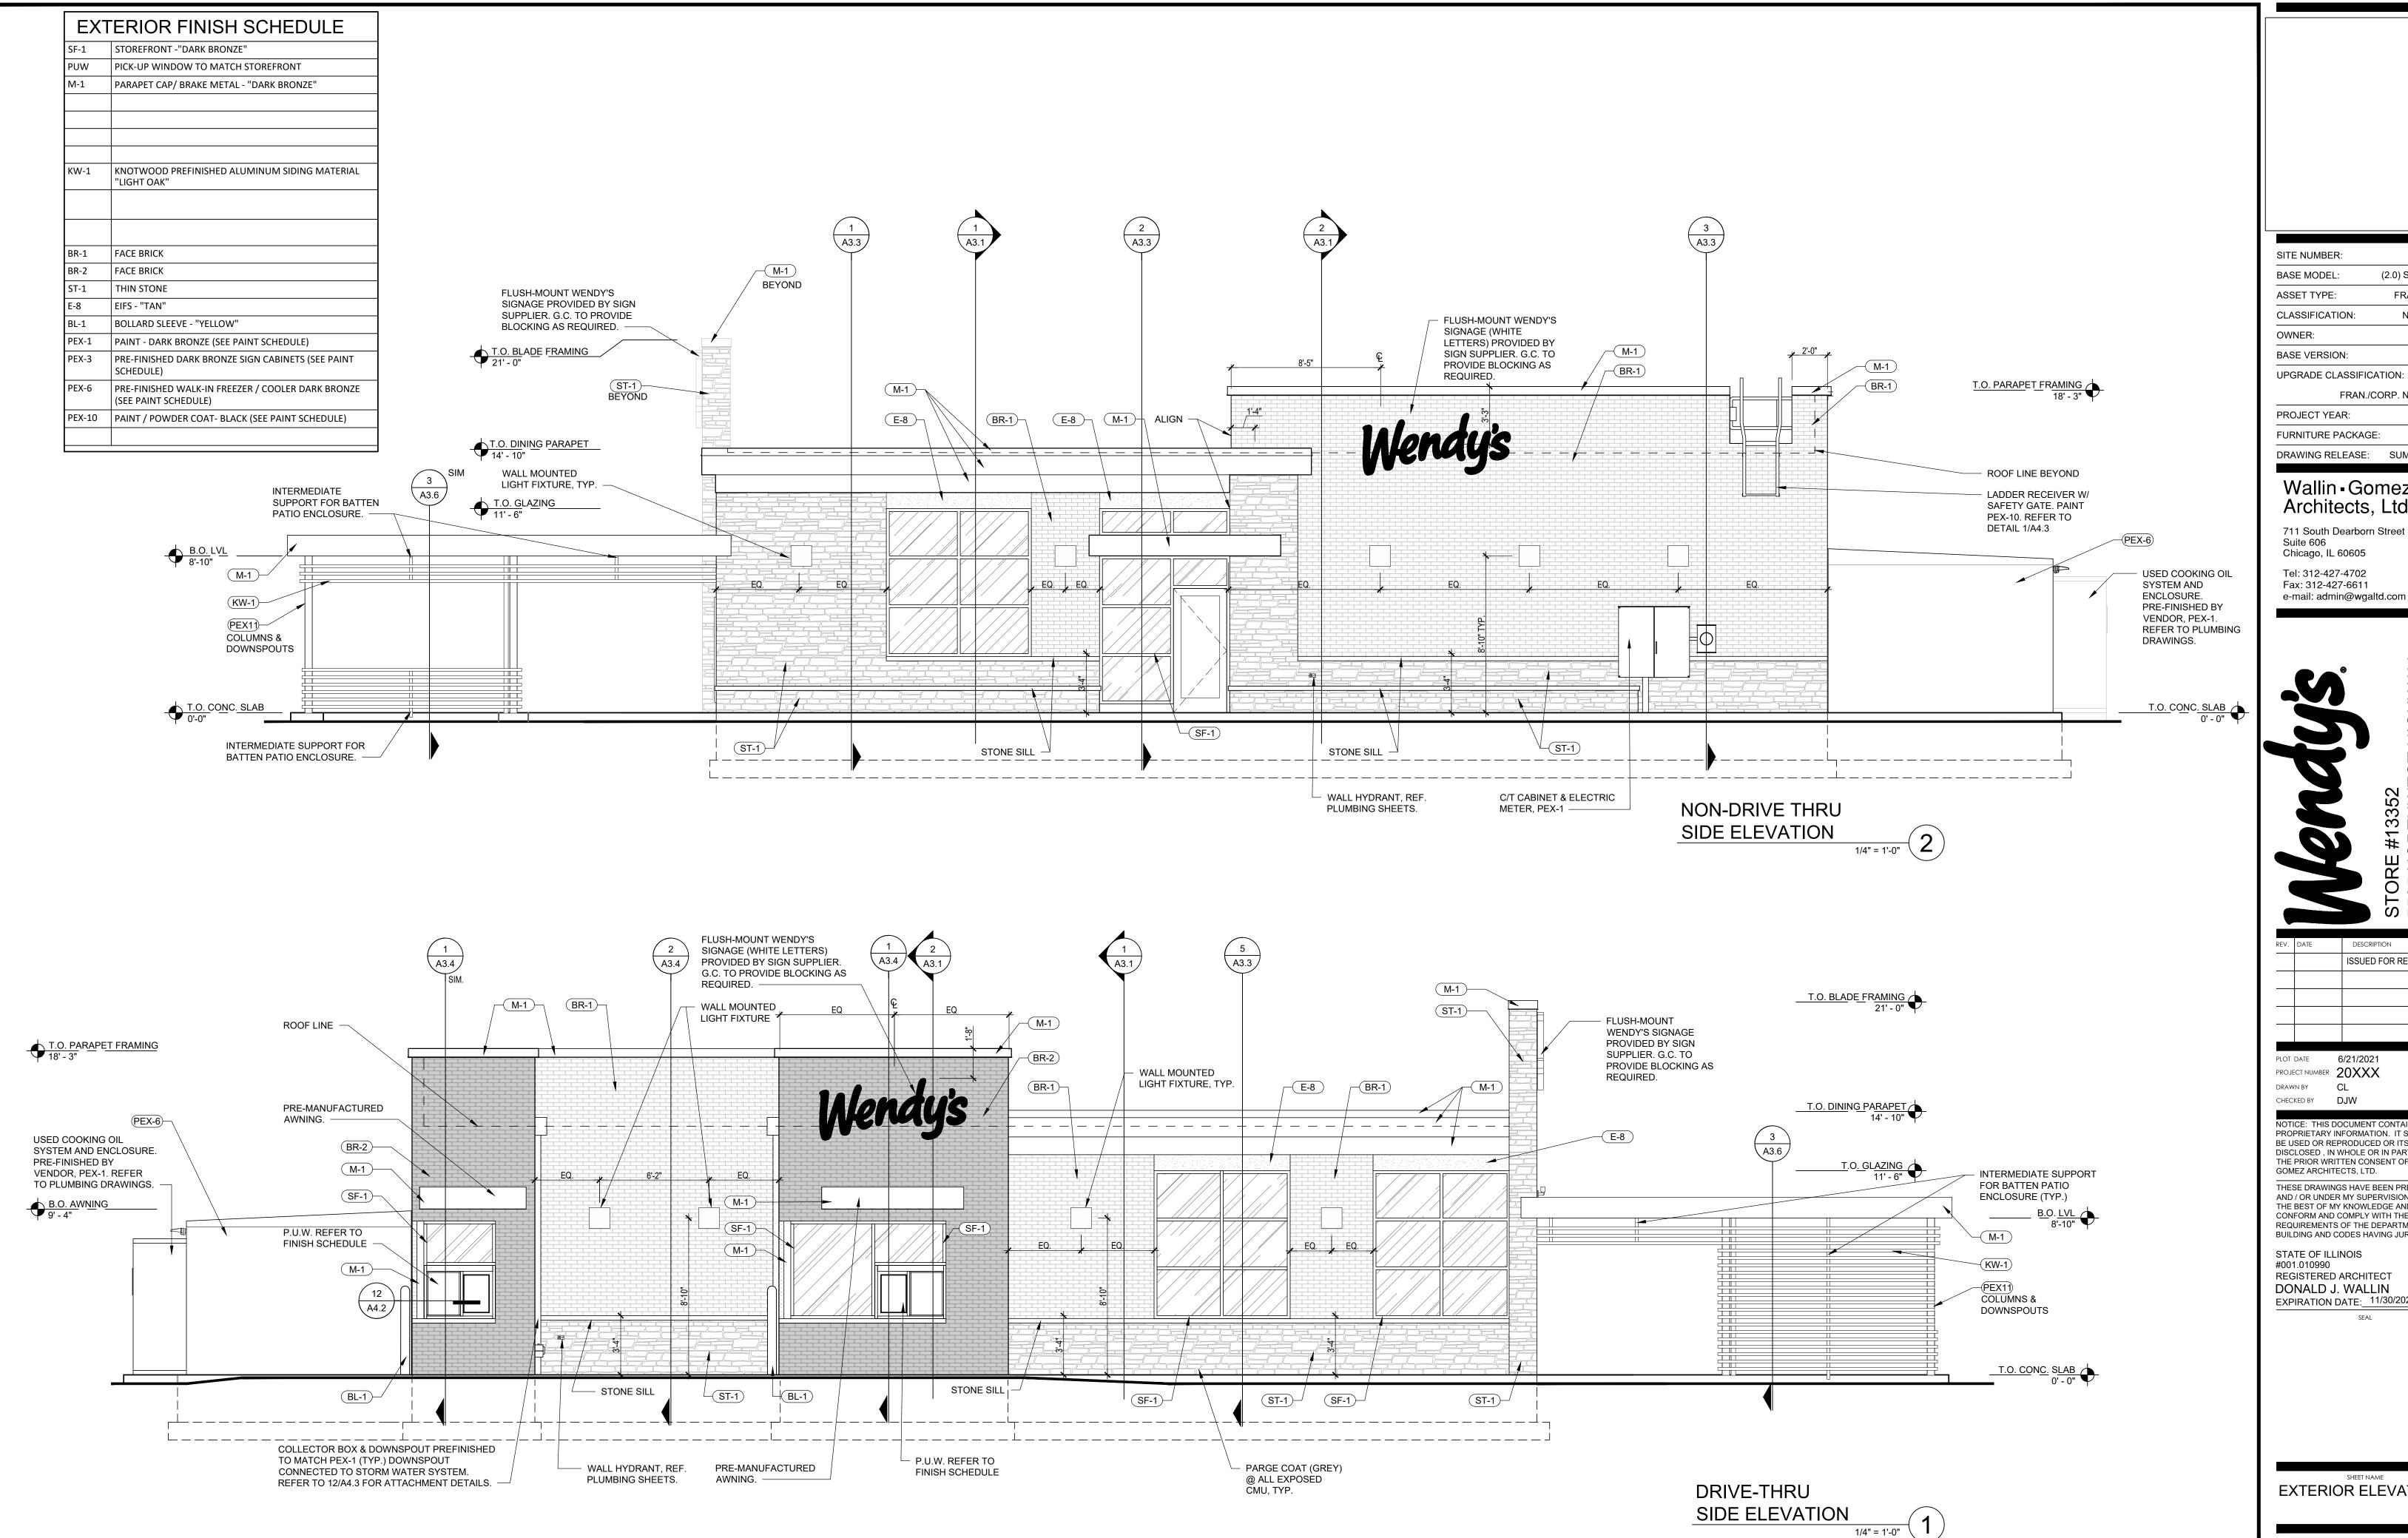


13352 SITE NUMBER: BASE MODEL: (2.0) SMART 40+ ASSET TYPE: FRAN./CORP. CLASSIFICATION: NEW BUILD OWNER: XXXX BASE VERSION: 2020 UPGRADE CLASSIFICATION: FRAN./CORP. NEW BUILD PROJECT YEAR: 2020

FURNITURE PACKAGE: UM BRITE DRAWING RELEASE: SUMMER 2020

Wallin - Gomez Architects, Ltd.

Suite 606 Chicago, IL 60605 Tel: 312-427-4702 Fax: 312-427-6611

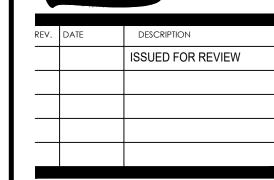

PLOT DATE 6/21/2021 PROJECT NUMBER 20XXX DRAWN BY CL CHECKED BY DJW

PROPRIETARY INFORMATION. IT SHALL NOT BE USED OR REPRODUCED OR ITS CONTENTS DISCLOSED , IN WHOLE OR IN PART WITHOUT THE PRIOR WRITTEN CONSENT OF WALLIN / GOMEZ ARCHITECTS, LTD.

THESE DRAWINGS HAVE BEEN PREPARED AT AND / OR UNDER MY SUPERVISION AND TO THE BEST OF MY KNOWLEDGE AND BELIEF CONFORM AND COMPLY WITH THE REQUIREMENTS OF THE DEPARTMENT OF BUILDING AND CODES HAVING JURISDICTION.

STATE OF ILLINOIS #001.010990 REGISTERED ARCHITECT DONALD J. WALLIN EXPIRATION DATE: 11/30/2022

EXTERIOR ELEVATIONS

SIGN PACKAGE REV 0





Wendy's Site #13352

5505 Northwest Hwy Crystal Lake, IL 60014

APPROVAL:	
DATE:	


REV #	REV. DESCRIPTION HISTORY	SALES REP.	DESIGNER	DATE
0	WEN 00970 6116 Northwest Hwy Rev 0	Michael A.	MDA	4/27/21

NON-STANDARD MONUMENT OPTION A

Monument Sign Materials and Specifications

SCHEDULE OF EXTERIOR MATERIALS

MATERIALS	MANUFACTURER	MODEL NO.	COLOR	FINISH	DESCRIPTION
Brick Veneer	ACME	KING	Alpine: 763641	Heritage	MANUFACTURER: ACME, MODEL: KING, COLOR APLINE, FINISH: HERITAGE, ITEM # 763641 - MORTAR: SOLOMON COLORS, INC. 10X LIGHT BUFF. MORTAR JOINT PROFILE: WEATHER-STRUCK. 1/2 RUNNING BOND, REFER TO DETAIL.

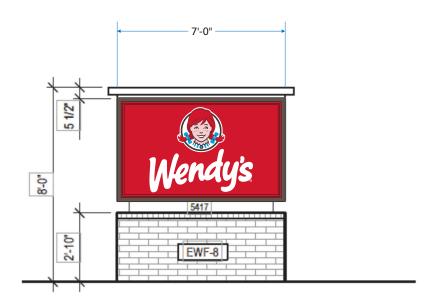



MONUMENT SIGN ELEVATION


SCALE: 1/4" = 1'-0"



ALL WIRING MEETS NEC 2017 SPECIFICATIONS. SIGN TO BE WIRED TO A STANDARD 120 VOLT / 20 AMP CIRCUIT. SIGN IS A U.L. LABELED PRODUCT

US THIS SIGN IS INTENDED TO BE INSTALLED IN ACCORDANCE WITH THE REQUIREMENTS OF ARTICLE 600 OF THE NATIONAL ELECTRICAL CODE AND/OR OTHER APPLICABLE LOCAL CODES. THIS INCLUDES PROPER GROUNDING AND BONDING OF THE SIGN.

SIGN TYPE SPECIFICATIONS	COLORS	SIGN SURVEY	ARTWORK			
- REPLACEMENT FACES: .150 PAN FORMED SOLAR GR. DOUBLE FACE POLYCARBONATE FACES WITH FLAT DECORATED GRA GROUND	CLASSIC DITORAL	☐ FACE TRIMS ☐ FASCIA COLOR ☐ RADIUS DIM. ☐ BUILDING DIM. ☐ FACADE ANGLE ☐ OTHER	✓ PROVIDED ☐ REQUIRED If required, customer to provide Custom Sign Center, Inc. With camera ready or appropriate digital file. Please contact your salesperson or Design Staff for appropriate file types.	3200 Valleyv	custom Full SIGN Center	Inc. Columbus, OH 43204
all s	proval Signatures Required to insur pelling, colors, and specifications for sidered meets customer & landlord appropriate the second sec	ign(s)	DATE: DATE:	Custom Sign Co	esign and all information herein a enter, Inc. Artwork is subject to re	
	<u> </u>				<u> </u>	

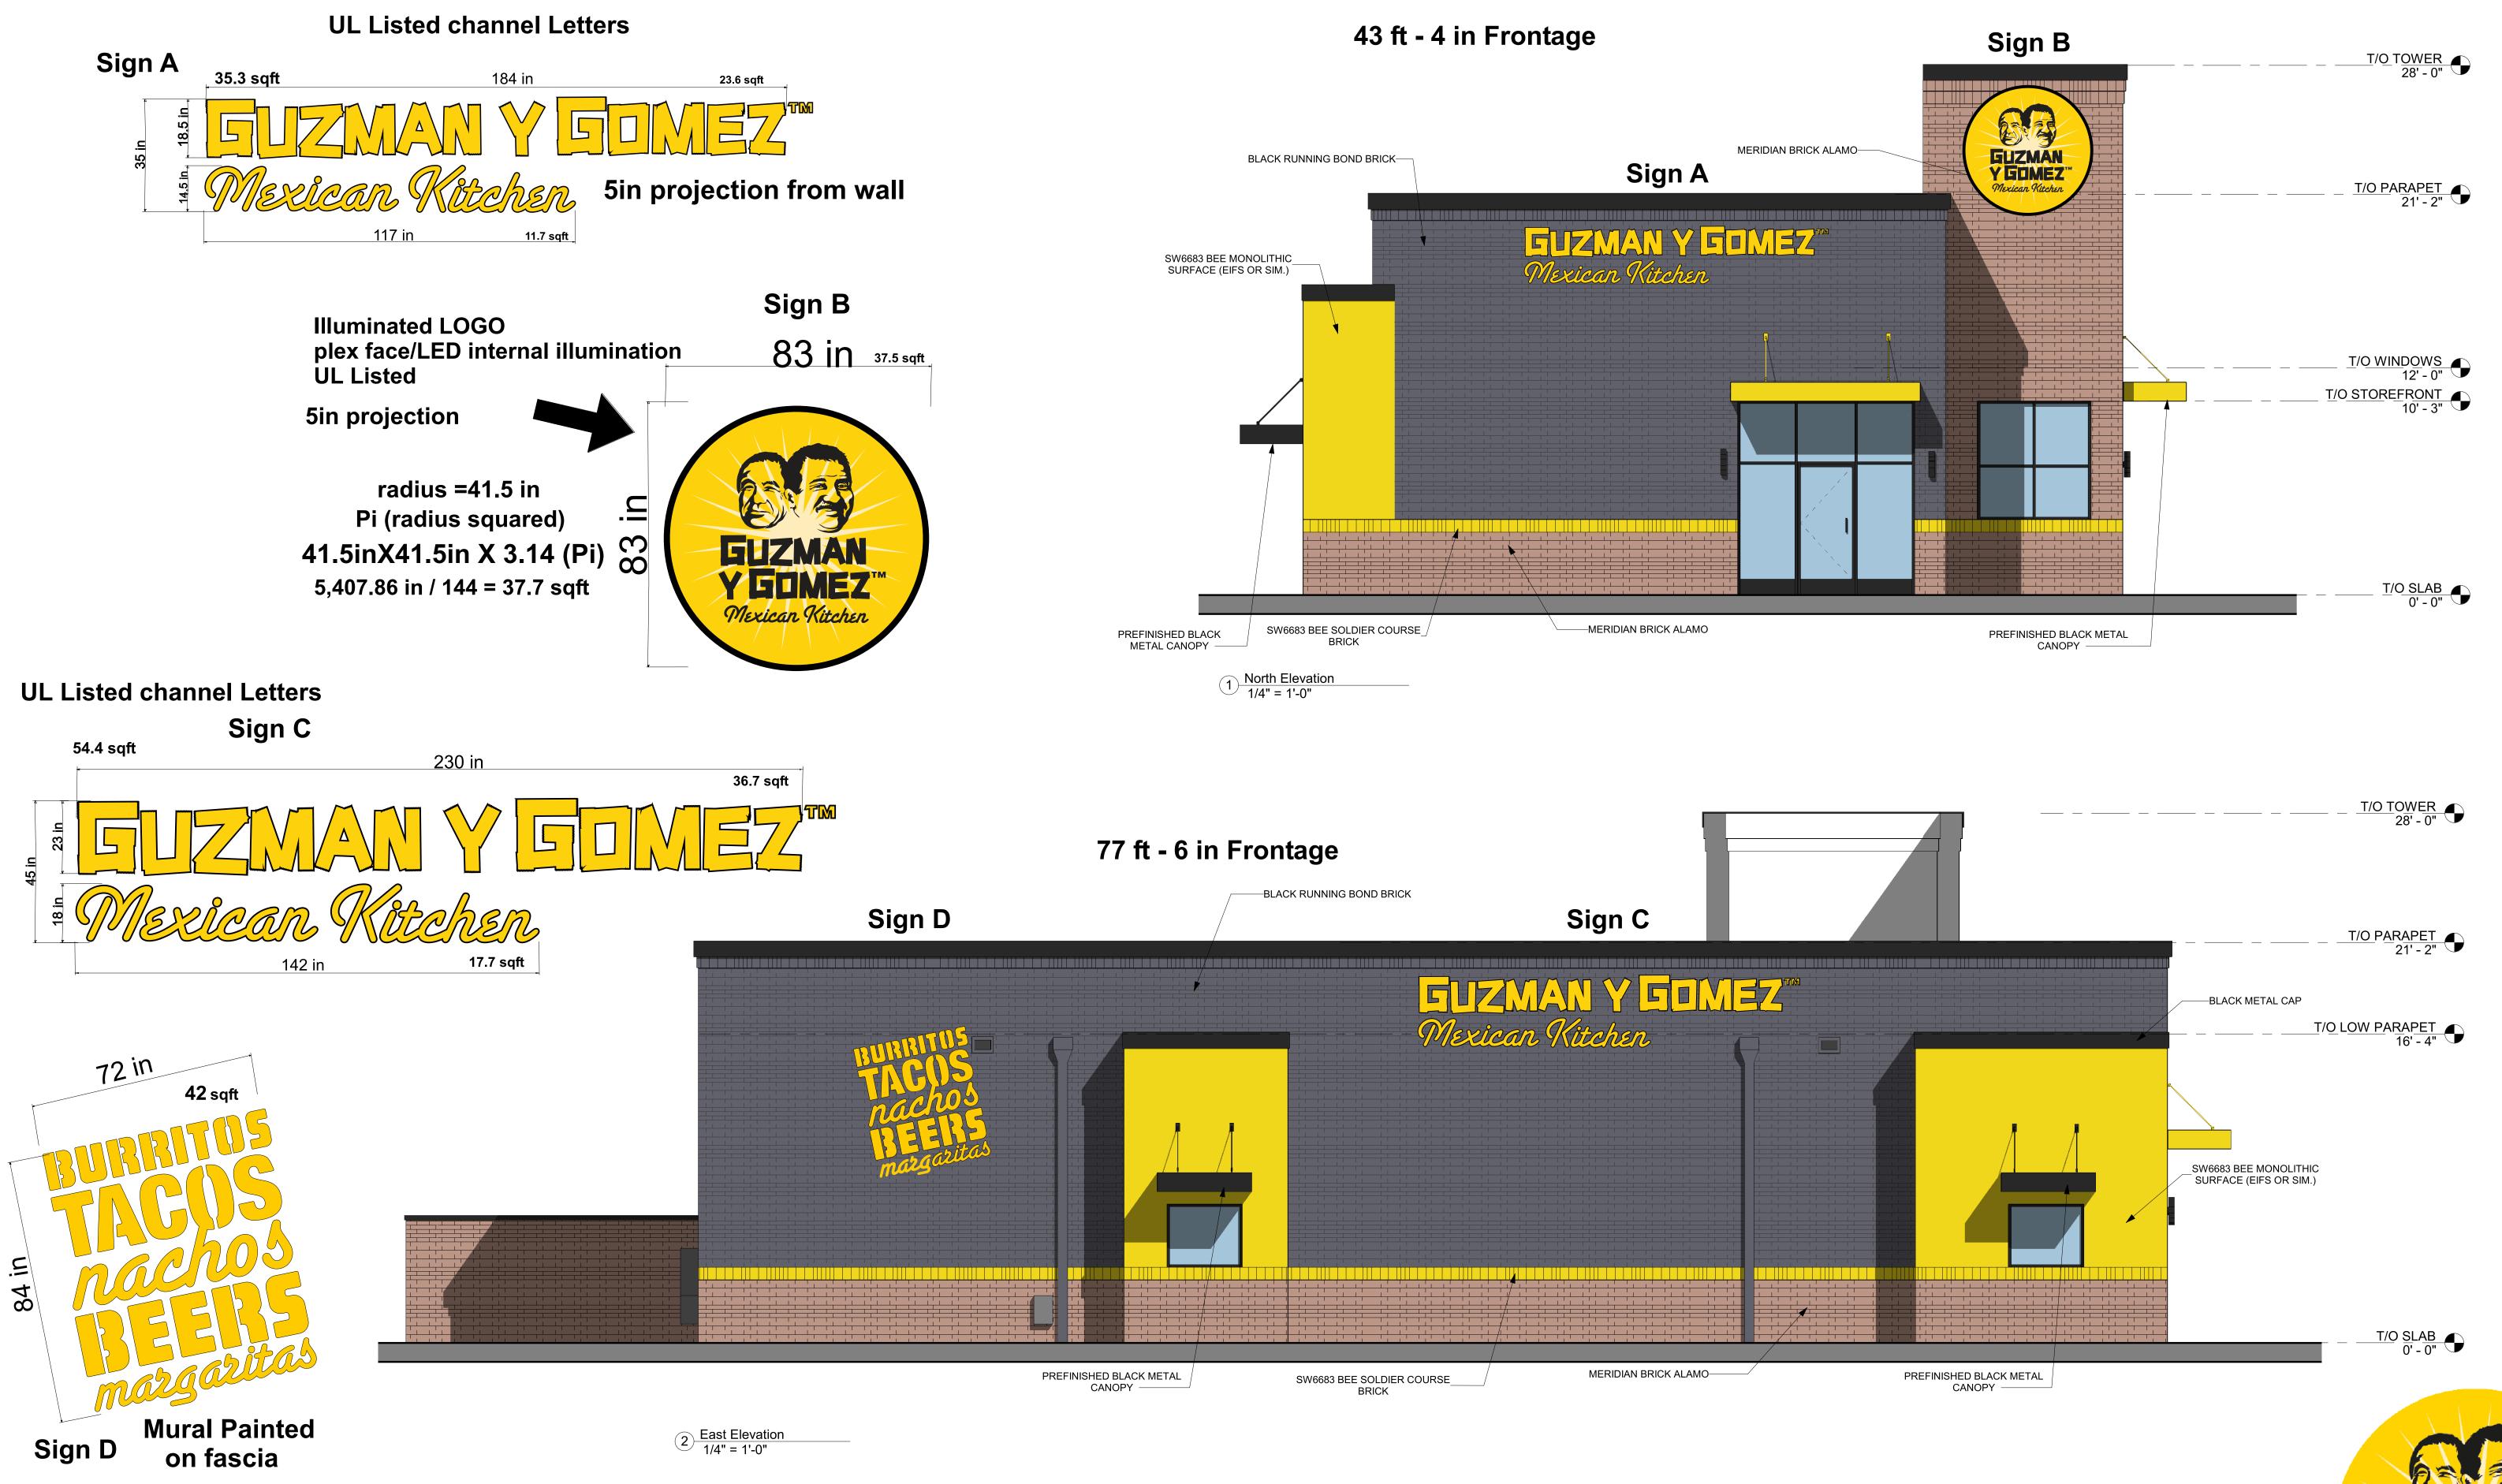





COMET NEON INC.
DBA CN SIGN AND AWNING
O: 630- 656-1085
F: 630-668-9335
WWW.COMETNEON.COM
1120 N. RIDGE AVE. LOMBARD IL 60148.




5417-5501 NORTHWEST HWY CRYSTAL LAKE, IL 60014 06.07.21




Removed from plan Sign E


UL Listed channel Letters



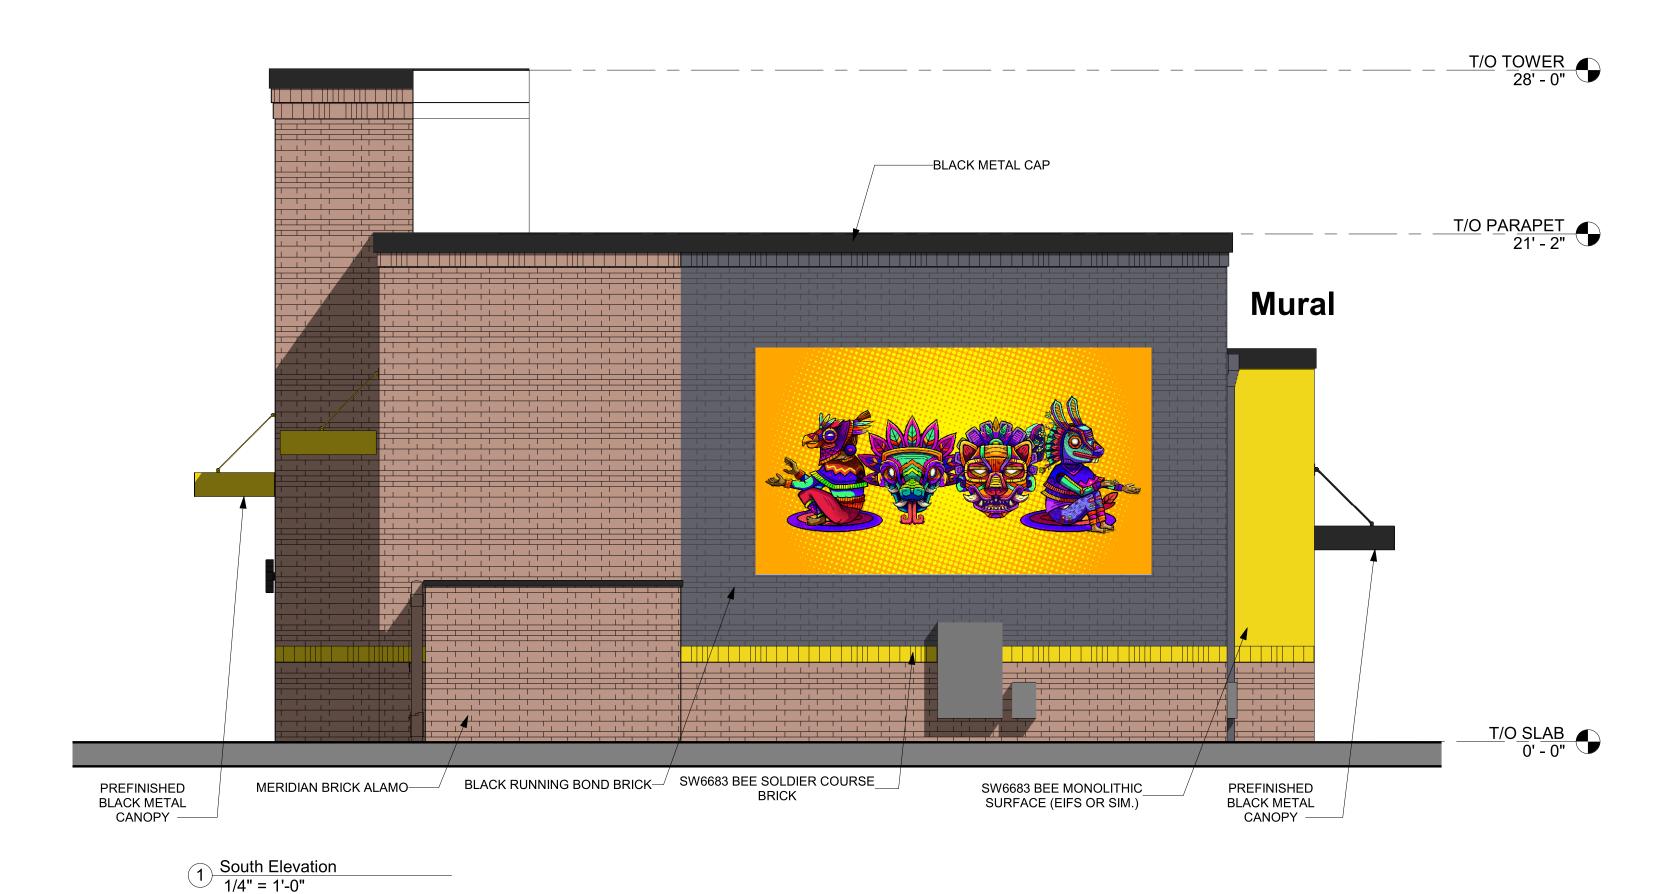

Sign F

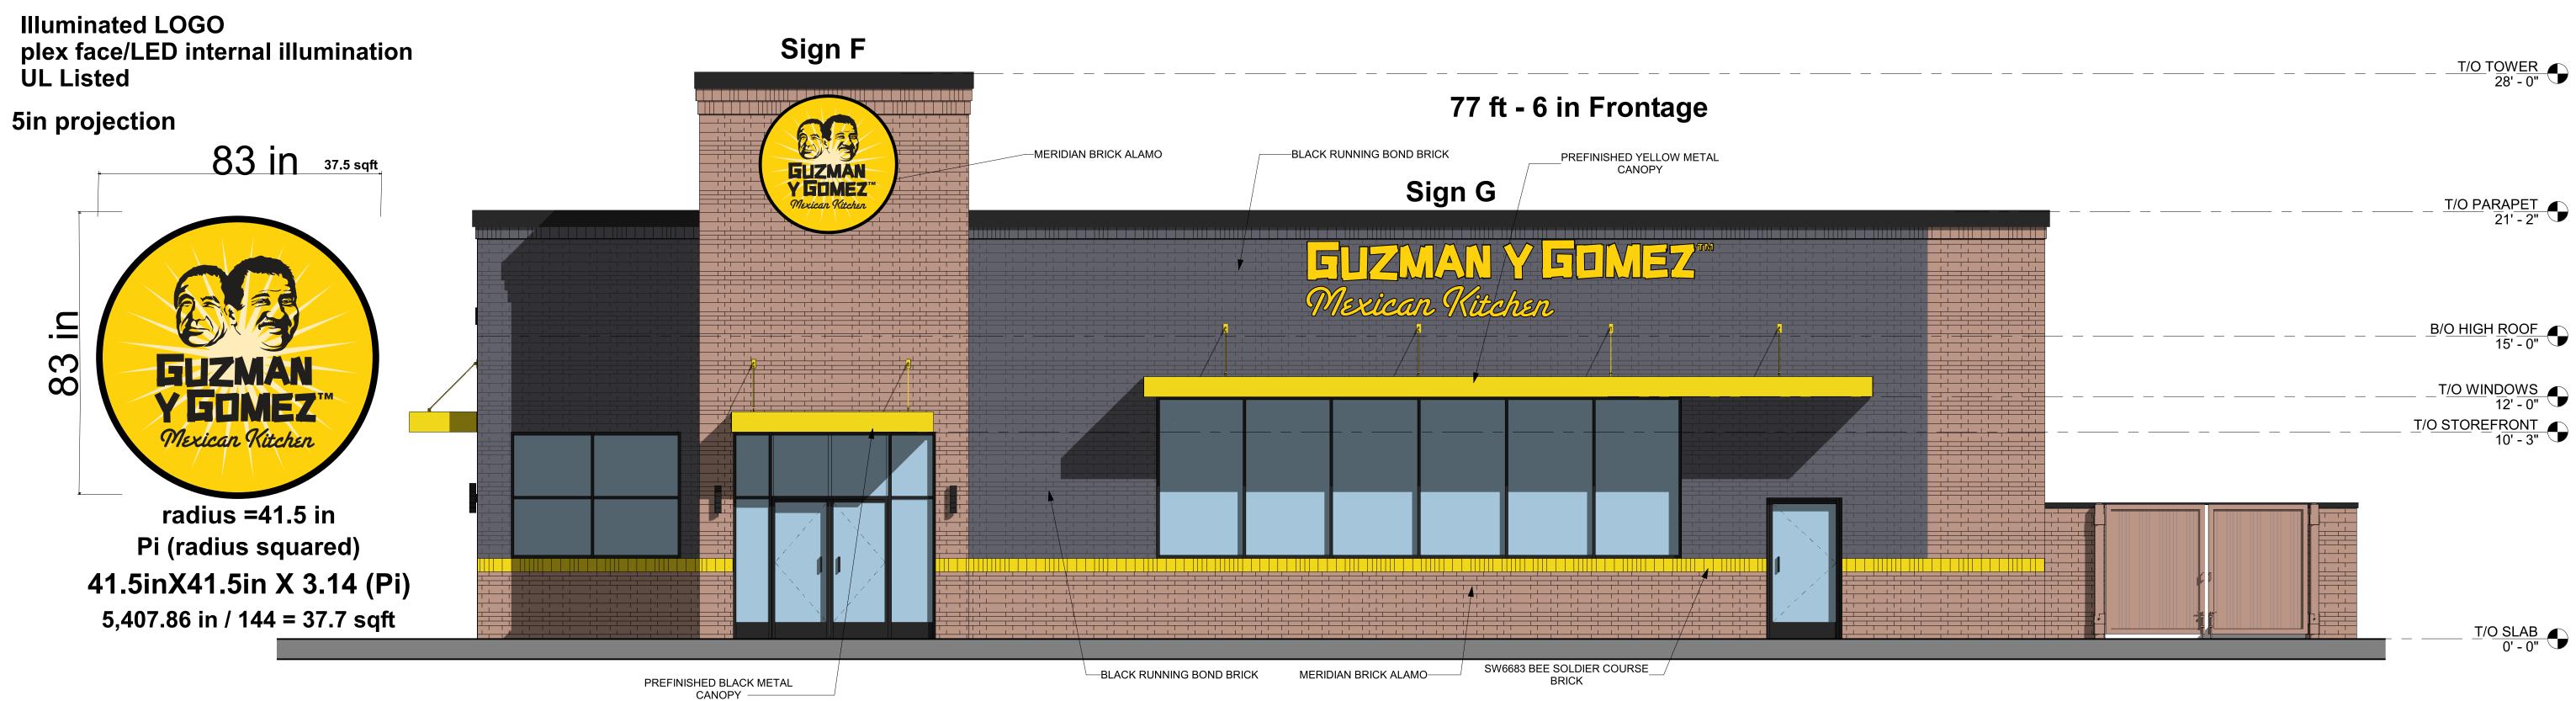

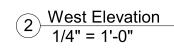







COMET NEON INC.
DBA CN SIGN AND AWNING
O: 630- 656-1085
F: 630-668-9335
WWW.COMETNEON.COM
1120 N. RIDGE AVE. LOMBARD IL 60148.



5417-5501 NORTHWEST HWY CRYSTAL LAKE, IL 60014 06.07.21



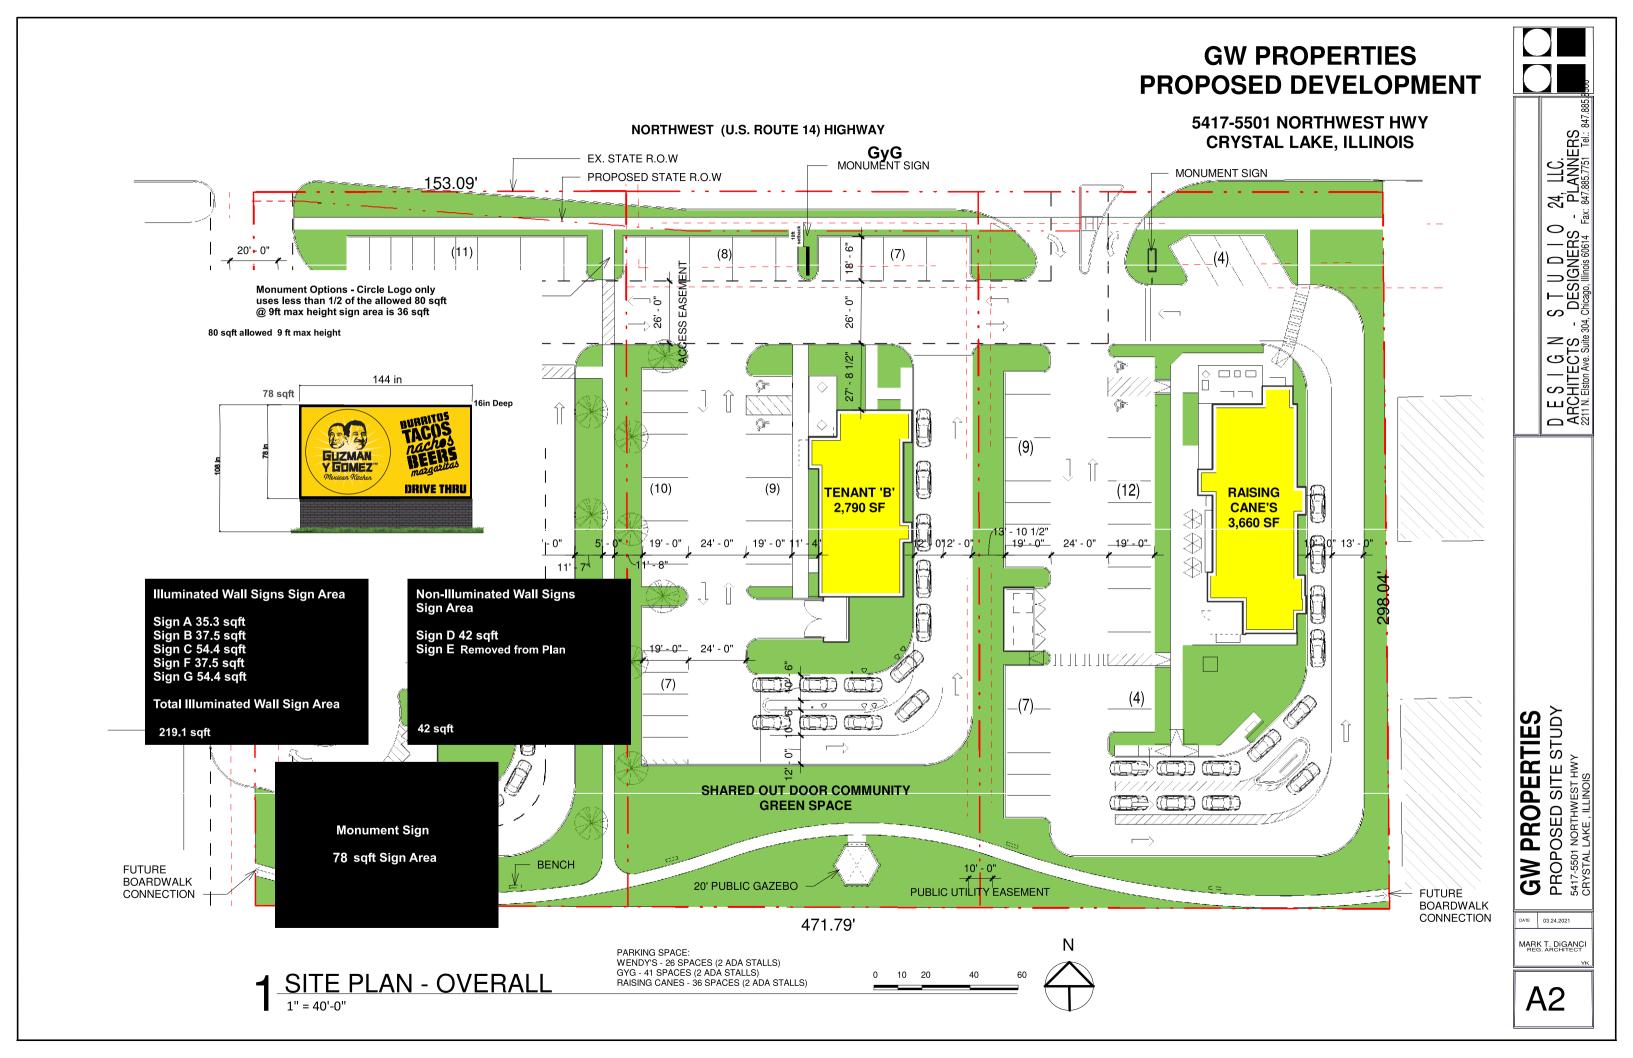

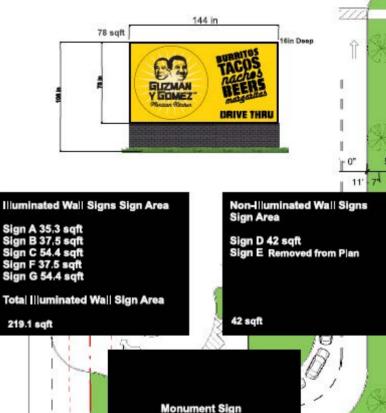

FUTURE BOARDWALK CONNECTION 78 sqft Sign Area

BENCH

PRELIMINARY ENGINEERING PLANS GW CRYSTAL LAKE



5417 NORTHWEST HIGHWAY CRYSTAL LAKE, IL 60014

UTILITY AND GOVERNING AGENCY CONTACTS

ENGINEERING DEPARTMENT CITY OF CRYSTAL LAKE 100 WEST WOODSTOCK STREET CRYSTAL LAKE, IL 60014 TEL: (815) 356-3614 CONTACT: KEVIN LILL

SANITARY SEWER SERVICE CITY OF CRYSTAL LAKE 100 WEST WOODSTOCK STREET CRYSTAL LAKE, IL 60014 TEL: (815) 356-3797 CONTACT: TBD

STORM SEWER SERVICE CITY OF CRYSTAL LAKE 100 WEST WOODSTOCK STREET CRYSTAL LAKE, IL 60014 TEL: (815) 356-3797 CONTACT: ABIGAIL WILGREEN

SCHAUMBURG, IL 60196 TEL: (847) 705-4145 CONTACT: YELEINA I. HAYDEL POWER COMPANY COMED

ILLINOIS DEPARTMENT OF TRANSPORTATION

350 S SECOND STREET ELGIN, IL 60123 TEL: (847) 608-2382 CONTACT: JOSE "JAYVEE" ROLDAN III

NATURAL GAS COMPANY NICOR GAS TEL: (847) 598-4011 CONTACT: FORAM SHAH

ROADWAY AUTHORITY

201 WEST CENTER COURT

<u>TELEPHONE</u>

TEL: (815) 337-4732 CONTACT: DAVID SAINT GERMAIN

PROJECT TEAM


<u>DEVELOPER</u> GW PROPERTIES 2211 N ELSTON AVE, SUITE 304 CHICAGO, IL 60614 TEL: (773) 382-0590 CONTACT: MITCH GOLTZ

KIMLEY-HORN AND ASSOCIATES, INC. 4201 WINFIELD ROAD, SUITE 600 WARRENVILLE, IL 60555 TEL: (630) 487-5550 EMAIL: ERIC.TRACY@KIMLEY-HORN.COM

LANDSCAPE ARCHITECT PLANNED ENVIRONMENT ASSOCIATES P.O BOX 2256 CHESTERTON, IN 46304 TEL: (219) 299-3383 CONTACT: JON RUBLE, P.L.A.

CONTACT: ERIC TRACY, P.E.

<u>SURVEYOR</u> UNITED SURVEY SERVICE, LLC 7710 CENTRAL AVENUE RIVER FOREST, IL 60305 TEL: (847) 299-1010 E-MAIL: USURVEY@USANDCS.COM

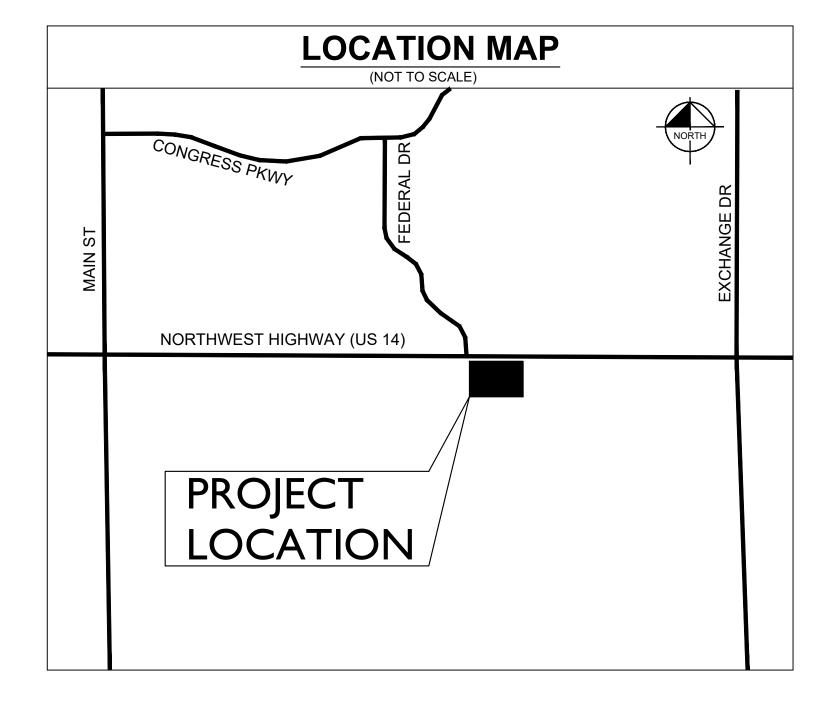

	Sheet List Table
Sheet Number	Sheet Title
C0.0	TITLE SHEET
V0.0	SURVEY (BY OTHERS)
C1.0	GENERAL NOTES
C1.1	CITY STANDARD NOTES
C2.0	EXISTING CONDITIONS & DEMO PLAN
C3.0	SITE PLAN
C4.0	EROSION CONTROL PLAN
C4.1	EROSION CONTROL NOTES & DETAILS
C5.0	GRADING PLAN
C6.0	UTILITY PLAN
C7.0	CONSTRUCTION DETAILS
C7.1	CONSTRUCTION DETAILS

LEGAL DESCRIPTION

LOT 1 IN PAULY SUBDIVISION, BEING A SUBDIVISION OF PART OF THE NORTHWEST QUARTER OF SECTION 9, TOWNSHIP 43 NORTH, RANGE 8 EAST OF THE THIRD PRINCIPAL MERIDIAN, ACCORDING TO THE PLAT THEREOF RECORDED OCTOBER 7, 2008 AS DOCUMENT 2008R0052561, IN THE CITY OF CRYSTAL LAKE, IN MCHENRY COUNTY, ILLINOIS.

PARCEL 2:

LOT 2 IN PAULY SUBDIVISION, BEING A SUBDIVISION OF PART OF THE NORTHEAST QUARTER OF SECTION 9, TOWNSHIP 43 NORTH, RANGE 8 EAST OF THE THIRD PRINCIPAL MERIDIAN, ACCORDING TO THE PLAT THEREOF RECORDED OCTOBER 7, 2008 AS DOCUMENT 2008R0052561, IN THE CITY OF CRYSTAL LAKE, IN MCHENRY COUNTY, ILLINOIS.

PARCEL 3:

COMMENCING AT THE NORTHWEST CORNER OF THE NORTHEAST 1/4 OF SECTION 9, TOWNSHIP 43 NORTH, RANGE 8 EAST OF THE THIRD PRINCIPAL MERIDIAN, RUNNING THEN EAST ALONG THE NORTH LINE OF SAID NORTHEAST 1/4, 410 FEET FOR THE PLACE OF BEGINNING; THENCE SOUTH PARALLEL TO THE WEST LINE OF SAID NORTHEAST 1/4, 330 FEET TO A POINT; THENCE EAST PARALLEL TO THE NORTH LINE OF SAID NORTHEAST 1/4, 155 FEET TO A POINT; THENCE NORTH PARALLEL TO THE WEST LINE OF SAID NORTHEAST 1/4, 330 FEET TO A POINT ON THE NORTH LINE OF SAID NORTHEAST 1/4; THENCE WEST ALONG SAID NORTH LINE 155 FEET TO THE PLACE OF BEGINNING (EXCEPTING AND RESERVING THEREFROM THAT PART OF LAND DEDICATED FOR STATE HIGHWAY PURPOSES), IN MCHENRY COUNTY, ILLINOIS ALSO EXCEPTING THEREFROM: THAT PART OF THE NORTHEAST 1/4 OF SECTION 9, TOWNSHIP 43 NORTH, RANGE 8 EAST OF THE THIRD PRINCIPAL MERIDIAN, DESCRIBED AS FOLLOWS: COMMENCING AT THE NORTHWEST CORNER OF THE NORTHEAST 1/4 OF SECTION 9, RUNNING THENCE EAST ALONG THE NORTH LINE OF SAID NORTHEAST 1/4, ON AN ASSUMED BEARING OF SOUTH 89 DEGREES 59 MINUTES 37 SECONDS EAST, 410 FEET, THENCE SOUTH 02 DEGREES 14 MINUTES 06 SECONDS EAST, PARALLEL TO THE WEST LINE LINE OF SAID NORTHEAST 1/4, 30.02 FEET TO THE PLACE OF BEGINNING, THENCE CONTINUING SOUTH 02 DEGREES 14 MINUTES 06 SECONDS EAST, PARALLEL WITH THE SAID WEST LINE OF SAID NORTHEAST 1/4, A DISTANCE OF 3.30 FEET, THENCE NORTH 89 DEGREES 40 MINUTES 36 SECONDS EAST, A DISTANCE OF 137.10 FEET; THENCE NORTH 89 DEGREES 55 MINUTES 36 SECONDS EAST, 17.87 FEET; THENCE NORTH 02 DEGREES 14 MINUTES 06 SECONDS WEST, 2.48 FEET; THENCE NORTH 89 DEGREES 59 MINUTES 37 SECONDS WEST, A DISTANCE OF 155.00 FEET, TO THE PLACE OF BEGINNING, SITUATED IN MCHENRY COUNTY, ILLINOIS.

BENCHMARKS

<u>SITE BENCHMARKS:</u> (LOCATIONS SHOWN ON SURVEY)

NORTHWEST BONNET BOLT ON FIRE HYDRANT. ELEVATION=913.66 (NAVD 88).

PROFESSIONAL ENGINEER'S CERTIFICATION

, ERIC J. TRACY, A LICENSED PROFESSIONAL ENGINEER OF ILLINOIS, HEREBY CERTIFY THAT THIS SUBMISSION, PERTAINING ONLY TO THE "C" SERIES CIVIL SHEETS LISTED ABOVE, WAS PREPARED ON BEHALF OF GW PROPERTIES BY KIMLEY-HORN AND ASSOCIATES, INC. UNDER MY PERSONAL DIRECTION. THIS TECHNICAL SUBMISSION IS INTENDED TO BE USED AS AN INTEGRAL PART OF AND IN CONJUNCTION WITH THE PROJECT SPECIFICATIONS AND CONTRACT DOCUMENTS.

- 1			
-	DATED THIS	DAY OF	. A.D., 202

ILLINOIS LICENSED PROFESSIONAL ENGINEER 062-067482 MY LICENSE EXPIRES ON NOVEMBER 30, 2021

Kimley » Horn

S


ORIGINAL ISSUE: X/XX/21 KHA PROJECT NO 168726001


SHEET NUMBER

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KEY NOTES

- (1) B6.12 CONCRETE CURB AND GUTTER, TYP. (SEE DETAILS)
- 2 DEPRESSED CURB AND GUTTER
- (3) CONCRETE SIDEWALK, TYP. (SEE DETAILS)
- 4 4" WIDE PAINTED SOLID LINE, TYP.

PAVING AND CURB LEGEND

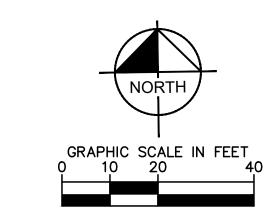STANDARD DUTY ASPHALT PAVEMENT
SEE CONSTRUCTION DETAILS FOR PAVEMENT SECTION

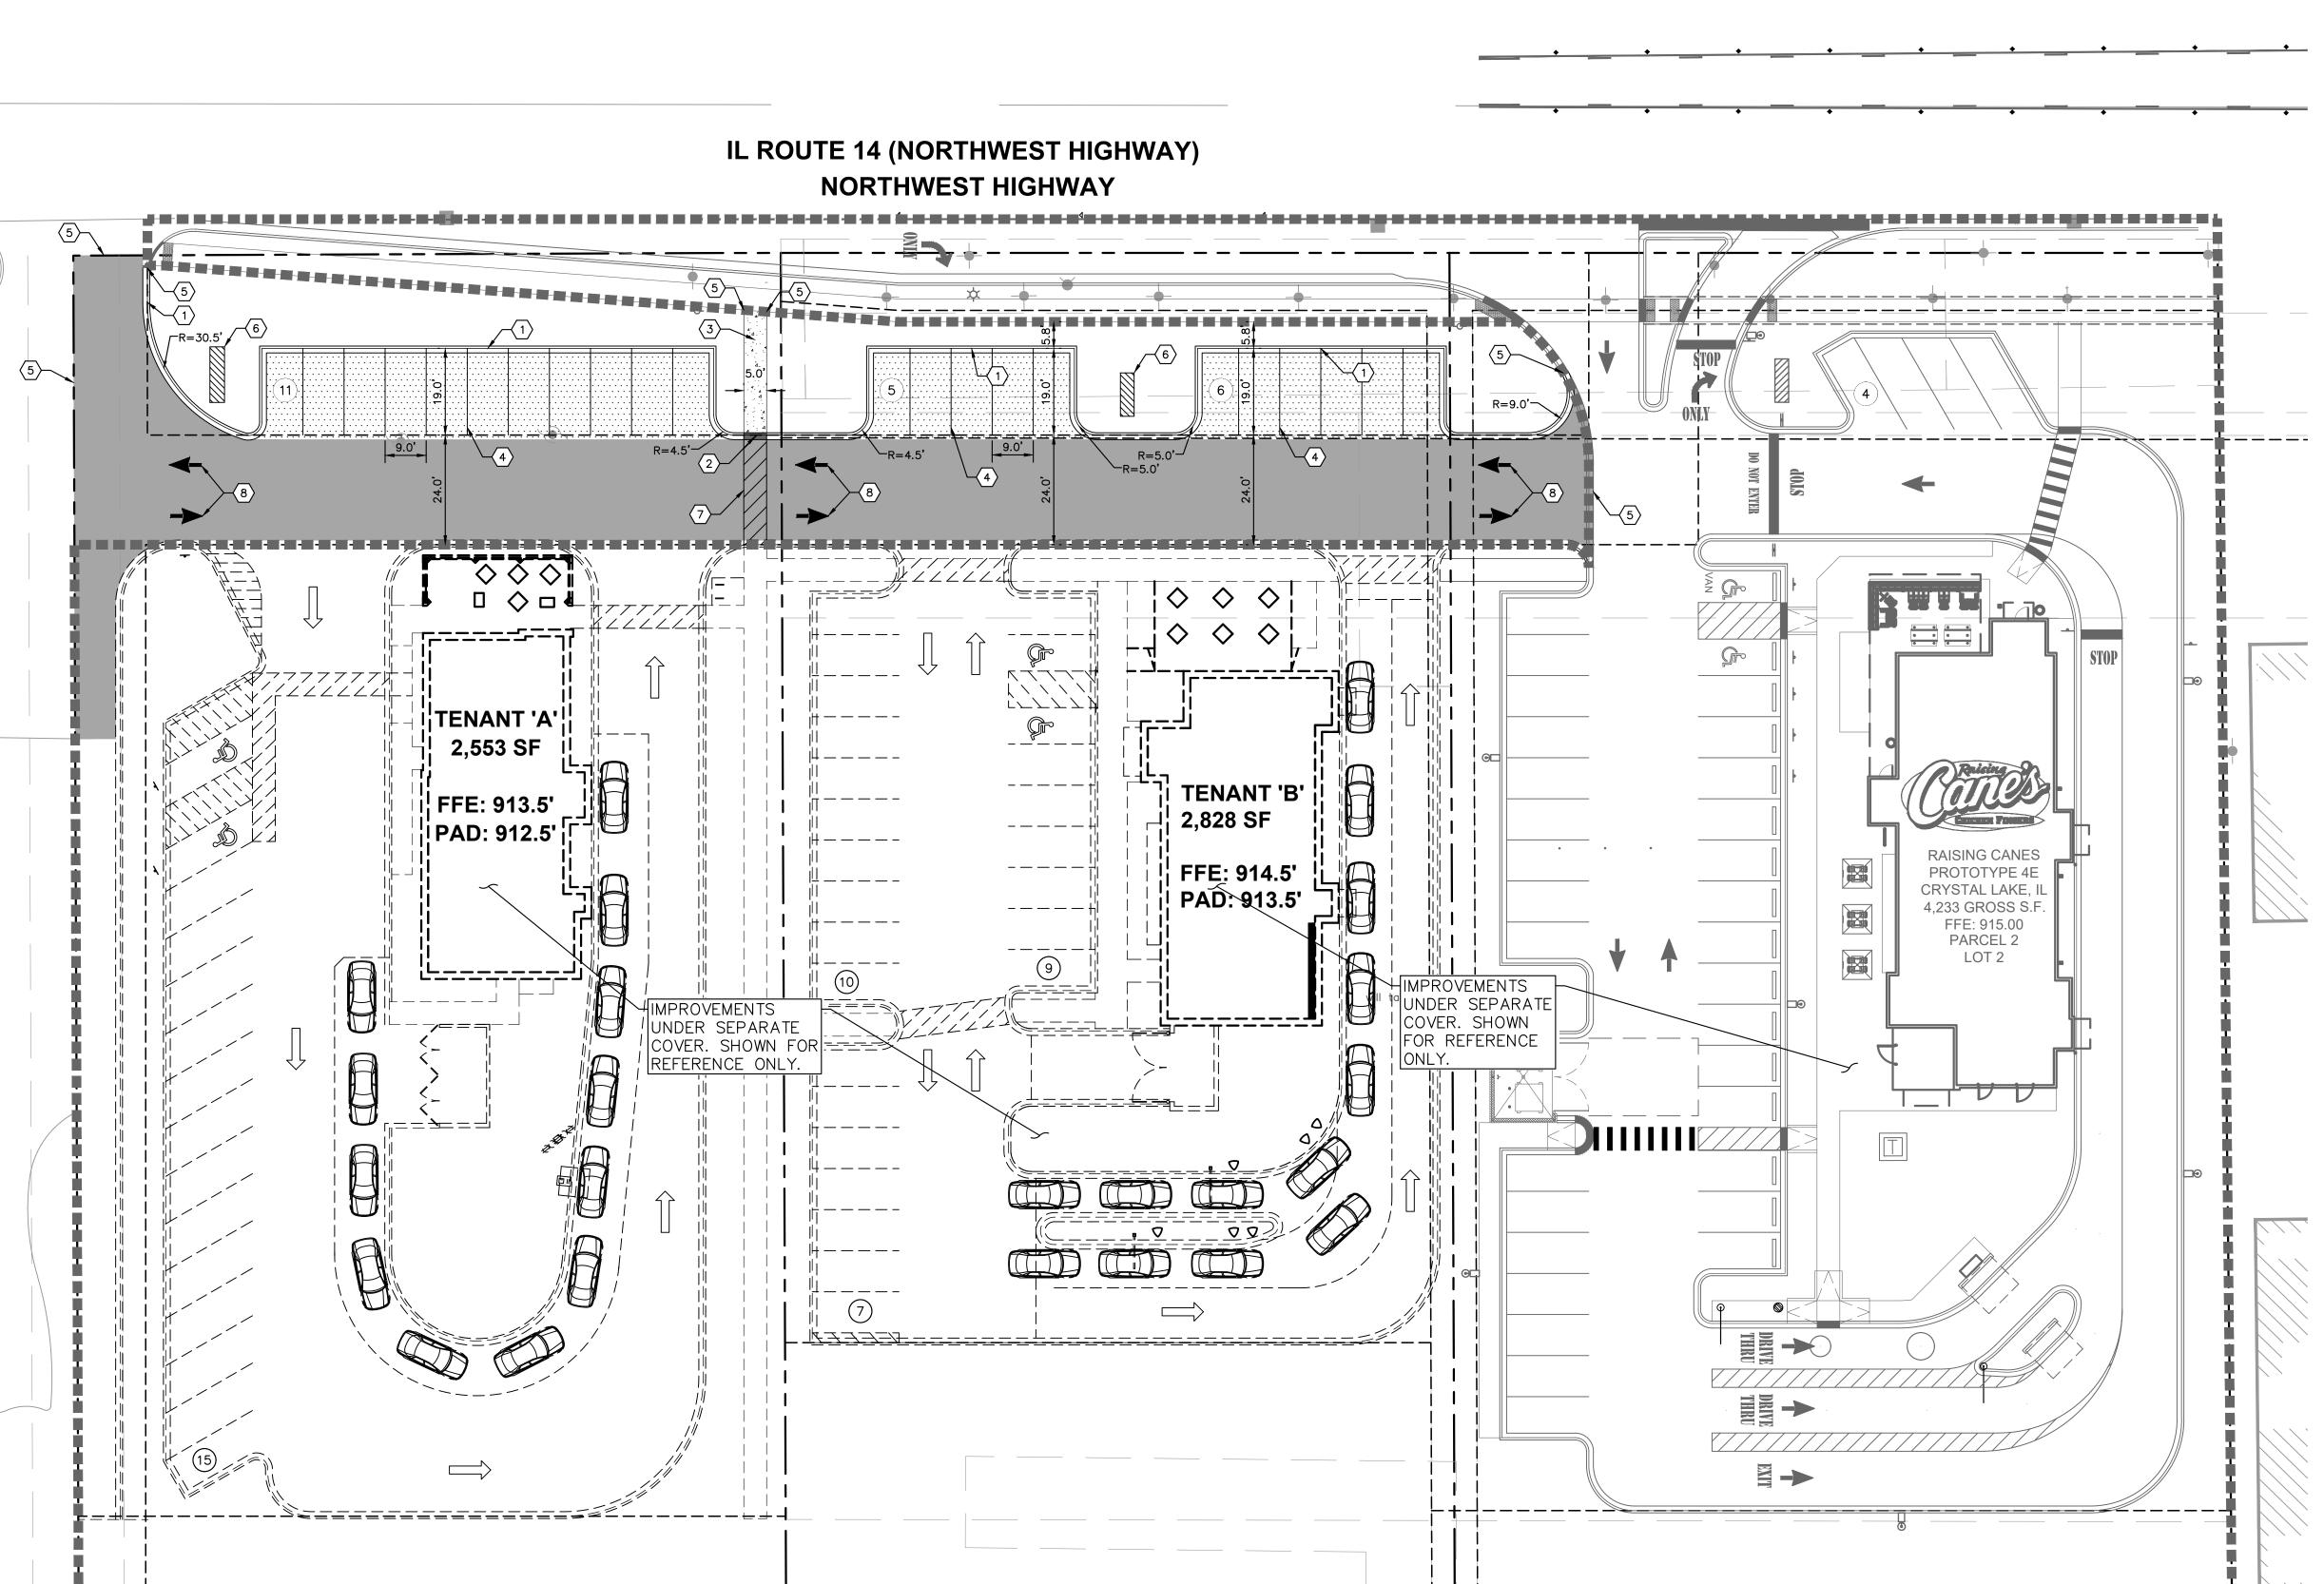CONCRETE SIDEWALK
SEE CONSTRUCTION DETAILS FOR PAVEMENT SECTION

LIMITS OF SCOPE

TOTAL PARKING SPACES PROVIDED

STANDARD PITCH CONCRETE CURB AND GUTTER REVERSE PITCH CONCRETE CURB AND GUTTER CONCRETE DEPRESSED CURB AND GUTTER

PARKING SUMMARY

TENANT A

PARKING SPACES REQUIRED (CITY STANDARD) = 26 SPACES (1 SPACE/100 SF GFA)

PARKING SPACES PROVIDED = 24 SPACES

ACCESSIBLE PARKING SPACES REQUIRED = 2 SPACES

ACCESSIBLE PARKING SPACES PROVIDED = 2 SPACES

TENANT B
PARKING SPACES REQUIRED (CITY STANDARD) = 29 SPACES (1 SPACE/100 SF GFA)
PARKING SPACES PROVIDED = 35 SPACES ACCESSIBLE PARKING SPACES REQUIRED = 2 SPACES ACCESSIBLE PARKING SPACES PROVIDED = 2 SPACES TOTAL PARKING SPACES PROVIDED

= 26 SPACES

FEMA NOTE


PER FLOOD INSURANCE RATE MAP PANEL NO. 17111C0335J, THE SITE OR A PORTION OF THE SITE IS LOCATED IN ZONE X, AREA OF MINIMAL FLOOD HAZARD.


Kimley»Horn

ORIGINAL ISSUE:

X/XX/21 KHA PROJECT NO 168726001 SHEET NUMBER

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- ADDITIONALLY, CONSTRUCTION ENTRANCE SHALL BE LOCATED TO COINCIDE WITH

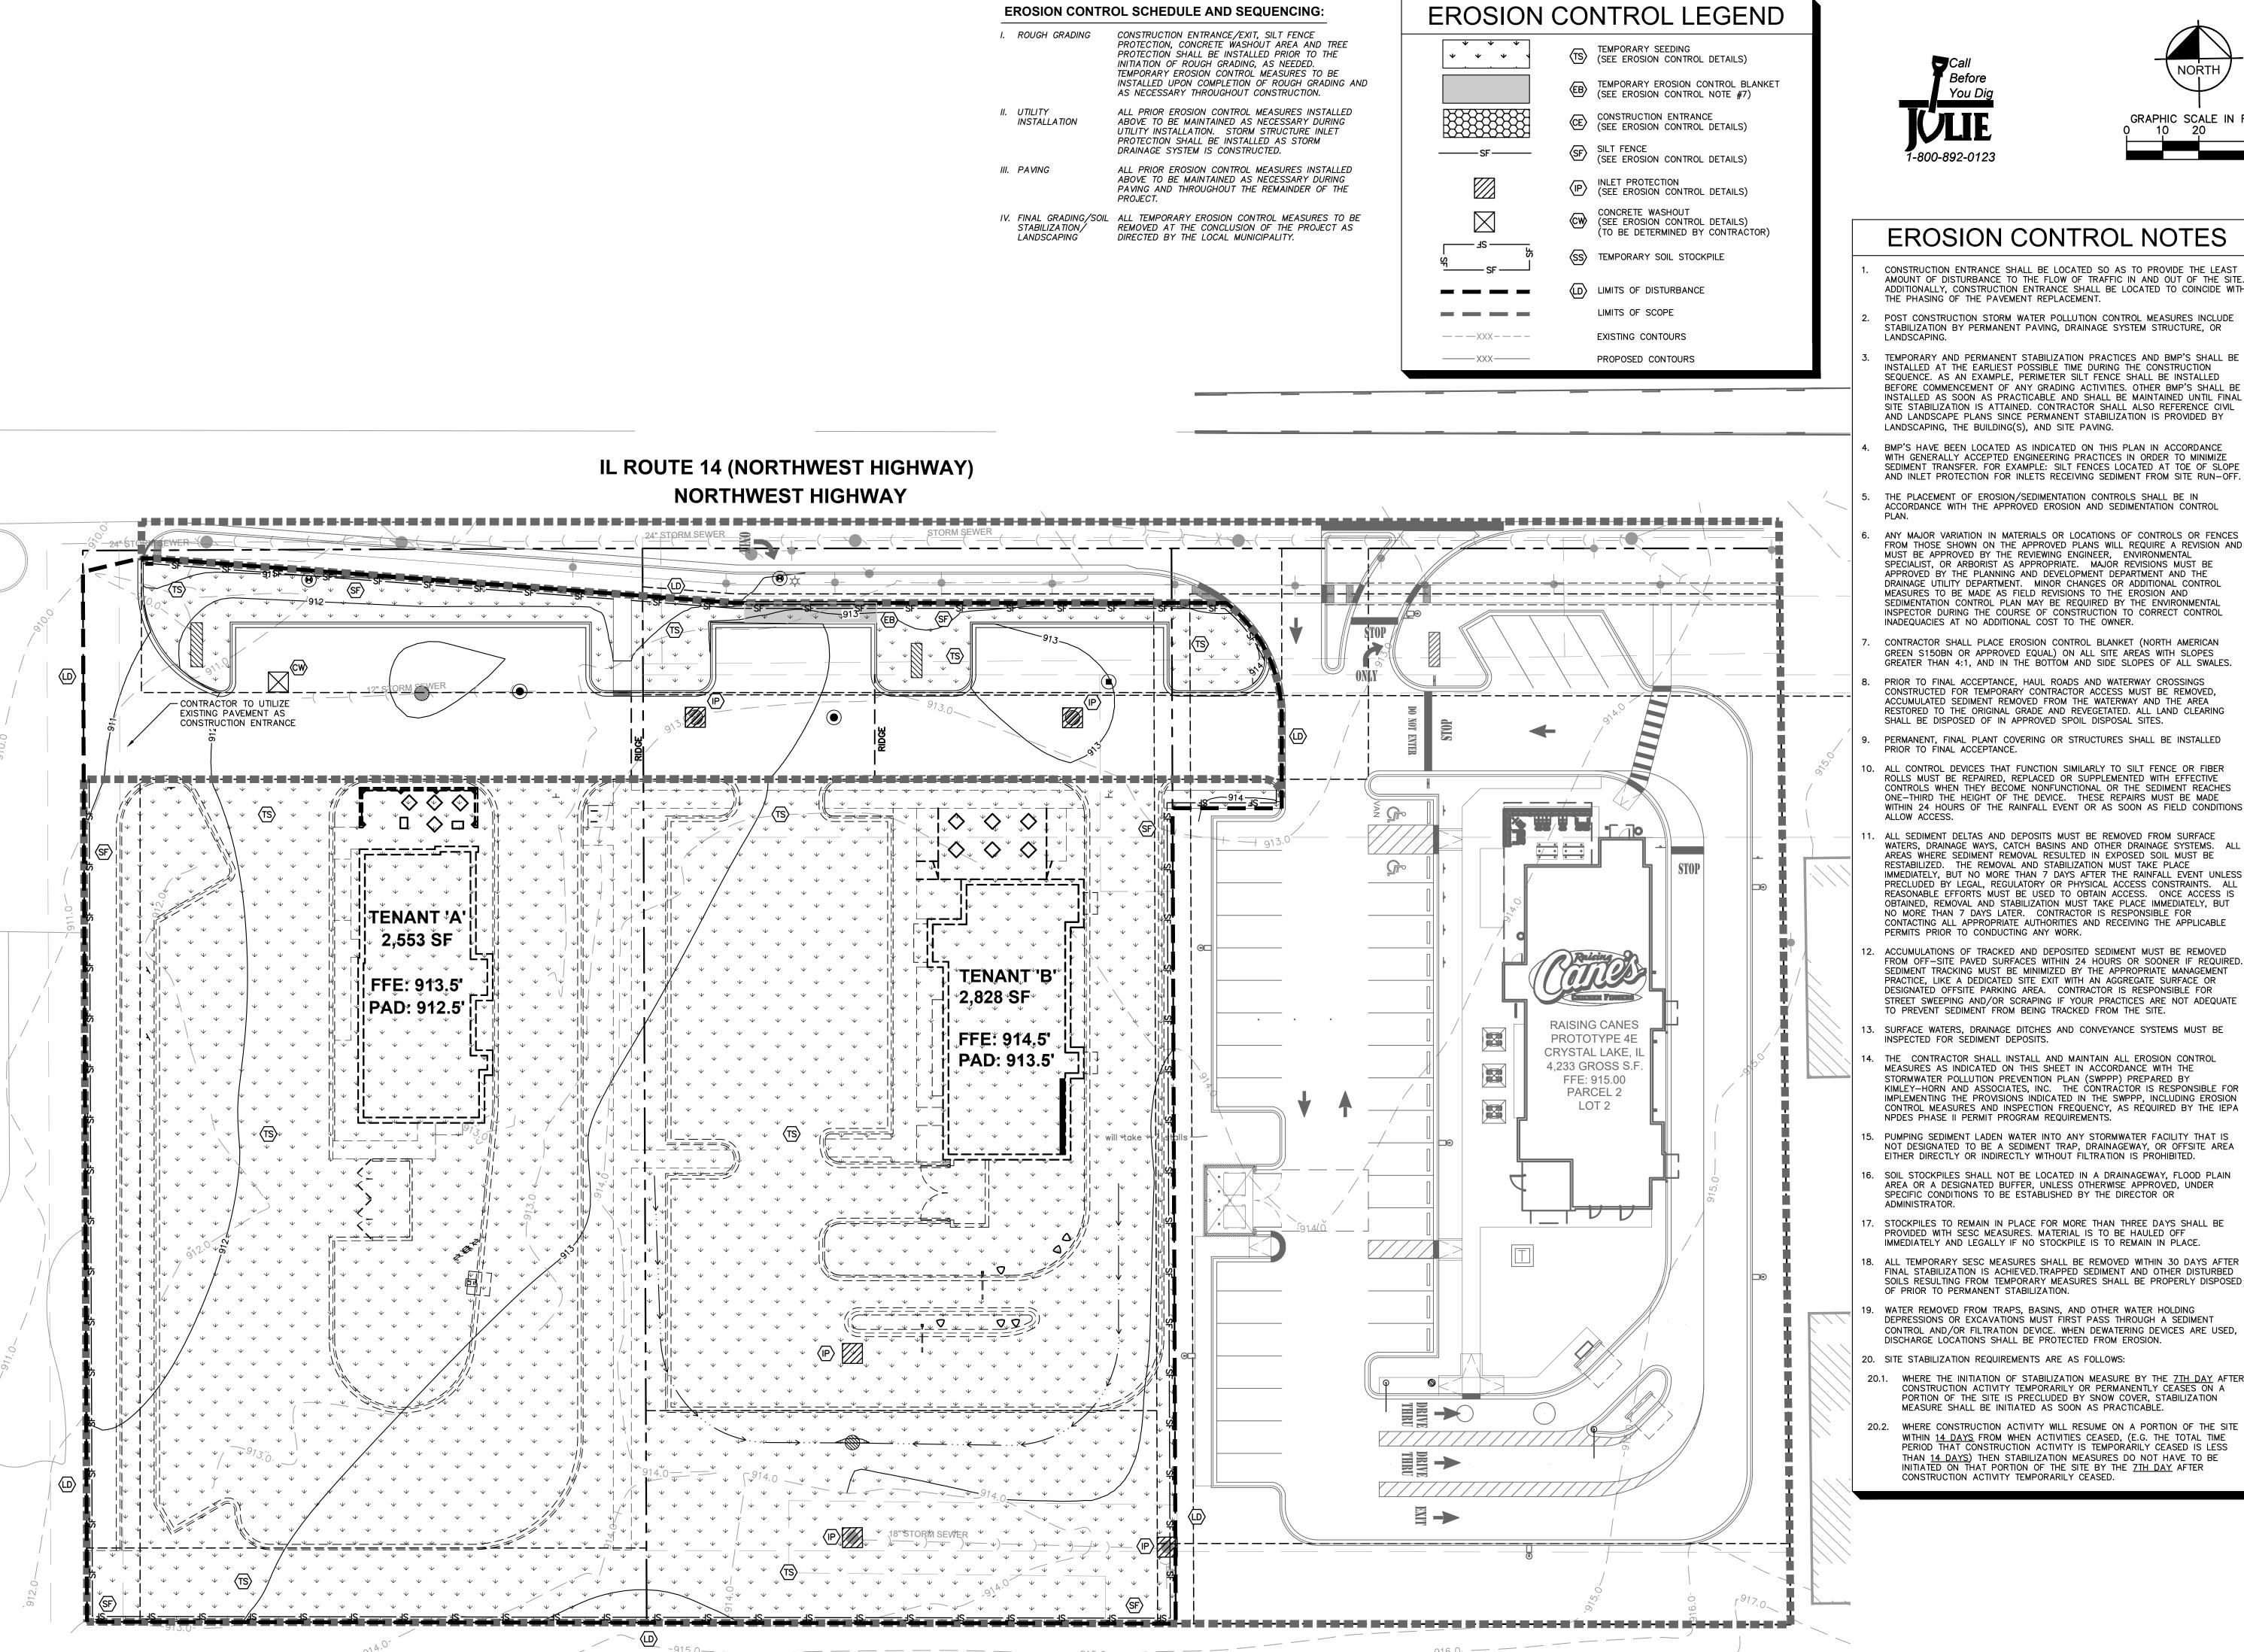Horn Kimley

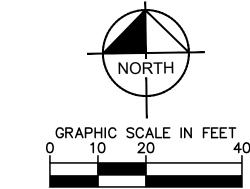
ORIGINAL ISSUE: X/XX/21 KHA PROJECT NO

168726001 SHEET NUMBER

C4.0



TO STARTING WORK.

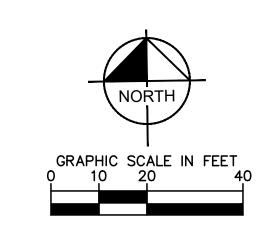

GRADING NOTES

- CONTRACTOR TO VERIFY ALL EXISTING TOPOGRAPHY AND STRUCTURES ON THE SITE AND IMMEDIATELY NOTIFY THE ENGINEER OF ANY DISCREPANCIES PRIOR
- ALL PAVEMENT SPOT GRADE ELEVATIONS AND RIM ELEVATIONS WITHIN OR ALONG CURB AND GUTTER REFER TO FLOW LINE ELEVATIONS UNLESS OTHERWISE NOTED.
- ALL ELEVATIONS SHOWN DEPICT FINISHED GRADE UNLESS OTHERWISE NOTED. GENERAL CONTRACTOR TO COORDINATE WITH EXCAVATION, LANDSCAPE AND PAVING SUBCONTRACTORS REGARDING TOPSOIL THICKNESS FOR LANDSCAPE AREAS AND PAVEMENT SECTION THICKNESS FOR PAVED AREAS TO PROPERLY ENSURE ADEQUATE CUT TO ESTABLISH SUBGRADE ELEVATIONS.
- MAXIMUM SLOPE IN ACCESSIBLE PARKING SPACES AND LOADING ZONES SHALL NOT EXCEED 2.0% IN ALL DIRECTIONS.

NO EARTHEN SLOPE SHALL BE GREATER THAN 3:1, UNLESS OTHERWISE NOTED.

- MAXIMUM RUNNING SLOPE SHALL NOT EXCEED 5% AND CROSS SLOPE SHALL
- NOT EXCEED 2% ON ALL SIDEWALKS AND ACCESSIBLE ROUTES.
- WHEN NATURAL FLOW OF DRAINAGE IS AWAY FROM CURB, CONTRACTOR TO INSTALL REVERSE GUTTER PITCH.

8. MATCH EXISTING ELEVATIONS AT THE PROPERTY LIMITS.

GRADING LEGEND

TP = TOP OF PAVEMENTEP = EDGE OF PAVEMENTFL = FLOW LINE

TC = TOP OF CURBME = MATCH ELEVATION

TF = TOP OF FOUNDATIONR = RIM ELEVATION

TW = TOP OF WALLFG = FINISHED GRADE

TS = TOP OF STAIRS BS = BOTTOM OF STAIRS

RIDGE LINE

 $\overline{}$

——XXX——

 $---\times\times\times---$

____ RIDGE ____

——— AR ———

PROPOSED CONTOUR EXISTING CONTOUR

SLOPE AND FLOW DIRECTION 100-YEAR OVERLAND OVERFLOW ROUTE

DETENTION BASIN 100-YEAR EMERGENCY OVERLAND OVERFLOW ROUTE

PROPOSED SWALE PROPOSED RETAINING WALL

REVERSED PITCH CURB AND GUTTER ACCESSIBLE ROUTE

RIP RAP (SEE DETAILS) LIMITS OF SCOPE


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Kimley » Horn

ORIGINAL ISSUE: X/XX/21 KHA PROJECT NO. 168726001

SHEET NUMBER

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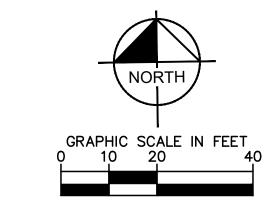
		STORM S	STRUCTURE TABLE	STORM	M STRUCTURE TABLE
		STRUCTURE NAME:	DETAILS:	STRUCTURE NAME:	DETAILS:
			5' DIA. STORM MAHOLE CONTRACTOR TO VERIFY LOCATION AND INVERTS OF EXISTING STORM SEWER	D6	MH — OPEN LID RIM: 912.98 INV OUT: 910.79 (S, 12")
		D1	PRIOR TO ORDERING MATERIAL. RIM: 912.22 INV IN: 889.85 (E, 12") INV IN: 889.77 (W, 12") INV OUT: 889.85 (S, 12")	D7	4' DIA. STORM MANHOLE RIM: 913.08 INV IN: 908.40 (E, 12") INV OUT: 907.49 (N, 12") INV OUT: 907.49 (S, 12")
		D2	4' DIA. STORM MANHOLE RIM: 912.33 INV OUT: 890.09 (W, 12")	D8	STORM SERVICE STUB. CAP FOR FUTURE CONNECTION. RIM: 911.57 INV IN: 907.71 (N, 12")
		D3	4' DIA. STORM MANHOLE RIM: 912.75 INV IN: 890.56 (S, 12") INV OUT: 908.72 (W, 12")	ED1	RAISE EXISTING INLET RIM TO 912 RIM: 911.71
		D4	STORM SERVICE STUB. CAP FOR FUTURE CONNECTION. RIM: 908.94 INV IN: 890.14 (N, 12")		
		D5	STORM SERVICE STUB. CAP FOR FUTURE CONNECTION. RIM: 894.64 INV OUT: 890.79 (N, 12")		
CATCH BASIN RIM=909.74 INV=904.24	INLET RIM=910.04 INV=907.08		IL ROUTE 14 (I NORTH	NORTHWE	
24" STORY EWER W			((24" STORM SEWER	(W3)	CONNECT INTO EXISTING MANHOLE
	CATCH BASIN RIM=910.38			RIM=910.75	49 LF OF 12" RCP @ 1.00%
18" SANITARY SANITARY	STORM MANHOLE RIM=910.89 INV=899.04	STORM MANHOLE RIM=910.88 NV=899.53	-47 LF OF 12" RCP @ 0.50%	CONNECT INTO EXISTING MANHOLE	
MANHOLE- RIM=910.46 INV =996.11	12" STORM SWER			SANITARY MANHOLE FIM=912.80	64 LF OF
	(ED1)—/ \ \ \ \ \ \ \ \ \ \ \ \ \ \	- ∕ 1		INV N=906.00 INV SE=906.12	

DETAILS:
DIA. SANITARY MANHOLE 912.99 IN: 907.05 (S, 6") OUT: 907.05 (W, 6")

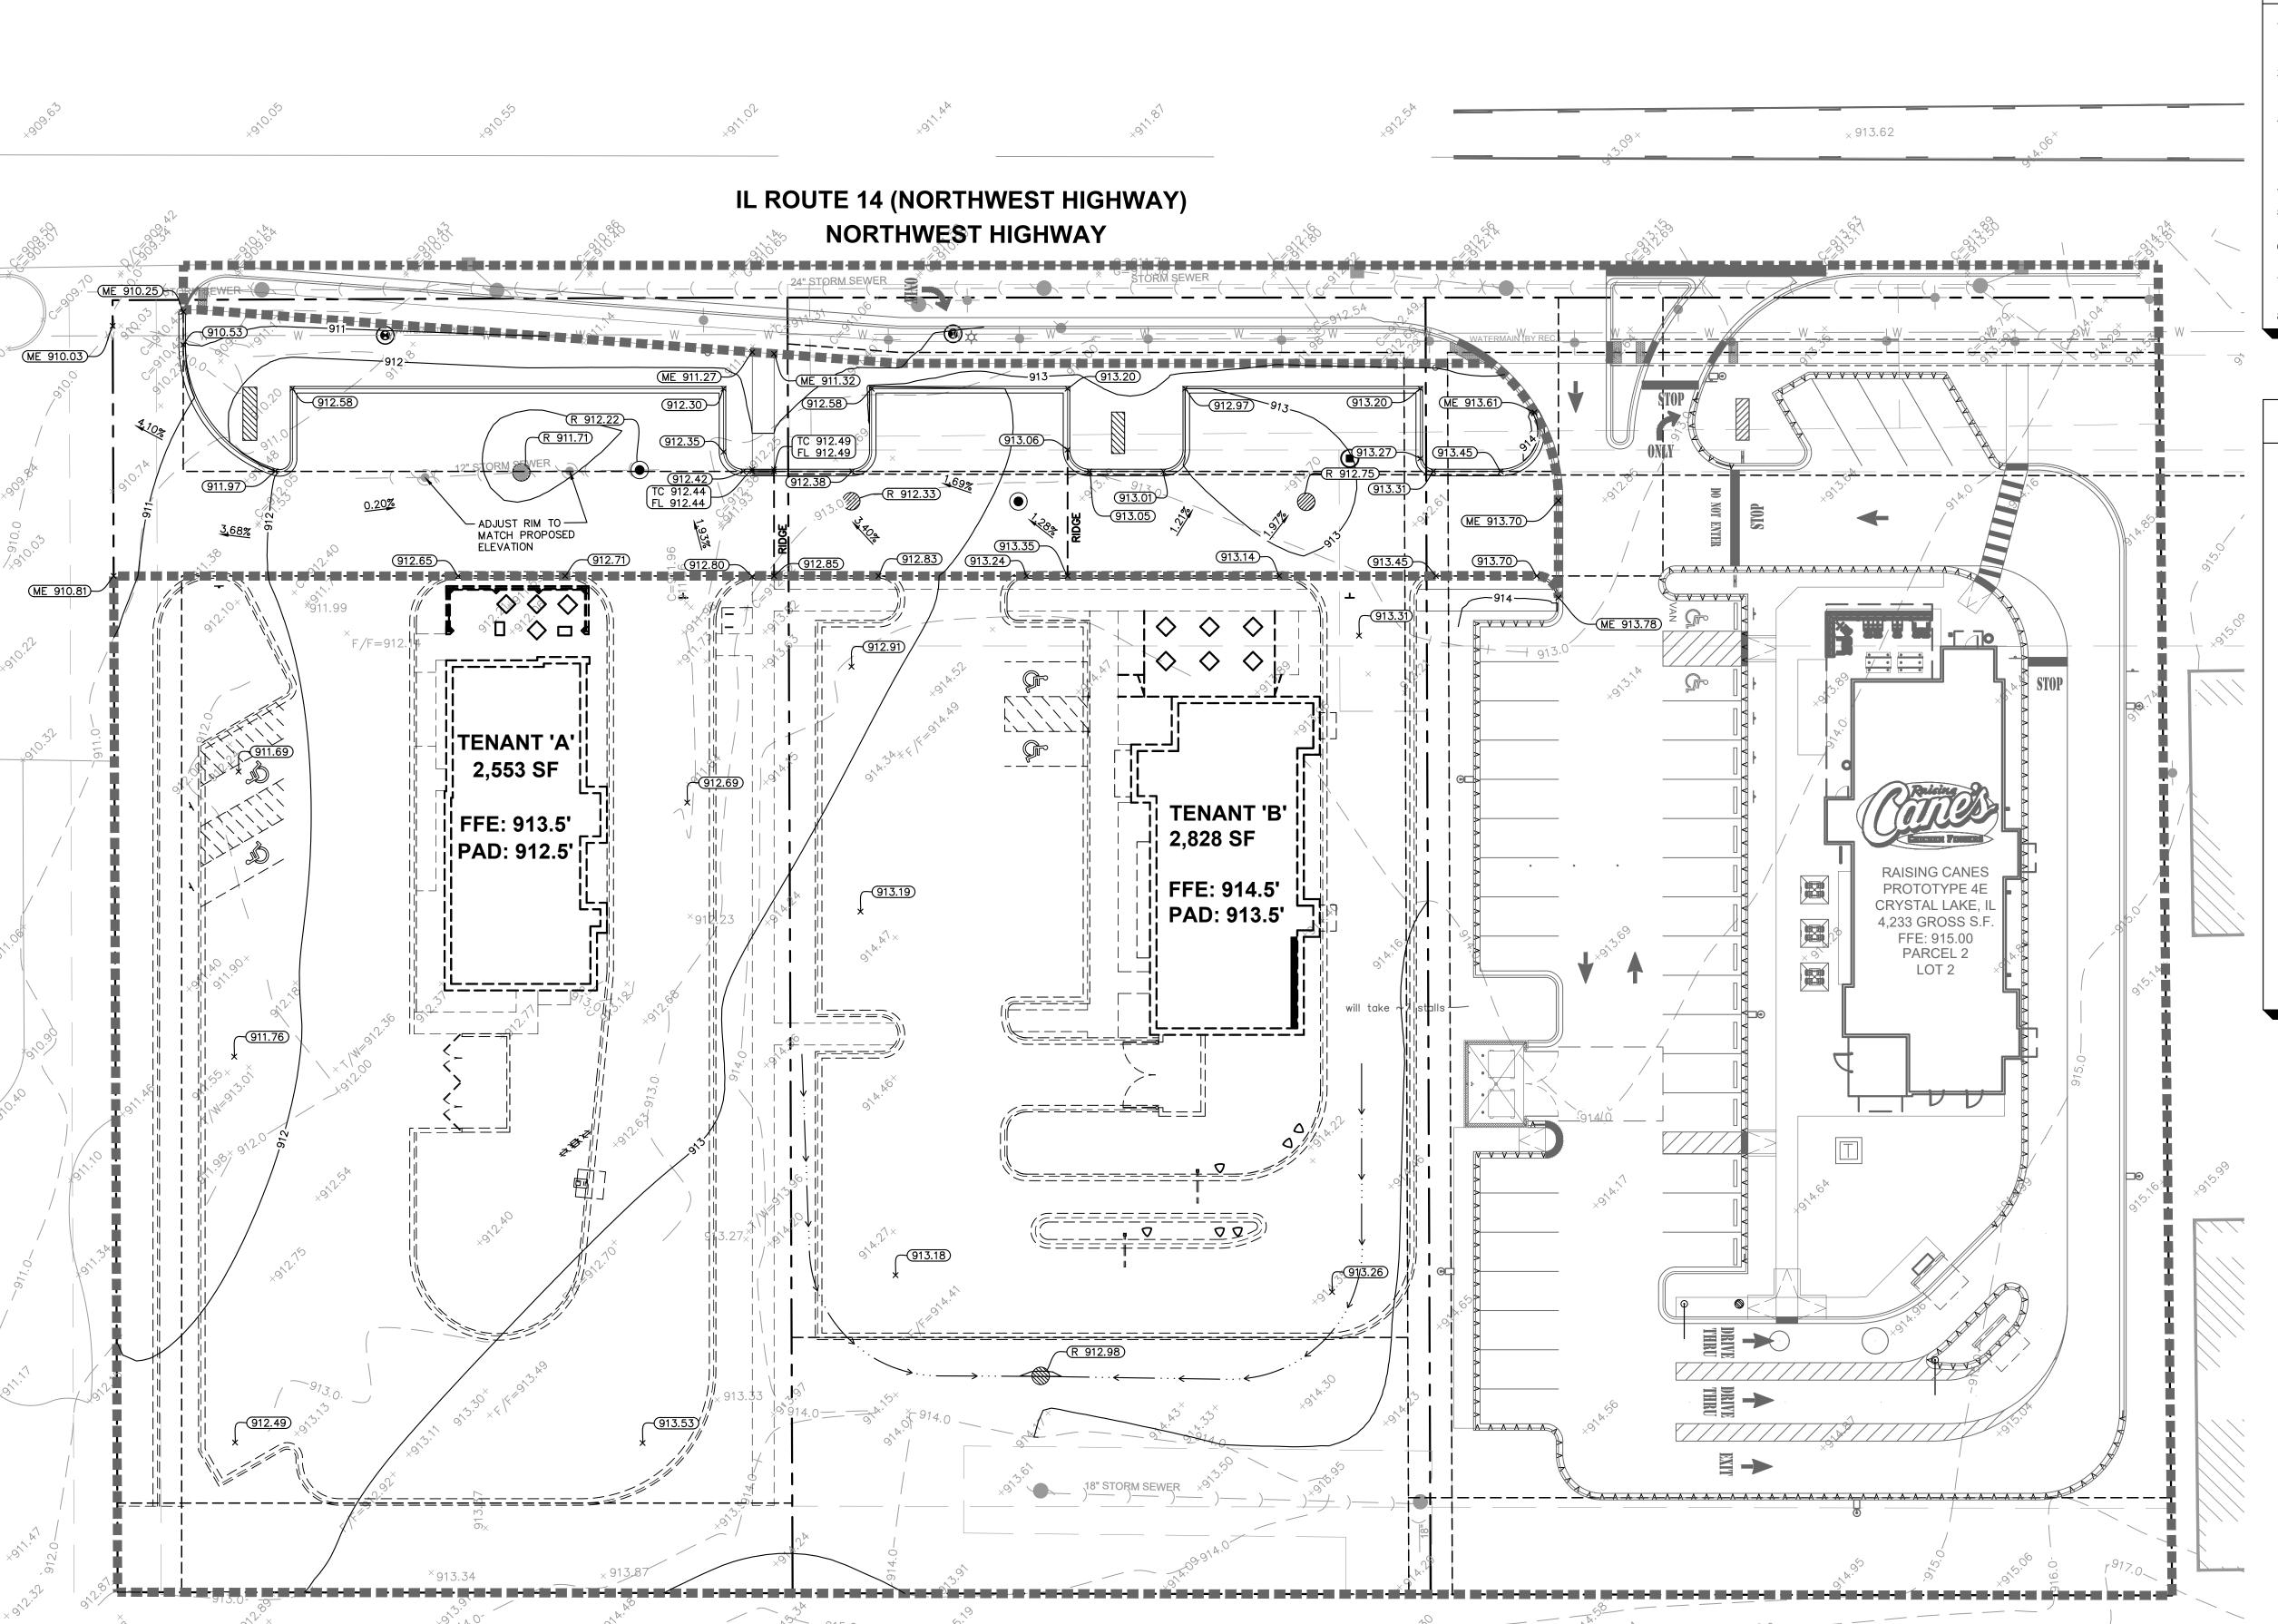SANITARY STUB TABLE			
CTURE NAME: DETAILS:			
S2	SAN SERVICE STUB. CAP FOR FUTURE CONNECTION. INV OUT: 907.37 (N, 6")		
S3	SAN SERVICE STUB. CAP FOR FUTURE CONNECTION. INV OUT: 906.58 (NE, 6")		

	WATER STRUCTURE TABLE					
	STRUCTURE NAME:	DETAILS:				
	W1	PRESSURE CONNECT TO EX. WATERMAIN PER CITY STANDARDS. CONTRACTOR TO FIELD VERIFY LOCATION, DEPTH, AND SIZE OF EX. UTILITIES PRIOR TO ORDERING MATERIALS. FG ELEV: 911.16				
	W2	STUB FG ELEV: 912.42				
	W3	PRESSURE CONNECT TO EX. WATERMAIN PER CITY STANDARDS. CONTRACTOR TO FIELD VERIFY LOCATION, DEPTH, AND SIZE OF EX. UTILITIES PRIOR TO ORDERING MATERIALS. FG ELEV: 912.07				
	W4	STUB FG ELEV: 913.04				





≫Horn


UTILITY NOTES

- 1. ALL WATER LINES ≥ 3" SHALL BE DUCTILE IRON PIPE, CLASS 52.
- 2. ALL SANITARY SEWER LINES SHALL BE PVC MEETING, ASTM D-3034 SDR 26 EXCEPT FOR SANITARY SEWER THAT CROSSES ABOVE WATER MAIN, THIS PIPE SHALL BE AWWA C900 (UNLESS WATER MAIN CASING IS UTILIZED). PROVIDE 42" MINIMUM COVER.
- CONTRACTOR SHALL COORDINATE ANY DISRUPTIONS TO EXISTING UTILITY SERVICES WITH ADJACENT PROPERTY OWNERS.
- ALL ELECTRIC AND TELEPHONE EXTENSIONS INCLUDING SERVICE LINES SHALL BE CONSTRUCTED TO THE APPROPRIATE UTILITY COMPANY SPECIFICATIONS. ALL UTILITY DISCONNECTIONS SHALL BE COORDINATED WITH THE DESIGNATED
- CONSTRUCTION SHALL NOT START ON ANY PUBLIC UTILITY SYSTEM UNTIL WRITTEN APPROVAL HAS BEEN RECEIVED BY THE ENGINEER FROM THE APPROPRIATE GOVERNING AUTHORITY AND CONTRACTOR HAS BEEN NOTIFIED BY THE ENGINEER.
- CONTRACTOR TO CALL "JULIE" (1-800-892-0123) TO COORDINATE FIELD LOCATIONS OF EXISTING UNDERGROUND UTILITIES BEFORE ORDERING MATERIALS OR COMMENCING CONSTRUCTION. NOTIFY ENGINEER OF ANY DISCREPANCIES IMMEDIATELY.
- PRIOR TO THE CONSTRUCTION OF OR CONNECTION TO ANY STORM DRAIN, SANITARY SEWER, WATER MAIN OR ANY OTHER UTILITIES, THE CONTRACTOR SHALL EXCAVATE, VERIFY AND CALCULATE ALL POINTS OF CONNECTION AND ALL UTILITY CROSSINGS AND INFORM THE ENGINEER AND THE OWNER/ DEVELOPER OF ANY CONFLICT OR REQUIRED DEVIATIONS FROM THE PLAN. NOTIFICATION SHALL BE MADE A MINIMUM OF 72 HOURS PRIOR TO CONSTRUCTION. THE ENGINEER AND ITS CLIENTS SHALL BE HELD HARMLESS IN THE EVENT THAT THE CONTRACTOR FAILS TO MAKE SUCH NOTIFICATION. THE MUNICIPALITY SHALL BE NOTIFIED OF ANY AND ALL CHANGES TO THE DESIGN
- CONTRACTOR SHALL COMPLY COMPLETELY WITH THE LATEST STANDARDS OF OSHA DIRECTIVES OR ANY OTHER AGENCY HAVING JURISDICTION FOR EXCAVATION AND TRENCHING PROCEDURES. THE CONTRACTOR SHALL USE SUPPORT SYSTEMS, SLOPING, BENCHING AND OTHER MEANS OF PROTECTION. THIS IS TO INCLUDE, BUT NOT LIMITED FOR ACCESS AND EGRESS FROM ALL EXCAVATION AND TRENCHING. CONTRACTOR IS RESPONSIBLE FOR COMPLYING WITH PERFORMANCE CRITERIA AS REQUIRED BY OSHA.
- CONTRACTOR TO AVOID DISRUPTION OF ANY ADJACENT TENANT'S TRAFFIC OPERATIONS DURING INSTALLATION OF UTILITIES.
- 10. ALL DIMENSIONS ARE TO CENTERLINE OF PIPE OR CENTER OF MANHOLE UNLESS NOTED OTHERWISE.
- 11. SEE ARCHITECTURAL AND MEP PLANS FOR EXACT UTILITY CONNECTION

LOCATIONS AT BUILDING.

- 12. LIGHT POLES SHOWN FOR COORDINATION PURPOSES ONLY AND DO NOT REPRESENT ACTUAL SIZE. SEE SITE LIGHTING PLANS BY OTHERS FOR MORE
- 13. SEE DETAILS FOR LOCATING STORM STRUCTURES WITHIN THE CURB LINE.
- 14. STORMWATER FACILITIES MUST BE FUNCTIONAL BEFORE BUILDING CONSTRUCTION


UTILITY LEGEND

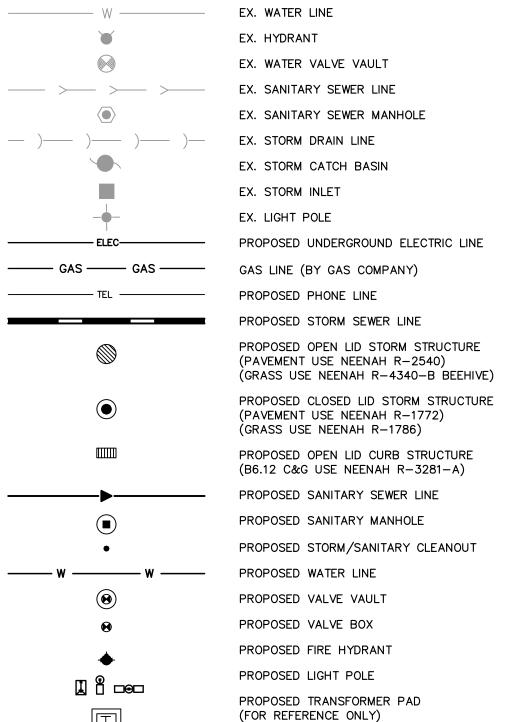

ORIGINAL ISSUE: X/XX/21

KHA PROJECT NO 168726001 SHEET NUMBER

C6.0

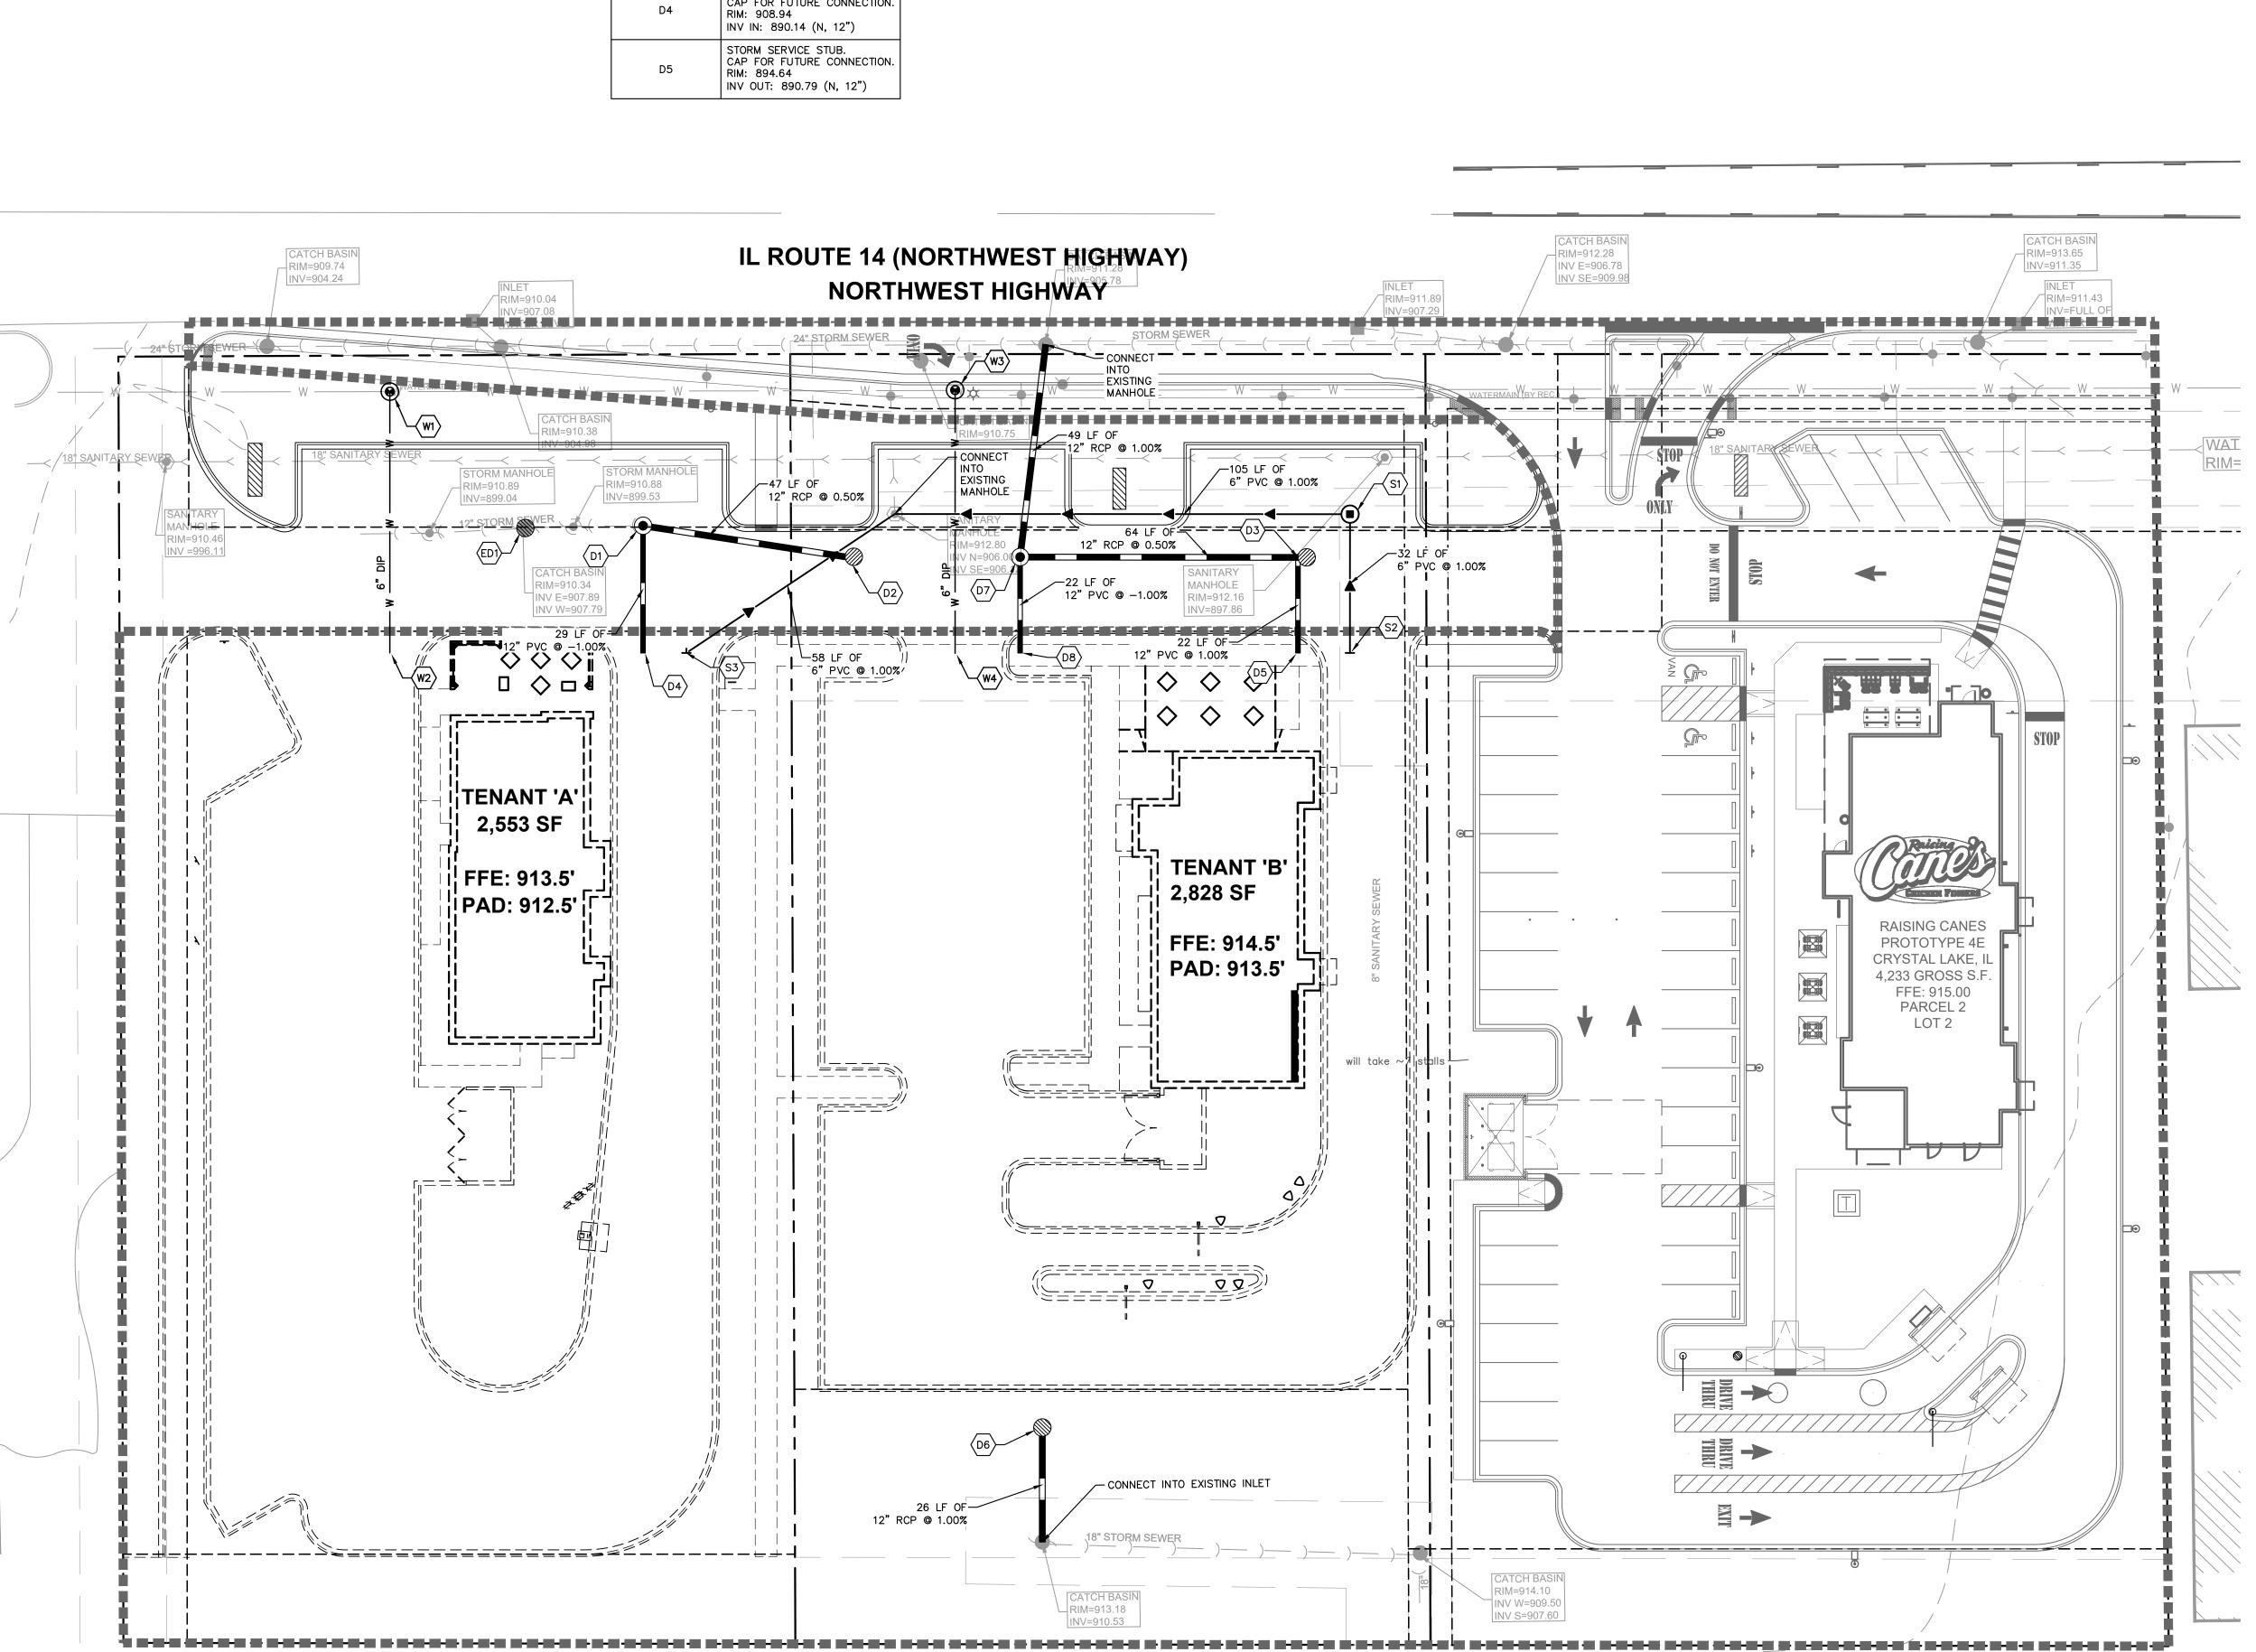

Traffic Impact Study

5417-5501 Northwest Hwy Mixed-Use Development Crystal Lake, Illinois

June 11, 2019 Updated July 13, 2020 Updated July 30, 2021

Prepared for:



Prepared by:

Dan Brinkman, P.E., PTOE
Assistant Director of Transportation Services

G - A GEWALT HAMILTON ASSOCIATES, INC.



Executive Summary

The following study represents the third update to a Traffic Impact Study prepared by Gewalt Hamilton Associates, Inc. (GHA) for the proposed development to be located at 5417-5507 Northwest Highway. Our Initial study in June 2019 included a variety of commercial and retail uses in addition to a single drive-through restaurant. The subsequent July 2020 update considered a two-phased development comprised of the Raising Canes drive through restaurant and a to-be-determined sit down style family restaurant. The latest iteration that follows considers the Raising Canes Restaurant currently under construction (although the site plan provided includes a larger building that previously considered) and two additional drive-through restaurant uses.

Some key considerations and findings of the updated study include:

- Traffic has been projected out to 2027 (in lieu of 2026) to reflect a 5-year buildout beyond development of the additional drive-through restaurants.
- Trip generations have been updated for both Phases of the development and include the larger Raising Canes building shown on the site plan provided.
- Traffic analyses have been updated to reflect the more intense nature of the development than previously
 considered. However, given the nature of the restaurants proposed and their limited breakfast offerings, it is very
 likely that the traffic volumes are overstated for the Morning Peak Hour.
- Recommendations to accommodate traffic impacts remain generally the same as previous studies with some
 additional emphasis to widen the shared access on the Cassidy Tire site to a true 3-lane (35-ft wide) access
 capable of providing two outbound lanes. Furthermore, given the anticipated queueing at this location some
 supplemental signage and pavement markings should be considered to keep the intersection clear and mitigate
 potential of backing up traffic onto US Route 14.
- Overall, the impacts of the latest development iteration can be accommodated by the area roadways, with the
 understanding that unsignalized left turns in and out of the development will have longer than desirable wait times
 and associated queues. These delays and queues however are typical and to be expected for side streets and
 minor access points located along major arterials such as US Route 14.
- Stacking requirements for the two new proposed drive-through restaurants meet the City's requirements. There
 may still be times when queues exceed the limits shown on the site plans, but we anticipate that after the initial
 "newness" wears off, all queues and stacking can be contained on site an out of the public right of way.

This update has been prepared by

Daniel P Brinkman, PE, PTOE

Assistant Director of Transportation Services

Part I. Introduction and Project Context

Gewalt Hamilton Associates, Inc. (GHA) has conducted a Traffic Impact Study for the proposed restaurant development to be located at 5417-5507 Northwest Highway (US Route 14) in Crystal Lake, Illinois. The approximately 3.20-acre site formerly contained Pauly Toyota. Access to the site was provided via three full access driveways on US Route 14, as well as a fourth shared access with the adjacent Cassidy Tire use, aligned opposite Federal Drive.

An approximately 3,700 square-foot, Raising Cane's fast food restaurant with drive-through window is currently under construction on the eastern ±1.2-acres and is referred to as Phase I for the balance of this report. The Raising Canes site is to be accessed via a proposed three-quarter (left-in/right-in/right-out) driveway on US Route 14, with future cross-access provided to the adjacent parcel to the west and the Cassidy Tire site.

Per the July 28, 2021 Overall Site Plan prepared by Design Studio 24, LLC the development of the western ±2.0-acres will be developed with two additional drive-through restaurants (a *Wendy's* and a *Gomez Y Guzman [GYG]*) of approximately 2,550 and 2,850 square feet, respectively. These additional restaurants are referred to as Phase II. Upon full build-out, access to the site will be provided via a cross-connection to the three-quarter access, as well as the existing shared access with Cassidy Tire; the remaining access driveways along US Rte 14 serving the site will be closed. This is an effective access management strategy to improve safety and progression along corridors.

The following summarizes our findings and provides various recommendations for your consideration. *Appendices* referenced are in the Technical Addendum at the end of this document.


Part II. Background Information

Site Location Map and Roadway Inventory

Exhibit 1 provides a site location map. The existing traffic operations in the site area are illustrated on **Exhibit 2**. **Appendix A** provides a photo inventory of the site vicinity prior to the commencement of construction of Raising Canes. Pertinent comments to the adjacent roadways include:

Northwest Highway (US Route 14)

- US Route 14 is an east-west, Principal Arterial under the jurisdiction of the Illinois Department of Transportation (IDOT).
- US Route 14 provides a five-lane cross section (two through lanes in each direction, with a center lane for left-turns), with a posted speed limit of 35 miles per hour (mph) in the vicinity of the site.
- A dedicated right-turn lane is provided in the eastbound direction at its unsignalized intersection with Three
 Oaks Recreation Area Drive and in the westbound direction at its unsignalized intersection with Federal Drive,
 as well as at its signalized intersection with Exchange Drive.
- US Route 14 is designated as a Strategic Regional Arterial (SRA) route. SRA routes are designed to carry higher traffic volumes at higher travel speeds through access control and traffic signal installation / spacing. It is also designated as a Class II Truck route.
- The Annual Average Daily Traffic (AADT), year 2019, on US Route 14 is 27,800 vehicles with 1,675 trucks (6.0%).

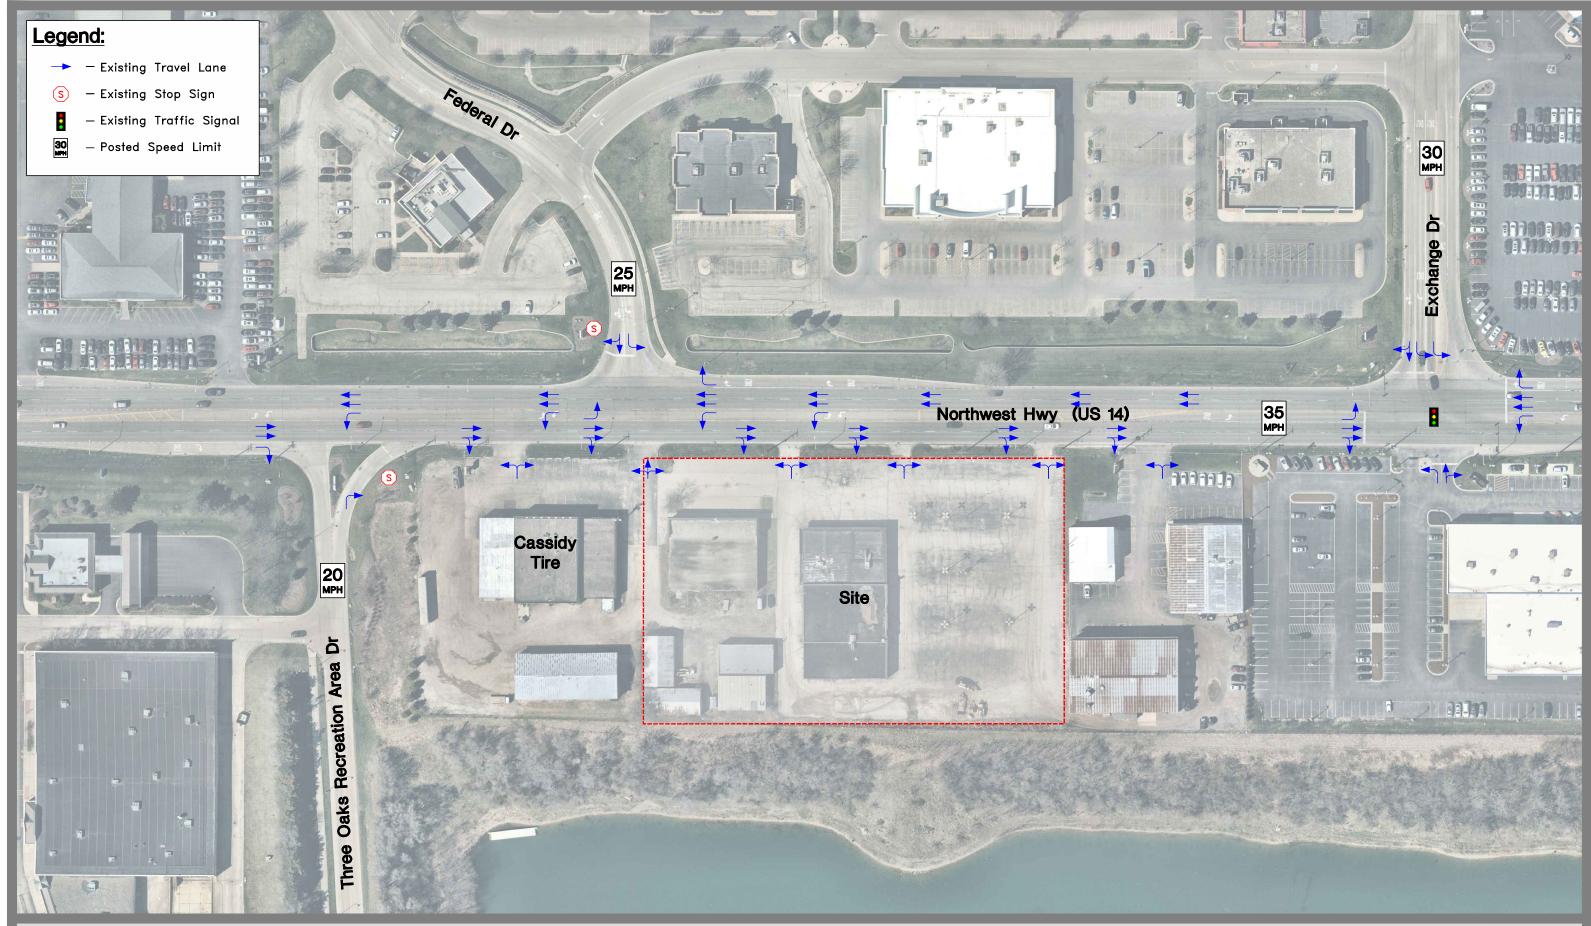





Part III. Traffic Evaluation

Future Site Characteristics

Proposed Development Plan

The Overall Site Plan prepared by Design Studio 24, LLC is provided in *Appendix E*. As shown, the development will consist of an approximately 3,700 square-foot, Raising Cane's fast food restaurant with drive-through window (Phase I), accessed via a proposed three-quarter (left-in/right-in/right-out) driveway on US Route 14, with future cross-access provided to the adjacent parcel to the west.

Per the July 28, 2021 Overall Site Plan the development of the western ±2.0-acres will be developed with two additional drive-through restaurants (a *Wendy's* and a *Gomez Y Guzman*) of approximately 2,550 and 2,850 square feet, respectively. These additional restaurants are referred to as Phase II. Upon full build-out, access to the site will be provided via a cross-connection to the three-quarter access, as well as the existing shared access with Cassidy Tire; the remaining access driveways along US Rte 14 serving the site will be closed. This is an effective access management strategy to improve safety and progression along corridors.

Trip Generation

Table 2 summarizes the traffic generation calculations for the proposed development. Trip generation rates published by the Institute of Transportation Engineers (ITE) in the 10th Edition of the Manual *Trip Generation* were used to determine the anticipated traffic generated by the proposed mix of uses. See **Appendix F** for excerpts from the ITE manual.

Not all vehicle trips expected to be generated by the proposed project represent new trips on the study area roadway system. Studies have shown that for restaurant developments, a substantial portion of the site-generated vehicle trips are already present in the adjacent passing stream of traffic or are diverted from another route to the proposed site. Based on data presented in the ITE *Trip Generation Handbook, 3rd Edition*, the average pass-by trip percentage for the proposed uses is between 43 and 50 percent. However, to provide a conservative analysis, a 20 percent reduction for pass-by traffic was applied to the development site-generated trips, consistent with IDOT guidelines for the preparation of traffic impact studies on SRA routes. It should be noted that the volume of pass-by traffic does not reduce the total trips generated and those trip volumes will still be realized as turning movements at the site driveways.

In addition, for multi-use developments, or developments with cross-access and shared access driveways, internal trips between the land uses within the development are expected to occur. These are multi-purpose trips from one land use within the development to another land use within the same and/or adjacent development (e.g. a customer purchases something from the adjacent automotive store, Cassidy Tire, and eats at one of the restaurants). However, to provide a conservative analysis scenario, no reduction for internal capture was applied.

Table 2: Trip Generation Calculations

				We	ekday F	Peak Ho	urs							
		ITE	Morning			Evening]	Satu	rday Midday		Daily			
Land Use	Size	Code	In	Out	Sum	In	Out	Sum	In	Out	Sum	In	Out	Sum
Phase I - Raising Cane's							•							
Fast Food Restaurant w/Drive-Thru	3.66 KSF	#934				62	58	120	103	98	201	862	862	1,724
less pass-by trips (20%)						-12	-12	-24	-20	-20	-40	-172	-172	-344
New Trips						<i>50</i>	46	96	<i>83</i>	78	161	690	690	1,380
Phase II - Guzman Y Gomez Mexican Kitchen	(GYG) + We	ndy's												
Fast Food Restaurant w/Drive-Thru (GYG)	2.83 KSF	#934	58	56	114	48	44	92	79	76	155	666	666	1,332
less pass-by trips (20%)			-11	-11	-22	-9	-9	-18	-16	-16	-32	-133	-133	-266
New Trips			47	<i>45</i>	92	39	35	74	63	60	123	533	533	1,066
Fast Food Restaurant w/Drive-Thru (Wendys)	2.55 KSF	#934	53	50	103	43	40	83	71	69	140	601	601	1,202
less pass-by trips (20%)			-10	-10	-20	-8	-8	-16	-14	-14	-28	-120	-120	-240
New Trips		43	40	83	<i>35</i>	32	67	<i>57</i>	55	112	481	481	962	
Total Development (Phases I & II)														
New Trips			90	85	175	124	113	237	203	193	396	1,704	1,704	3,408
Pass-By Trips			-21	-21	-42	-29	-29	-58	<i>-50</i>	-50	-100	<i>-425</i>	-425	-850

Sources: Institute of Transportation Engineers (ITE) Trip Generation Manual; 10th Edition, 2017.

ITE Trip Generation Handbook; 3rd Edition, 2017.

Notes: Raising Cane's Restaurant is not open during the morning.

Trip Distribution

Table 3 provides the anticipated distribution of *new* site traffic. This was based on existing site travel patterns, proposed access and the operational characteristics of the adjacent street system.

Table 3: Trip Distribution

Route & Direction	Percent Route To/From Site				
US Route 14					
West of Three Oaks Recreation Area Dr	45%				
East of Exchange Dr	40%				
Three Oaks Recreation Area Dr					
South of US Route 14					
Federal Dr					
North of US Route 14	5%				
Exchange Dr					
North of US Route 14	10%				
Totals =	100%				

⁻⁻ Less than 5%

Site and Total Traffic Assignments

Exhibits 5a and 5b illustrate the site Phase I (Raising Cane's) traffic assignment for the development's *new* and *pass-by* trips, respectively, which is based on the traffic characteristics summarized in *Tables 2 and 3* (traffic generation and trip distribution) and assigned to the area roadways. Similarly, *Exhibits 6a and 6b* illustrate the combined Phase I and Phase II (Raising Cane's and additional drive-through restaurants) *new* and *pass-by* trips, respectively.

The Phase I site traffic (*Exhibits 5a and 5b*) and 2027 No-Build traffic (*Exhibit 4*) were combined to produce the 2027 Total Phase I traffic, which is illustrated on *Exhibit 7*. Similarly, the combined Phase I and Phase II site traffic (*Exhibits 6a and 6b*) and 2027 No-Build traffic (*Exhibit 4*) were combined to produce the 2027 Total Phases I and II traffic, which is illustrated on *Exhibit 8*.

Drive-Through Queueing (Stacking) Analyses

Drive-through queueing analyses were conducted to determine whether the proposed stacking length is adequate to accommodate the drive-through vehicles for the proposed restaurants. Per City of Crystal Lake Ordinance 5 stacking spaces are required prior to the first point of service (order box or service window) and 4 spaces between the order box and the pickup window. For dual drive-through configurations, 5 spaces should be provided prior to each order board. *Table 6* summarizes the requirements and stacking provided for each of the proposed restaurants:

Table 6 Drive-Through Stacking Requirements

Use	City Requirements	Provided Prior to Order	Provided Order to Pick-up	Total Provided
Guzman Y Gomez	4+5*2 =14	9	6	15
Wendy's	4+5 =9	8	4	12

Based on the Design Studio 24, LLC Site Plan (see *Appendix E*), both *Wendy's* and *GYG* provide the required stacking.

Based upon recent surveys conducted by Kimley Horn for at similar Raising Canes fast-food restaurants with drive-through facilities (see *Appendix H*), the maximum stacking did not exceed 15 vehicles, with typical peak hour queues ranging between 8 to 9 vehicles. The sites surveyed were generally located on principal arterial roads with similar, and/or higher, Annual Average Daily Traffic (AADT) volumes as US Route 14.

In general, we believe that for all of the proposed uses that the provided stacking and queueing should be sufficient for the demand once the initial "newness" of the restaurants wears off.

Bicycle and Pedestrian Accommodations


The proximity of the proposed development to the Three Oaks Recreation Area and the associated proposed boardwalk along the south end of the site require that additional attention in site planning and layout be given to pedestrian and bicycle accommodations. For traditionally auto-centric land uses, the proposed plan generally does a good job of providing accommodations for pedestrians and bicycles by providing connections and marked crossings to the south end of the lots as well as outdoor patio areas.

Some additional considerations could include:

- Enhanced warning signage for the pedestrian connections to the proposed sidewalk along US Route 14 (e.g., fluorescent yellow-green signs and markings).
- Provide Stop Signs and Stop Bars along exit drives in advance of the pedestrian crossings that parallel US Route 14.
- Provisions for bicycle parking / bike racks should be included on the site plans or in a common area adjacent to the future boardwalk easement.

- Consider supplemental signage instructing riders to dismount and walk bikes upon entering the various restaurant sites to help minimize conflicts with motorists.
- Ensure plantings and landscaping is kept to ground level in the vicinity of crossing locations to preserve sight lines for pedestrians.

Exhibit 10 identifies some of our recommendations on the current proposed site plan.

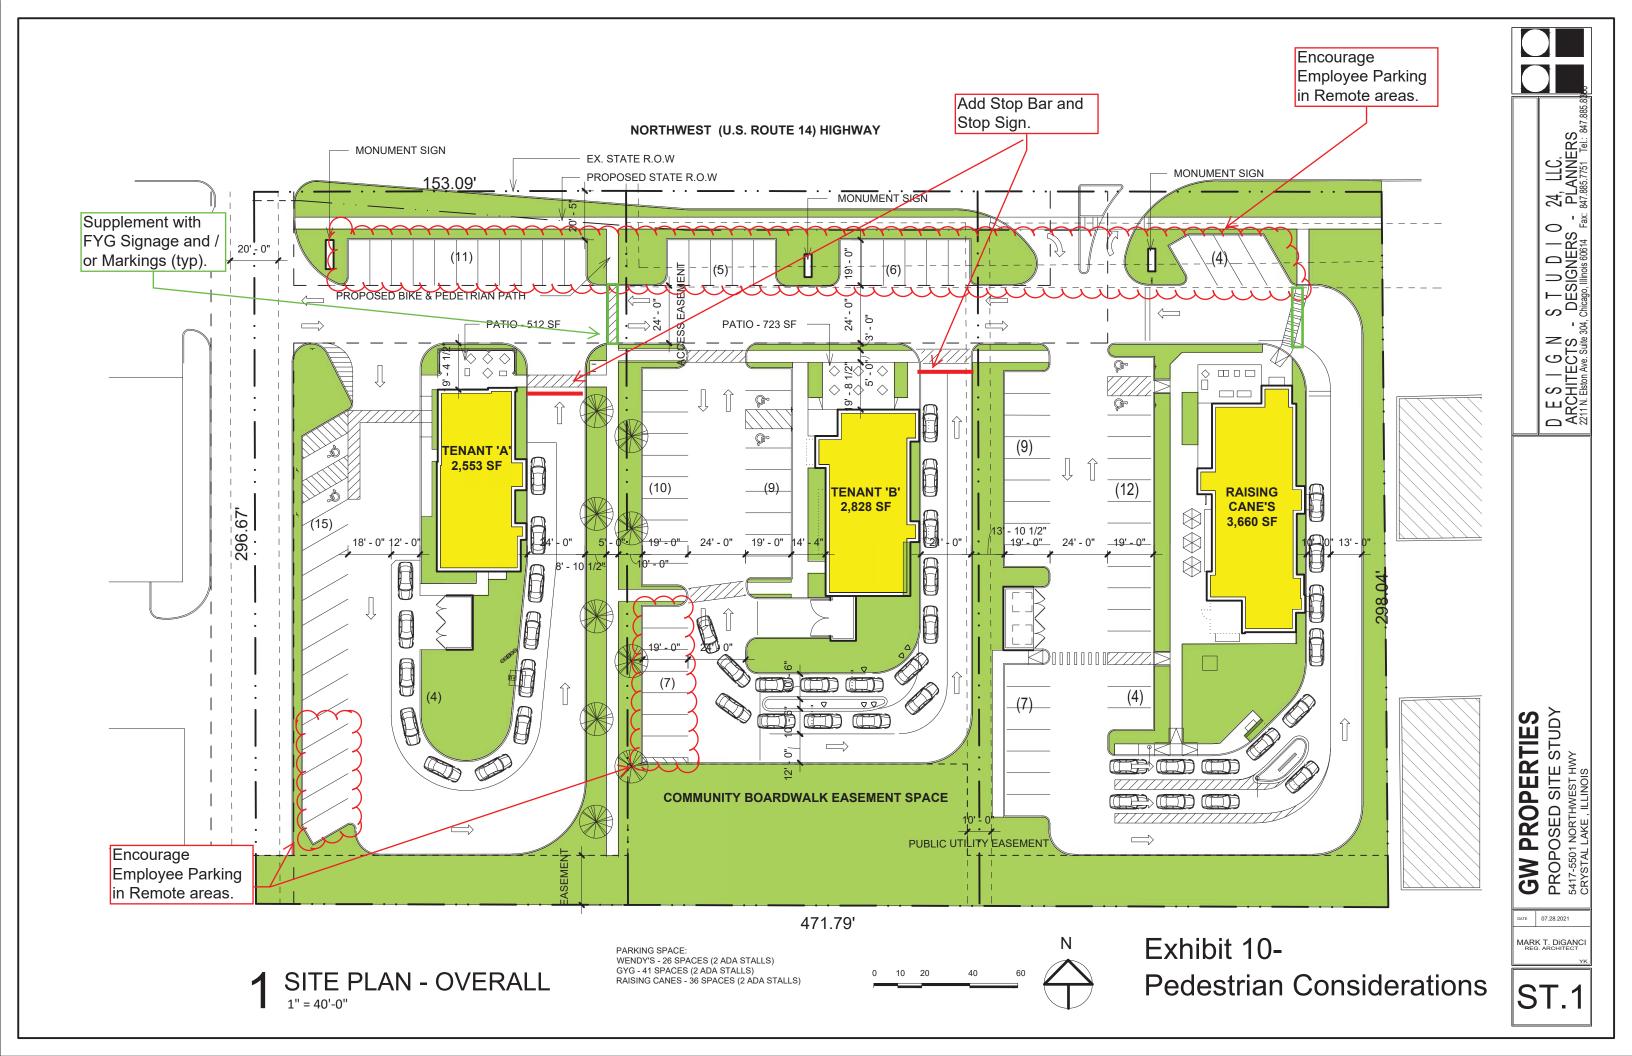

Part IV. Recommendations and Conclusions

Analyses have been conducted under existing and future conditions to determine the impact from the proposed multirestaurant development on the study area intersections. In addition to the pedestrian scale recommendations previously discussed, the capacity analysis results indicate that the increase in project site-generated traffic has little effect upon the operations of the area roadway network with the recommendations contained herein:

Under Construction - Part of Raising Canes approval

- A dedicated right-turn lane would be installed on US Route 14 at the proposed three-quarter (left-in/right-in/right-out) site access driveway.
- The painted median along the eastern site frontage on US Route 14 would be restriped as a two-way left-turn lane.

Future improvements with approval of additional Drive Throughs

- A Stop sign would be installed on the shared site access driveway, opposite Federal Drive. This site access should be widened slightly to the east to provide one inbound lane and two outbound lanes. Exiting lanes should be marked as a separate left-turn lane and a shared through/right-turn lane. The proposed threequarter site access driveway on US Route 14 should provide one inbound lane and one outbound (right-turn) lane, operating under Stop sign control.
- The development should provide for a future connection to the parcel to the east, if/when it is redeveloped with a compatible use.
- To the extent feasible, deliveries should occur during off-peak hours.
- The entrance to the Wendy's site should provide a raised "truck apron" to give the appearance of a narrower entrance drive to help limit speed of inbound vehicles while still accommodating the larger delivery vehicles needed.
- Consideration should be given to signing and marking the intersection of the shared driveway with Cassidy
 Tire and the east west circulation roadway "DO NOT BLOCK INTERSECTION" to help maintain traffic flow
 given the potential for delays exiting at that location.
- Employees should be encouraged to park in remote spaces (furthest from the site entrance or along US Route 14) to provide convenient parking for customers.
- Appropriate wayfinding signing should be provided on site to direct traffic to the various drive-throughs.

Part V. Technical Addendum

The following Appendices were previously referenced. They provide technical support for our observations, findings and recommendations discussed in the text.

Appendices

- A. Photo Inventory
- B. Traffic Count Summaries
- C. Crash Summary Map
- D. CMAP Traffic Projections
- E. July 28, 2021 Site Plan (Phases I & II)
- F. ITE Trip Generation Excerpts
- G. Capacity Analysis Worksheets
- H. Traffic Characteristics Similar Facility

GW Crystal Lake

Stormwater Management Report

5417-5501 Northwest Highway (Lot 1 of the Pauly Subdivision Doc. #2008R0052561) Crystal Lake, IL

Prepared by: Kimley-Horn and Associates, Inc. 4201 Winfield Road, Suite 600 Warrenville, IL 60555 Contact: Eric Tracey

Prepared on: 8/5/2021







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EXHIBITS

Exhibit 1 – National Wetlands Inventory Map

Exhibit 2 – FEMA Firm Map

Exhibit 3 – NRCS Soils Map

Exhibit 4 – USGS Map

Exhibit 5 – Existing Drainage Plan

Exhibit 6 – Proposed Drainage Area Map and Design Calculations



1. PROJECT NARRATIVE

Kimley-Horn and Associates, Inc., serves as the engineering consultant for GW Properties. They are proposing to construct two new buildings pads, Tenant 'A' building area is 2,553 SF and Tenant 'B' is 2,828 at 5417-5501 Northwest Highway in Crystal Lake, IL. The site is currently an abandoned used car dealership with an existing building and surface parking lot. The existing building and onsite features are to be demolished. The sitework for the building pads includes site access modifications, mass grading, building and pavement construction, and utility construction for new storm, sanitary and water services. The site is located in McHenry County and will be subject to the City of Crystal Lake and McHenry County Stormwater Management Ordinance.

1.1. Pre-Development Conditions

The proposed site for the new building pads is the western side (Lot 1) of the existing car dealership development. Lot 1 is approximately 2.06-acres in size and is a paved parking lot with 2 buildings in the existing condition. The existing site runoff mostly drains in three directions: north, east and southwest via sheet flow to the IL 14 State R.O.W., adjacent lot and to the lake as shown on the **Existing Drainage Plan** included in this report as **Exhibit 5.**

In the existing condition, the area of proposed improvements contains 1.85 acres of impervious surface and 0.21 acres of pervious surface.

Per the U.S. Fish and Wildlife Service National Wetlands Inventory, there are no wetlands or riparian environments located within the area of development or within 100 feet of the proposed development. The **National Wetlands Inventory map** is included in this report as **Exhibit 1**.

Per the FEMA Flood Insurance Rate Map, Map Number 17111C0335J, the site is located in Zone X which is defined by FEMA as an "Area determined to be outside the 0.2% annual chance floodplain". The **FEMA Flood Insurance Rate Map** is included in this report as **Exhibit 2**.

1.2. Post-Development Conditions

The proposed development will include two building pads, a drive aisle and parking island and utility services and eventually two drive through restaurants. Generally, the proposed drainage patterns match the existing drainage patterns with the flow being routed via sheet flow to proposed storm sewer inlets as well as sheet flowing to the State right-of-way, adjacent lot and lake. The portions existing storm sewer system will be removed and replaced with new storm sewer, additionally new storm sewers will tie into existing storm structures. Refer to the **Proposed Drainage Area Map** included in this report as **Exhibit 6** for additional details.

The area of proposed improvements will contain 1.43 acres of impervious surface and 0.63 acres of pervious surface. This is a decrease of impervious area by 0.42 acres from the existing condition. Refer to Section 2. Site Runoff and Section 3. Site Runoff Storage in this report for additional stormwater information



2. SITE RUNOFF

The proposed development will utilize new storm sewer pipes and inlets to route both minor and major storm events to the Route 14 right-of-way, adjacent lot and lake.

The Pre vs. Post runoff has been analyzed using HydroCAD Software Solutions LLC, which utilizes the SCS TR-20 method. 10 year and 100 year -24 hour storm Rainfall Data was obtained from the Illinois State Water Survey's Bulletin 75. A CN of 98 was assumed for impervious areas and 80 was assumed for pervious areas. A time of concentration of 10 minutes was assumed for the runoff calculations for all drainage areas. Refer to **Exhibit 6** for the **Proposed Drainage Area Map and Design Calculations.**

Drainage	Pre-Development	Post-Development				
Area	100-YR,24-HR	100-YR,24-HR				
	(cfs)	(cfs)				
Outfall 1	0.91	0.90				
Outfall 2	0.66	0.65				
Outfall 3	0.37	0.35				

3. SITE RUNOFF STORAGE

As noted above, the proposed building pads and future restaurants decrease the existing impervious area, so detention for the proposed improvements will not be required.

4. RUNOFF VOLUME REDUCTION

To achieve the runoff volume reduction requirement of the local stormwater ordinances, the proposed site plan minimizes impervious surfaces. The reduction in impervious surfaces compared to the existing conditions is previously discussed in this report. The proposed site plan maximizes green space around the building and patio areas as well as around the perimeter of the site.

National Flood Hazard Layer FIRMette


250

500

1.000

1.500



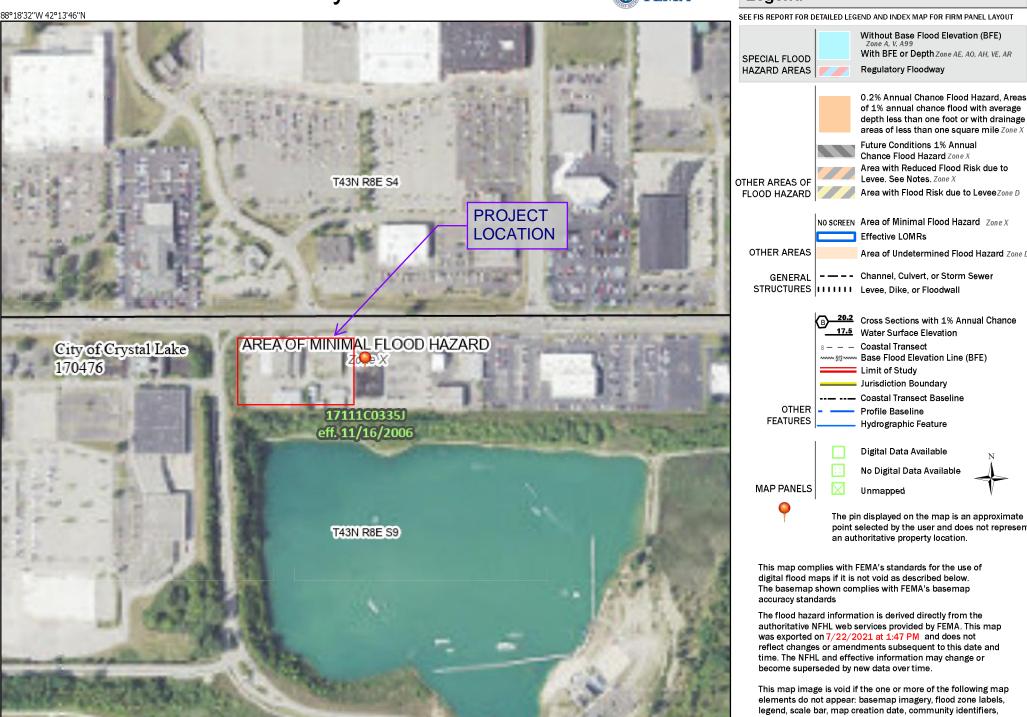

1:6.000

Basemap: USGS National Map: Orthoimagery: Data refreshed October, 2020

2.000

Legend

SEE FIS REPORT FOR DETAILED LEGEND AND INDEX MAP FOR FIRM PANEL LAYOUT

Without Base Flood Elevation (BFE) With BFE or Depth Zone AE, AO, AH, VE, AR

> of 1% annual chance flood with average depth less than one foot or with drainage areas of less than one square mile Zone X Future Conditions 1% Annual Chance Flood Hazard Zone X Area with Reduced Flood Risk due to

Area with Flood Risk due to LeveeZone D

NO SCREEN Area of Minimal Flood Hazard Zone X Area of Undetermined Flood Hazard Zone D

- - Channel, Culvert, or Storm Sewer

20.2 Cross Sections with 1% Annual Chance 17.5 Water Surface Elevation www.513 www Base Flood Elevation Line (BFE) Jurisdiction Boundary Coastal Transect Baseline

Digital Data Available No Digital Data Available

> The pin displayed on the map is an approximate point selected by the user and does not represent an authoritative property location.

This map complies with FEMA's standards for the use of digital flood maps if it is not void as described below. The basemap shown complies with FEMA's basemap

The flood hazard information is derived directly from the authoritative NFHL web services provided by FEMA. This map was exported on 7/22/2021 at 1:47 PM and does not reflect changes or amendments subsequent to this date and time. The NFHL and effective information may change or

This map image is void if the one or more of the following map elements do not appear: basemap imagery, flood zone labels, legend, scale bar, map creation date, community identifiers, FIRM panel number, and FIRM effective date. Map images for unmapped and unmodernized areas cannot be used for regulatory purposes.

